
ATTENTION EXCAVATORS


OREGON LAWN REQUIRES YOU TO FOLLOW RULES ADOPTED BY THE OREGON NOTIFICATION CENTER. THOSE RULES ARE SET FORTH IN OAR 952-001-0010 THROUGH OAR 952-001-0090. YOU MAY OBTAIN COPIES OF THESE RULES FROM THE CENTER BY CALLING 503-232-1987. IF YOU HAVE ANY QUESTIONS ABOUT THE RULES YOU MAY CONTACT THE CENTER. YOU MUST NOTIFY THE CENTER AT LEAST TWO BUSINESS DAYS BEFORE COMMENCING AN EXCAVATION. CALL 503-246-6699.

SUNSET HIGH SCHOOL STADIUM SITE IMPROVEMENTS PROJECT BEAVERTON SCHOOL DISTRICT



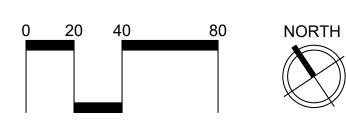

BUGBEY & ASSOCIATES

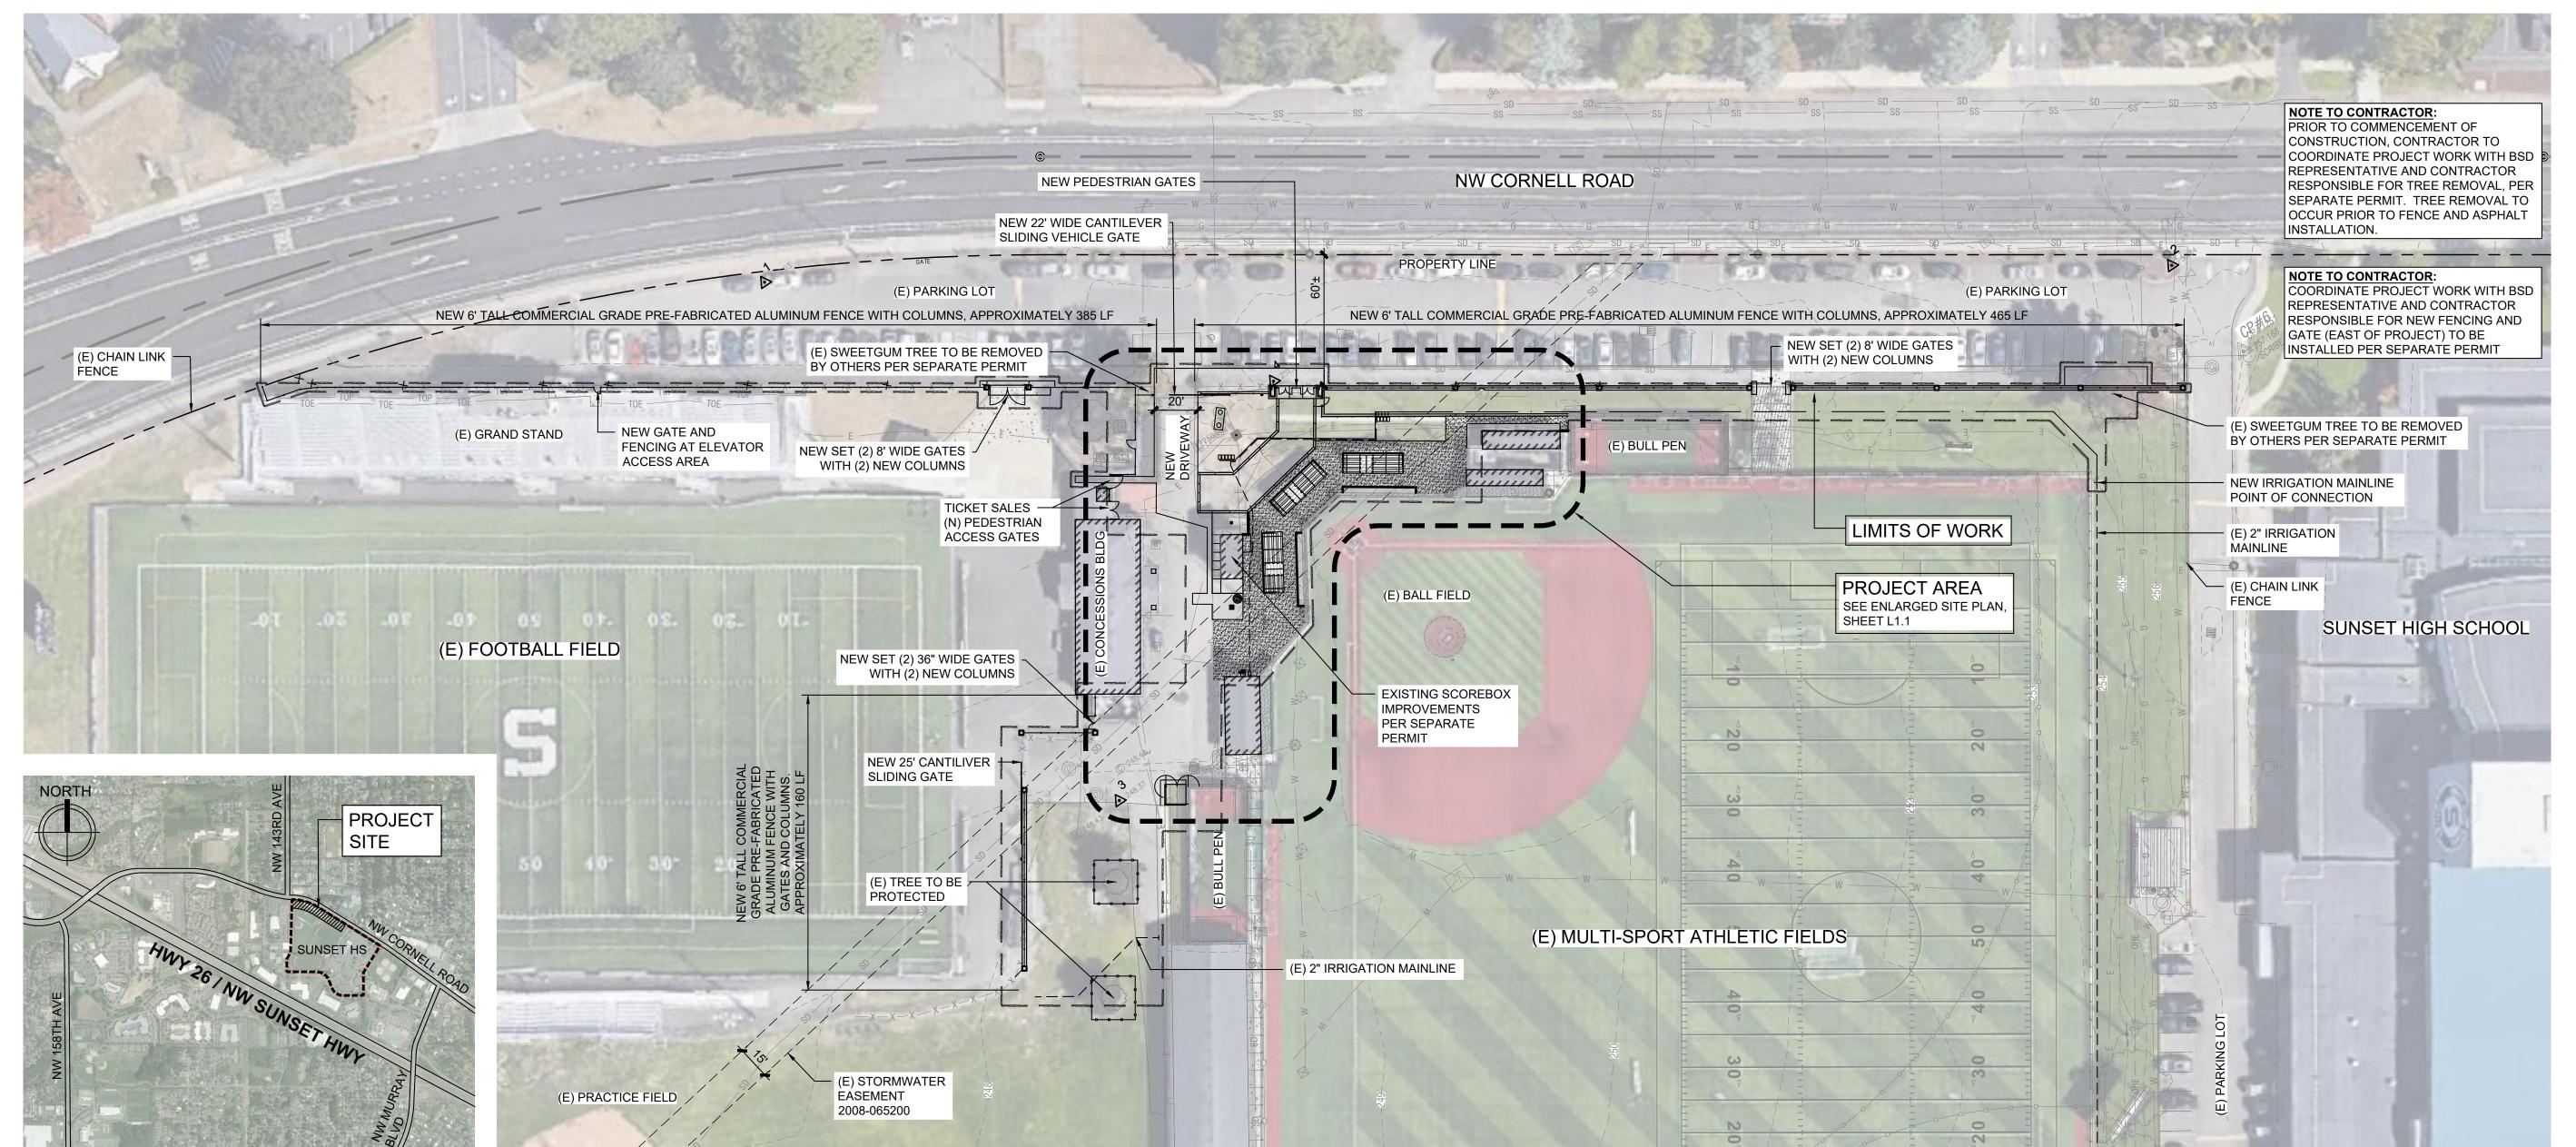

VICINITY MAP NTS

OVERALL SITE PLAN SCALE: 1" = 40'

C1.1

C1.2

ELECTRICAL

PLUMBING

STRUCTURAL

PROJECT TEAM

OWNER

BEAVERTON SCHOOL DISTRICT 16550 SOUTHWEST MERLO ROAD BEAVERTON, OR 97006 PH: 503-356-4433 CONTACT: DOAA ELHAGGAN, PROJECT MANAGER

LANDSCAPE ARCHITECT

BUGBEY & ASSOCIATES, LLC

88685 FAULHABER ROAD ELMIRA, OR 97437 PH: 541-654-1513 CONTACT: SPENCER BUGBEY, RLA

CIVIL ENGINEER

JANET TURNER ENGINEERING, LLC 16869 65TH AVE, #194 LAKE OSWEGO, OR 97035 PH: 541-510-0878 CONTACT: JANET TURNER, P.E.

SURVEY

MONTOYA LAND SURVEYING, LLC PO BOX 250 BROWNSVILLE, OR 97327 PH: 541-221-2427 CONTACT: JAMEY MONTOYA, PLS

ELECTRICAL

EVANS ENGINEERING & CONSULTING, LLC 17675 SW FARMINGTON ROAD ALOHA, OR 97007 PH: 503-258-7630 CONTACT: CHARLES EVANS, P.E.

CONTACT: SHANE FITZPATRICK

PLUMBING

COMMERCIAL PLUMBING CONSULTING & DESIGN, LLC 18840 SW BOONES FERRY RD. #310 TUALATIN, OR 97062 PH: 503-843-8233 X 1001

STRUCTURAL

SUMMIT ENGINEERING, LLC PO BOX 50322 EUGENE, OR 97405 PH: 503-734-6633 CONTACT: JULIE HAVELKA, P.E.

SHEET LIST

SITE / LANDSCAPE

G0.0 COVER SHEET

G0.1 CONSTRUCTION ACCESS & STAGING PLAN
L1.0 ENLARGED SITE PLAN
L2.0 HORIZONTAL CONTROL PLAN

L2.1 FENCE LAYOUT PLAN
L3.0 GRADING PLAN
L4.0 PLANTING PLAN
L4.1 PLANTING DETAILS & NOTES
L5.0 LANDSCAPE DETAILS

LANDSCAPE DETAILS LANDSCAPE DETAILS LANDSCAPE DETAILS

CIVIL

C0.0 EROSION AND SEDIMENT
CONTROL COVER SHEET

C0.1 CLEARING AND DEMOLITION
EROSION AND SEDIMENT CONTROL PLAN

.2 GRADING AND UTILITY CONSTRUCTION
EROSION AND SEDIMENT CONTROL PLAN
EROSION AND SEDIMENT CONTROL DETAILS

PROJECT INFORMATION

COMPOSITE UTILITY PLAN

CIVIL GENERAL NOTES AND DETAILS

LEGEND AND GENERAL NOTES

DESIGN SHEET SPECIFICATIONS

STORM DRAIN PLAN

SITE PLAN - PLUMBING

STRUCTURAL PLAN

STRUCTURAL PLAN

STRUCTURAL PLAN

STRUCTURAL DETAILS

STAIR PLAN AND ELEVATIONS

SITE PLAN

ADDRESS
SUNSET HIGH SCHOOL
13840 NW CORNELL ROAD
BEAVERTON, OR 97229

COUNTY

WASHINGTON COUNTY, OREGON

ASSESSOR'S MAP AND TAX LOT: 1N1 33BC 01300

ZONING

OI - OFFICE INDUSTRIAL

DATE
PROJECT NO.
CAD DWG FILE
DRAWN BY
CHECKED BY

COVER SHEET

02/18/2020

SBB, KHW

SUNSET HS - CD.DWG

7839

DATE

03/10/2020

CONSTRUCTION DRAWINGS


PERMIT AND BIDDING SET

DESCRIPTION

1 BSD COMMENTS

SCALE: 1 INCH = 40 FEET

G0.0

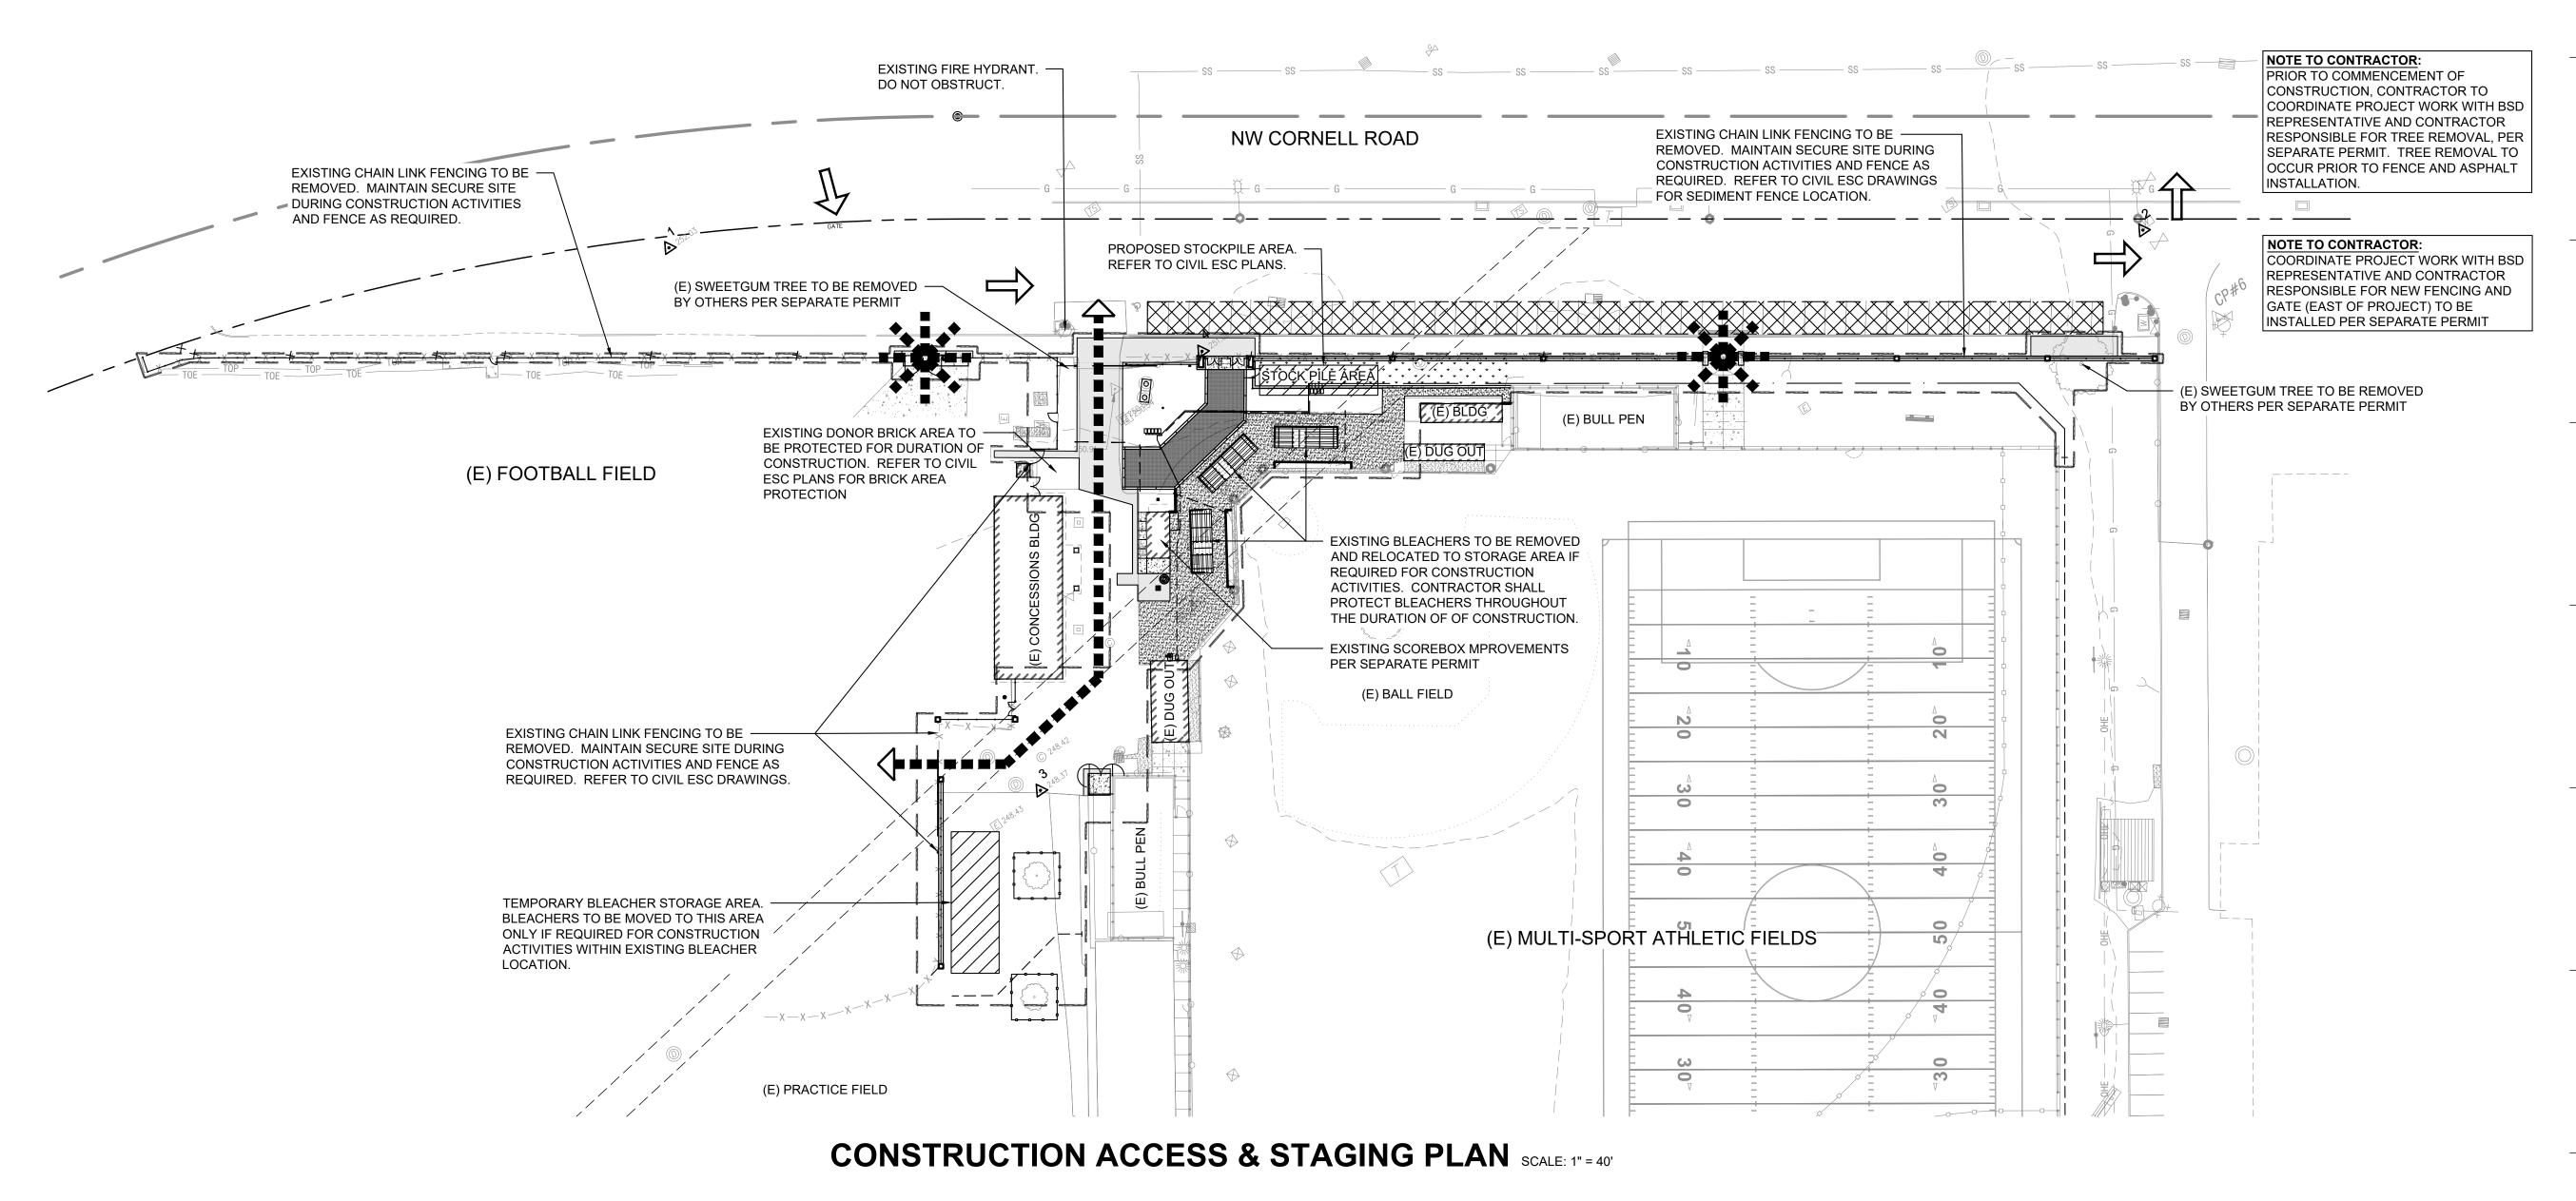

TREE PROTECTION NOTES


- 1. PROTECT THE CRITICAL ROOT ZONE (AND AREA DIRECTLY BELOW THE DRIPLINE) OF THE TREES TO REMAIN ON SITE:
- 1.1. CONSTRUCT TEMPORARY FENCING AROUND THE CRITICAL ROOT ZONE OF THE TREE TO BE PROTECTED PRIOR TO DEMOLITION, CONSTRUCTION, OR ANY OTHER SITE WORK.
- 1.2. DO NOT ALLOW COMPACTION BY EQUIPMENT TRAFFIC DURING CONSTRUCTION OR DEMOLITION.
- WITHIN THE TREE PROTECTION AREA. 1.4. WATERING WITHIN THE CRITICAL ROOT ZONE FROM MID-APRIL TO MID-OCTOBER AT THE RATE OF NOT

1.3. DO NOT STOCKPILE MATERIALS, DEBRIS, OR DIRT

- LESS THAN THE EQUIVALENT OF 1-1/2" OF WATER OVER THE ENTIRE AREA PER WEEK. 1.5. DO NOT TRENCH, EXCAVATE, FILL OR OTHERWISE DISTURB THE SOIL WITHIN THE CRITICAL ROOT
- 1.6. ADJUST NEW IMPROVEMENT LOCATIONS AS REQUIRED TO AVOID DAMAGING TREE ROOTS. NOTIFY LANDSCAPE ARCHITECT OF ANY CONFLICTS.
- 2. PROTECT THE CROWN AND TRUNK OF TREES TO
- 2.1. AVOID CONTACT WITH TREE TRUNKS AND BRANCHES WHEN OPERATING EQUIPMENT
- 2.2. PRUNING OF BRANCHES GREATER THAN 1" TO BE PROVIDED BY LICENSED ARBORIST.

STAGING LEGEND

PROJECT LIMITS

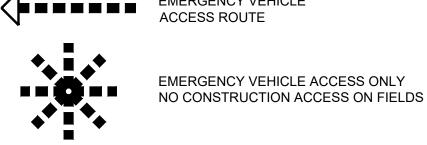

EMERGENCY VEHICLE

CONSTRUCTION ACCESS ROUTE





MATERIALS STOCK PILE AND STORAGE AREA



CONSTRUCTION PERSONNEL PARKING

SHEET NOTES

- 1. LIMITS OF WORK, STAGING AREAS AND STOCK PILE AREAS SHOWN ON PLAN ARE APPROXIMATE.
- 2. REFER TO CIVIL EROSION AND SEDIMENT CONTROL (ESC) DRAWINGS FOR LOCATION CONSTRUCTION OF ROCK CONSTRUCTION ENTRANCE, SEDIMENT FENCING, TREE PROTECTION, INLET PROTECTION AND OTHER BMP'S. COORDINATE FINAL CONSTRUCTION STAGING WITH BEAVERTON SCHOOL DISTRICT (BSD) REPRESENTATIVE. ENSURE EROSION CONTROL MEASURES PROTECT SYNTHETIC TURF AT STOCKPILE AREAS.
- 3. COORDINATE FIELD ACCESS WITH BSD FOR THE DURATION OF CONSTRUCTION. ADJUST FENCE LAYOUT AS REQUIRED. MAINTAIN ACCESS TO ALL SPORTS FACILITIES FOR SCHOOL RELATED SPORT ACTIVITIES. NO CONTRACTOR ACCESS ALLOWED ON SYNTHETIC TURF, EXCEPT BY OWNER PERMISSION ONLY.
- 4. FULLY SECURE BSD SITE WITH TEMPORARY FENCING WHERE EXISTING FENCING IS REMOVED. FULLY SECURE WORK ZONE WITH FENCING. STAGING AREAS, CONTRACTOR EQUIPMENT AND WORK AREAS TO BE FENCED AND SECURED AT ALL TIMES. PROVIDE VEHICLE AND PERSON GATES AS REQUIRED FOR CONSTRUCTION. COORDINATE KEYED LOCKS WITH BSD.
- 5. MAINTAIN UNOBSTRUCTED ACCESS FOR STUDENTS AND PEDESTRIANS AT ALL TIMES ALONG EXISTING PEDESTRIAN ROUTES. WHEREAS PROJECT WORK REQUIRES ACTIVITY IN A PEDESTRIAN ROUTE, PROVIDE CLEARLY DENOTED ALTERNATIVE ROUTES SEPARATED FROM VEHICULAR ACTIVITY.

- 6. MAINTAIN EMERGENCY VEHICLE ACCESS THROUGHOUT THE DURATION OF CONSTRUCTION. MAINTAIN FIRE LANE ACCESS AT ALL TIMES.
- 7. REFER TO SPECIFICATIONS FOR PROJECT SIGNAGE.
- 8. ALL EXISTING BUILDINGS ARE TO REMAIN.
- 9. MAINTAIN FIELD LIGHTING AND PEDESTRIAN LIGHTING AT ALL TIMES, OR PROVIDE TEMPORARY LIGHTING AS REQUIRED.
- 10. PROTECT EXISTING SURFACES AT CONSTRUCTION ENTRANCES AND REPAIR ANY DAMAGED SURFACES TO PRE-EXISTING CONDITION OR BETTER.
- 11. PARKING LOT ADJACENT TO CORNELL ROAD IS INTENDED FOR CONTRACTOR USE. CLEAN DIRT AND DEBRIS GENERATED FROM CONSTRUCTION WORK.
- 12. AT ALL STAGING AND STOCKPILE AREAS ON NON-PAVED SURFACES INSTALL GEOTEXTILE FABRIC AND 6 INCH MINIMUM OF CRUSHED ROCK FOR STABILIZED WORK AREA. CONTRACTOR IS RESPONSIBLE TO RESTORE AREAS IMPACTED DURING CONSTRUCTION TO PRE-CONSTRUCTION CONDITIONS. REFER TO CIVIL ESC PLANS FOR ADDITIONAL MEASURES.

BUGBEY & ASSOCIATES LANDSCAPE ARCHITECTURE

88685 Faulhaber Rd Elmira, OR 97437 541-654-1513 bugbeyla@gmail.com



ST ST 130

CONSTRUCTION DRAWINGS PERMIT AND BIDDING SET

	ISSUE					
	#	DESCRIPTI	ON	DATE		
	1	BSD COMM	IENTS	03/10/2020		
	DATE PROJECT NO. CAD DWG FILE		02/18/2020			
			7839			
			SUNSET HS - CD.DWG			
	DRAW	N BY	SBB, KHW			
	CHEC	KED BY	SBB			


CONSTRUCTION ACCESS & **STAGING** PLAN

SCALE: 1 INCH = 40 FEET

SHEET:


NORTH

20

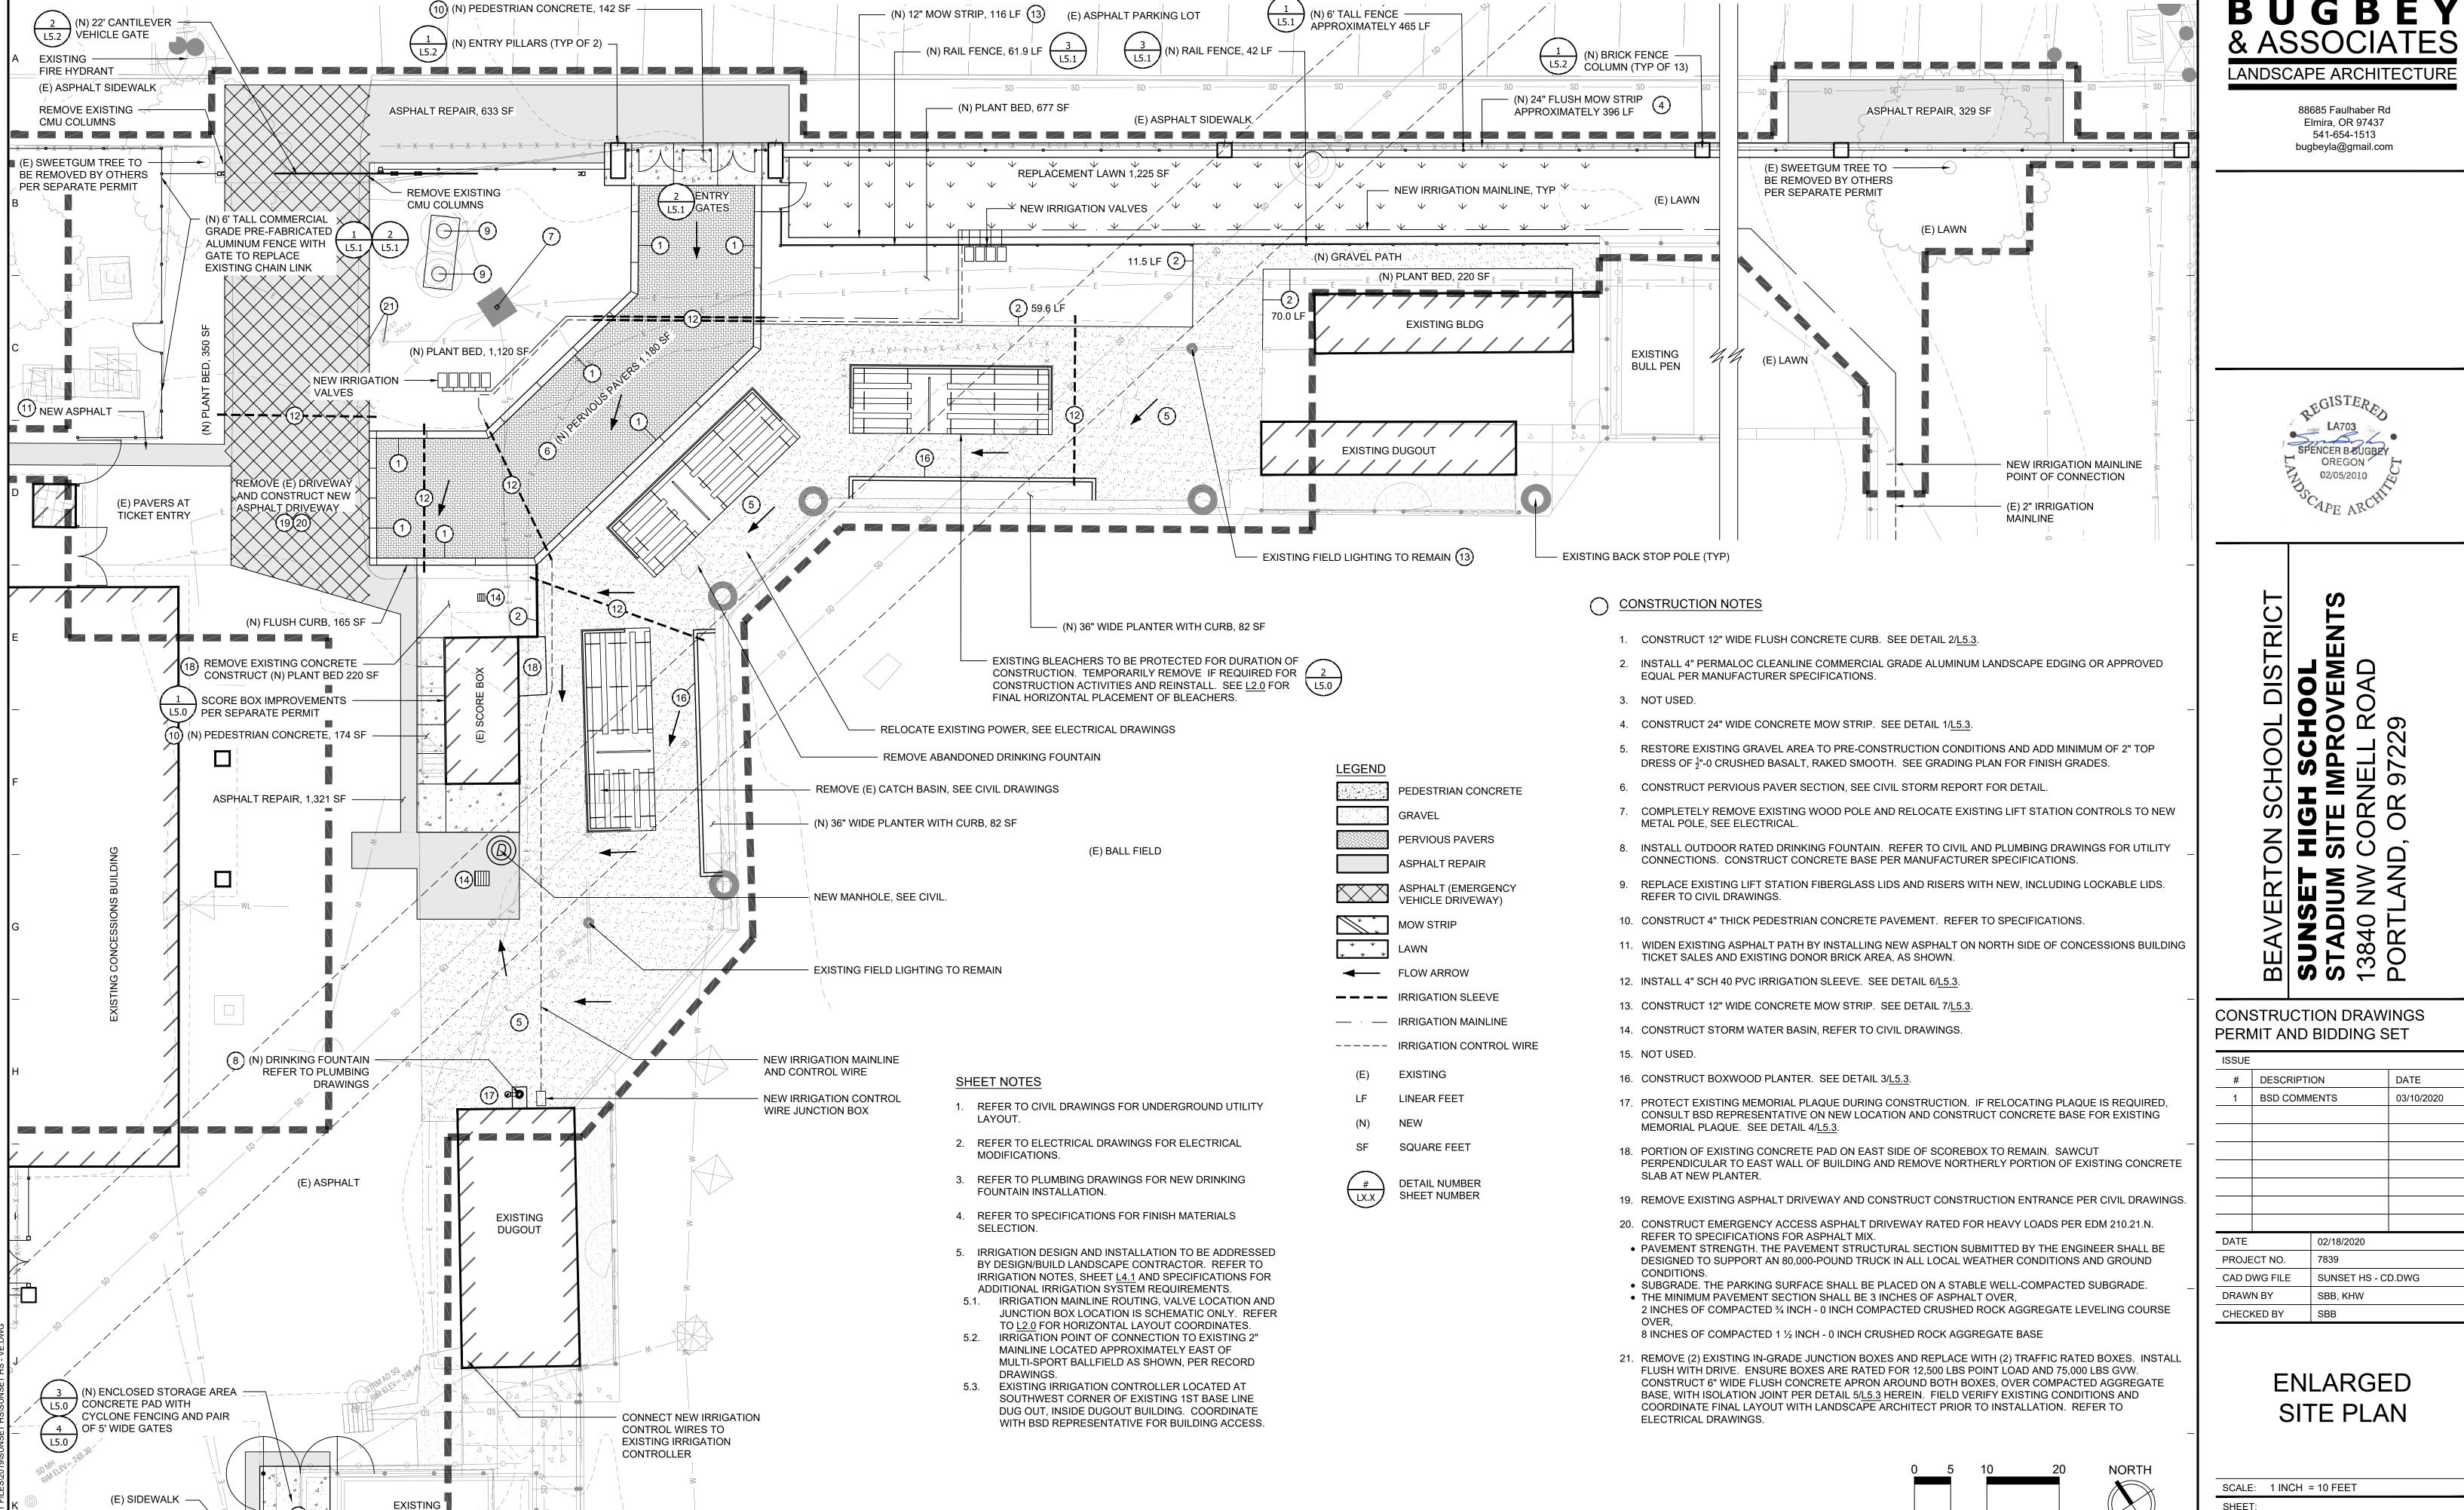

ENLARGED SITE PLAN SCALE: 1" = 10'

BULL PEN

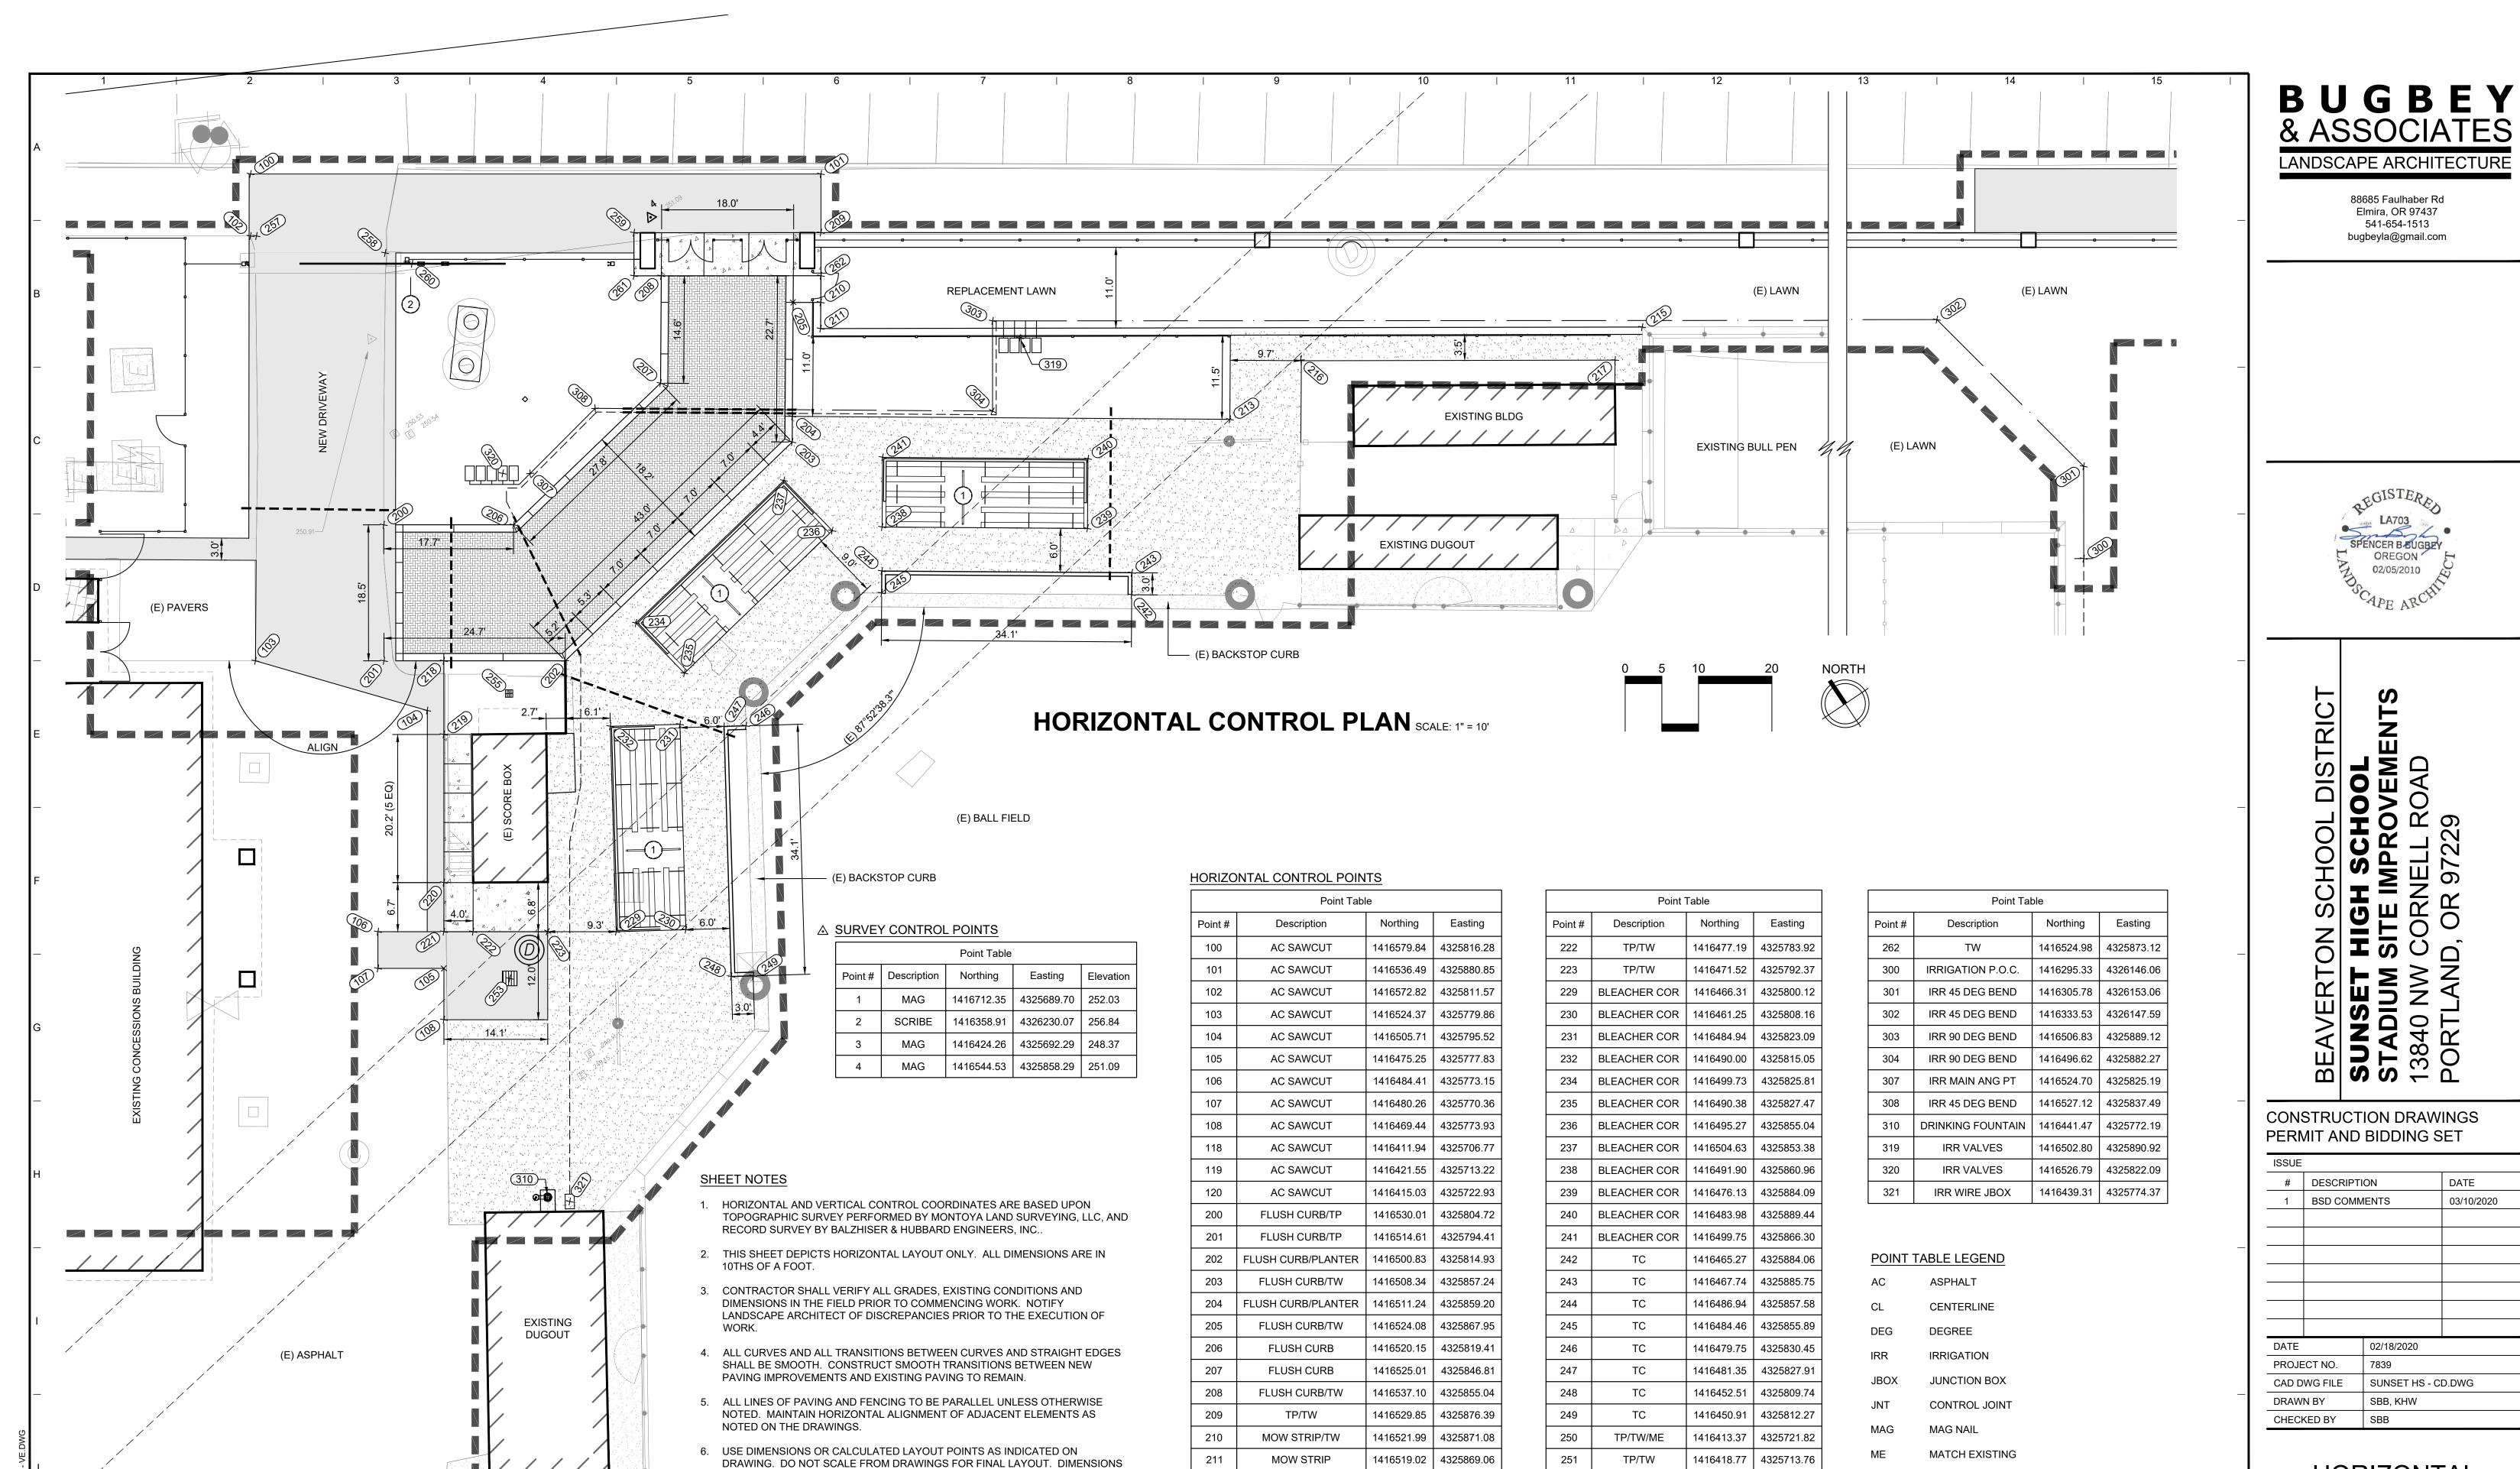

213

215

216

217

218

219

220

PLANTER/GRAVEL

MOW STRIP

PLANTER/GRAVEL

PLANTER/GRAVEL

FLUSH CURB/TP

TP/TW

TP/TW

TP/TW

1416477.66 | 4325908.49

1416478.97 | 4325921.04

1416455.10 | 4325956.59

1416510.06 | 4325801.18

1416501.72 | 4325795.59

1416484.96 | 4325784.35

1416479.40 | 4325780.62

4325962.17

1416456.77

252

253

255

257

258

259

260

261

TP/TW

CATCH BASIN

AREA DRAIN

TP

TP

TP/TW

CL GATE PAD

1416410.89 | 4325708.47

1416544.06 | 4325855.23

1416557.40 | 4325827.76

1416539.18 | 4325851.95

4325784.5

4325806.09

4325812.25

4325825.53

1416469.11

1416501.40

1416572.37

1416560.67

TAKE PRECEDENCE OVER SCALES SHOWN ON DRAWINGS.

ARCHITECT OF ANY UTILITY CONFLICTS OR DISCREPANCIES.

1. ADJUST EXISTING BLEACHER LOCATION AS SHOWN. BLEACHERS TO

2. REFER TO MANUFACTURER DRAWINGS AND SPECIFICATIONS FOR

CANTILEVER GATE FOOTING DIMENSIONS AND CONFIGURATION (TYP).

CONSTRUCTION NOTES

PARALLEL EXISTING BACKSTOP CURB.

8. VERIFY LOCATION OF ALL EXISTING UTILITIES AND STRUCTURES. REFER TO

CIVIL DRAWINGS FOR UNDERGROUND UTILITY LAYOUT. NOTIFY LANDSCAPE

SBB, KHW CHECKED BY SBB **HORIZONTAL**

02/18/2020

SUNSET HS - CD.DWG

7839

SUNSET SUNSET STADIUM 13840 NW PORTLANI

DATE

03/10/2020

88685 Faulhaber Rd Elmira, OR 97437 541-654-1513 bugbeyla@gmail.com

CONTROL


SCALE: 1 INCH = 10 FEET

POINT OF CONNECTION

TOP OF PAVEMENT

TOP OF WALK

TOP OF CURB

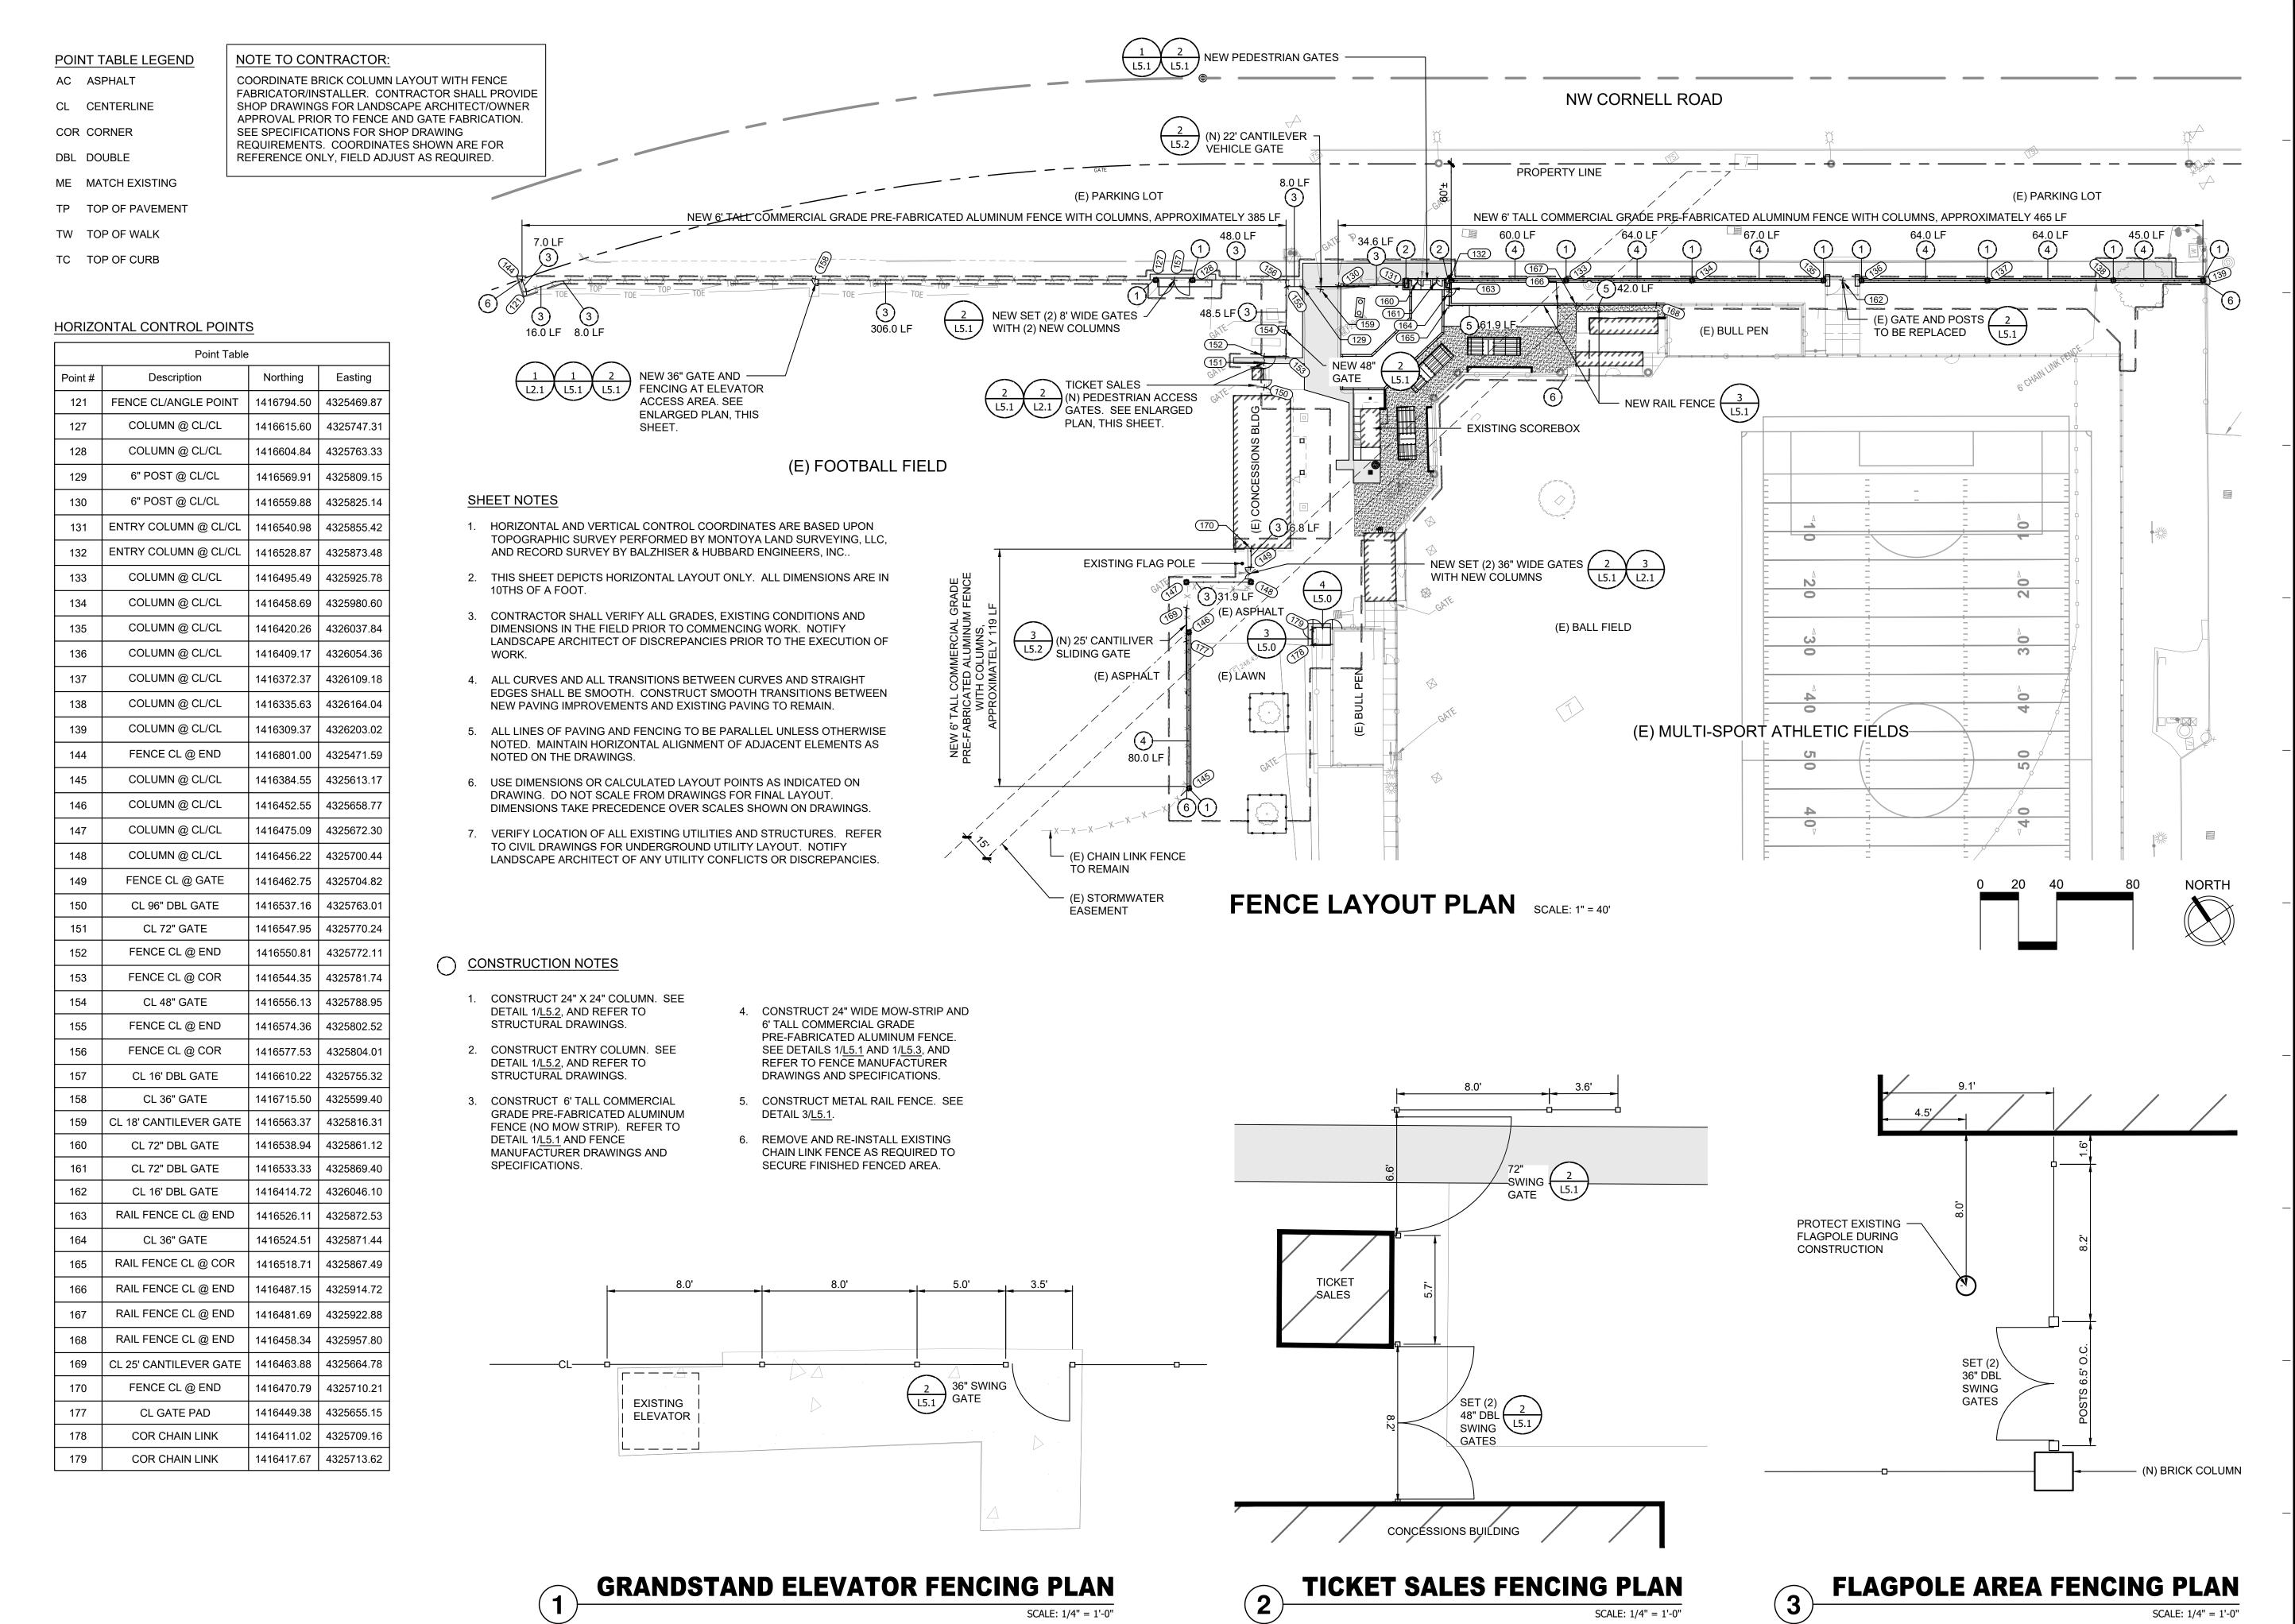

& ASSOCIATES

LANDSCAPE ARCHITECTURE

88685 Faulhaber Rd Elmira, OR 97437 541-654-1513 bugbeyla@gmail.com

SPENCER BEUGBEY
OREGON
02/05/2010

SUNSET HIGH SCHOOL DISTRIC SUNSET HIGH SCHOOL STADIUM SITE IMPROVEMENT 13840 NW CORNELL ROAD PORTLAND, OR 97229


CONSTRUCTION DRAWINGS
PERMIT AND RIDDING SET

PERI	/III AND	RIDDING S) <u> </u>	
ISSUE				
#	DESCRIPTI	ON	DATE	
1	BSD COMM	1ENTS	03/10/2020	
DATE PROJECT NO. CAD DWG FILE DRAWN BY		02/18/2020		
		7839 SUNSET HS - CD.DWG		
				SBB, KHW
		CHEC	KED BY	SBB

FENCE LAYOUT PLAN

SCALE: VARIES


L2.1

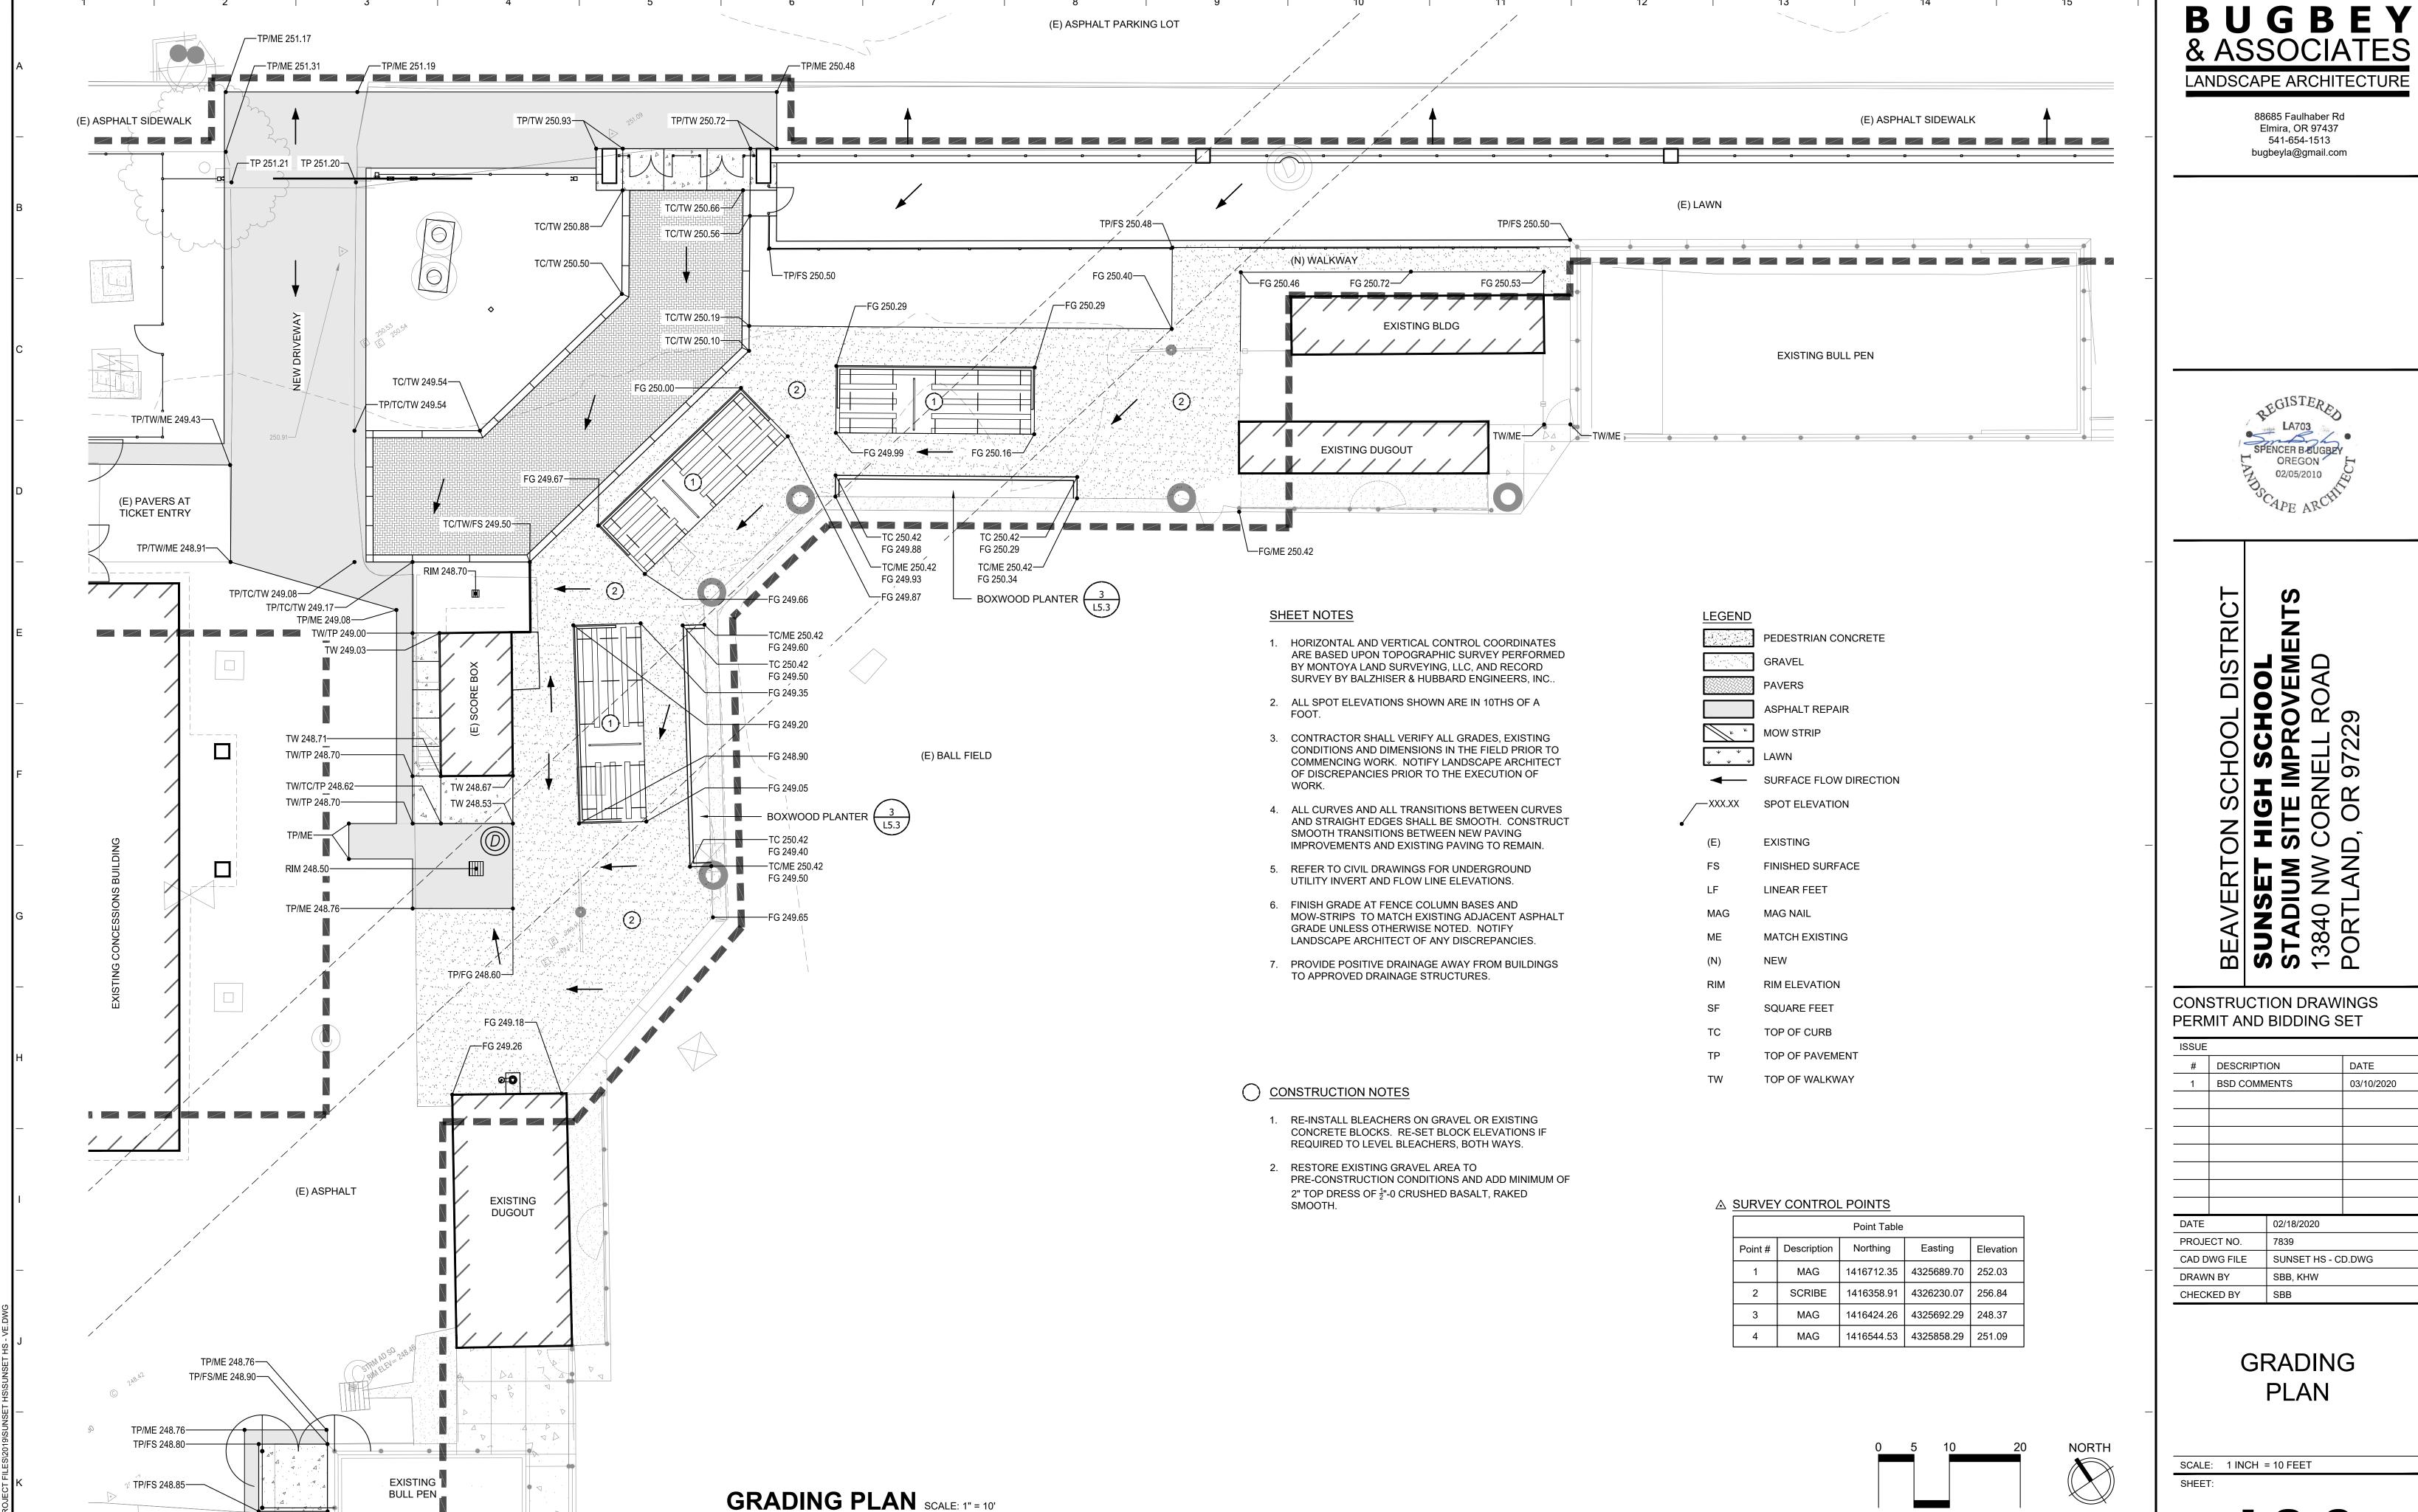

(E) SIDEWALK ——

ISSUE					
#	DESCRIPTI	ON	DATE		
1	BSD COMM	IENTS	03/10/2020		
DATE		02/18/2020			
PROJECT NO.		7839			
CAD D	WG FILE	SUNSET HS - CD.DWG			

L3.0

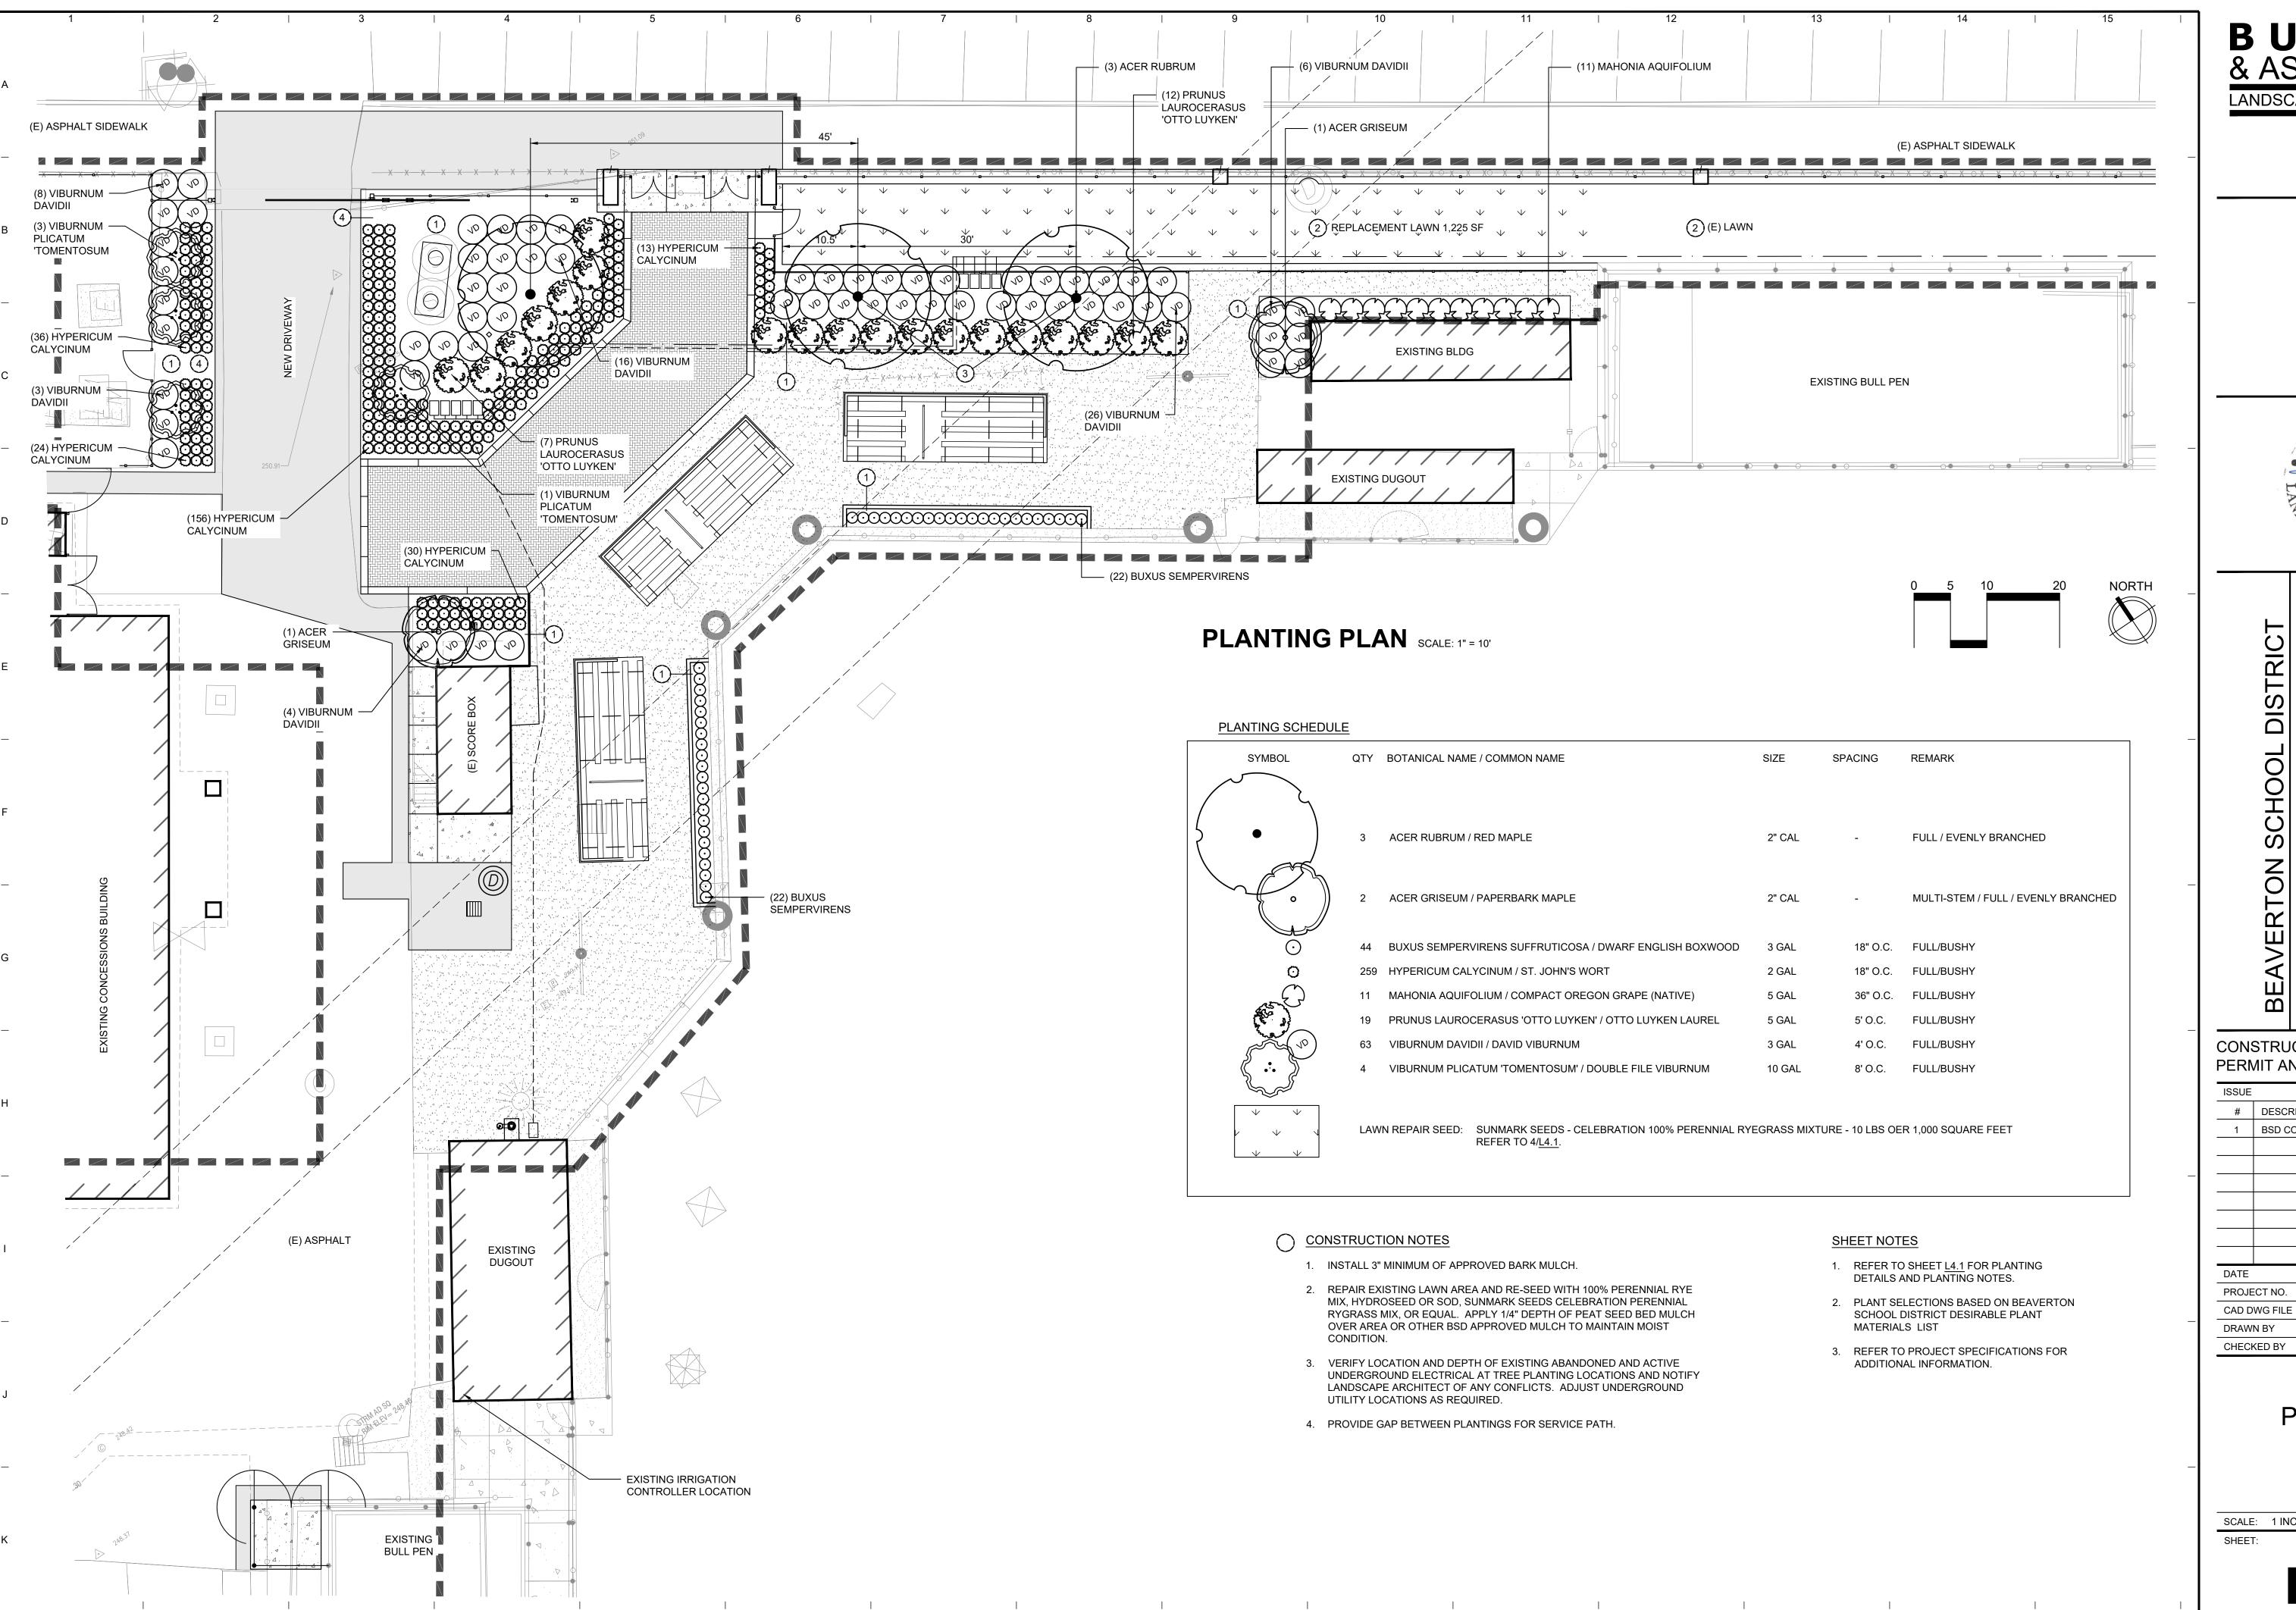

BUGBEY & ASSOCIATES LANDSCAPE ARCHITECTURE

> 88685 Faulhaber Rd Elmira, OR 97437 541-654-1513 bugbeyla@gmail.com



CONSTRUCTION DRAWINGS PERMIT AND BIDDING SET

	1330E					
	#	DESCRIPTI	ON	DATE		
	1	BSD COMM	IENTS	03/10/2020		
	DATE PROJECT NO.					
			02/18/2020 7839			
	CAD D	WG FILE	SUNSET HS - C	D.DWG		
1						

PLANTING **PLAN**

SBB, KHW

SBB

SCALE: 1 INCH = 10 FEET

1. SET TREE STAKES ONLY IF TREE IS UNSTABLE OR WINDY CONDITIONS EXIST. THE STAKING OF TREES IS TO BE THE CONTRACTOR'S OPTION HOWEVER, THE CONTRACTOR IS RESPONSIBLE TO INSURE THAT ALL TREES ARE PLANTED STRAIGHT AND THAT THEY REMAIN STRAIGHT FOR LENGTH OF WARRANTY PERIOD OR 1 YEAR AFTER SUBSTANTIAL COMPLETION WHICHEVER IS GREATER. REMOVE ALL STAKING AS SOON AS THE TREE HAS GROWN SUFFICIENT ROOTS TO OVERCOME THE PROBLEM THAT REQUIRED THE TREE TO BE STAKED. ALL STAKING SHALL BE REMOVED NO LATER THAN THE END OF FIRST GROWING SEASON. STAKING TO BE APPROVED BY LANDSCAPE ARCHITECT.

2. LANDSCAPE CONTRACTOR SHALL NOTIFY LANDSCAPE ARCHITECT AND OWNER PRIOR TO INSTALLATION OF PLANT

3. BEFORE ANY EXCAVATION CALL DIG SAFELY OREGON 1-800-332-2344 OR 811 TO LOCATE UNDERGROUND UTILITIES. NOTIFY LANDSCAPE ARCHITECT OF ANY CONFLICTS WITH PROPOSED OR EXISTING UNDERGROUND UTILITIES.

CAREFULLY REMOVE CONTAINERS, WRAPPINGS, WIRES AND TIES FROM ROOTBALL BEFORE PLANTING.

LOOSEN OUTSIDE ROOTS, AND UNWRAP ANY CIRCLING ROOTS ADD COMMERCIAL SLOW RELEASE FERTILIZER TABLETS TO BACKFILL AT 6" DEPTH.

. ALL STAKES SHALL BE DRIVEN OUTSIDE EDGE OF ROOTBALL. SET STAKES PARALLEL TO PREVAILING WIND.

WATER TREE TWICE WITHIN THE FIRST 24 HOURS FOLLOWING PLANTING.

9. FOR TREES LOCATED WITHIN ROADSIDE PLANTERS LESS THAN 6'-0" IN WIDTH, PROVIDE TREE ROOT BARRIER. LOCATE BARRIER BACK OF CURB AND EDGE OF SIDEWALK. ALL TREE INSTALLATIONS SHALL CONFORM TO ALL AGENCY APPROVAL REQUIREMENTS. CONTRACTOR SHALL VERIFY PRIOR TO ANY INSTALLATIONS.




NOT TO SCALE

IRRIGATION NOTES

- 1. IRRIGATION DESIGN AND INSTALLATION TO BE ADDRESSED BY DESIGN/BUILD LANDSCAPE CONTRACTOR. ALL LANDSCAPE BEDS AND LAWN AREAS TO HAVE DOUBLE COVERAGE SPRAY IRRIGATION OR OTHER APPROVED SYSTEM. REFER TO SPECIFICATIONS FOR ADDITIONAL IRRIGATION SYSTEM REQUIREMENTS.
- 2. RE-USE EXISTING IRRIGATION CONTROLLER LOCATED AT SOUTHWEST CORNER OF 1ST BASE DUGOUT, OR AS DIRECTED BY BSD REPRESENTATIVE. COORDINATE BUILDING ACCESS WITH BSD REPRESENTATIVE. UPGRADE CONTROLLER AS REQUIRED.
- VERIFY MAINLINE POINT OF CONNECTION AND BACK FLOW PREVENTION WITH BSD REPRESENTATIVE AND NOTIFY LANDSCAPE ARCHITECT OF LOCATIONS.
- 4. ALL NEW LANDSCAPE AREAS TO BE IRRIGATED WITH A FULLY AUTOMATIC UNDERGROUND IRRIGATION SYSTEM. DRIP, SPRAY OR ROTOR ZONES AS NOTED ON PLANS HEREIN.
- IRRIGATION VALVE SHALL BE WINTERIZED THROUGH LOW PRESSURE.
- 6. VALVES SHALL BE WIRED AND INSTALLED PER MANUFACTURER'S RECOMMENDED INSTALLATION PROCEDURES AND CONNECTED TO THE IRRIGATION CONTROLLER.
- 7. IRRIGATION SYSTEM SHALL BE DESIGN-BUILD AND INSTALLED AND SHALL PERFORM WITHIN THE TOLERANCES AND SPECIFICATIONS OF THE SPECIFIED MANUFACTURERS EQUIPMENT AND INDUSTRY STANDARDS. IRRIGATION DESIGN TO BE SUBMITTED BY CONTRACTOR FOR REVIEW AND APPROVAL TO BUGBEY & ASSOCIATES, LLC (TEN) BUSINESS DAYS OR MORE PRIOR TO INSTALLATION.


- ALL IRRIGATION PIPE MATERIAL AND INSTALLATION SHALL CONFORM TO APPLICABLE CODE FOR PIPING AND COMPONENT REQUIREMENTS.
- 9. SYSTEM SHALL BE DESIGNED TO SUPPLY MANUFACTURER'S SPECIFIED MINIMUM OPERATING PRESSURE TO FARTHEST EMITTER FROM WATER METER.
- 10. ALL IRRIGATION HEAD TYPES TO BE APPROVED BY BEAVERTON SCHOOL DISTRICT FACILITIES STAFF.
- 11. ALL VALVES TO BE RAIN-BIRD IRRIGATION VALVES. INSTALL ALL VALVES IN JUMBO BOXES (NO ROUND 6" OR 10").
- 12. CONSTRUCT ISOLATION VALVES AND DRAINS ADJACENT TO ELECTRICAL VALVE OR BACKFLOW VALVE BOXES, SPACED NO GREATER THAN 2 FEET APART.
- 13. INSTALL MAIN AND LATERAL DRAINS AS NEEDED PER DESIGN-BUILD LAYOUT. RELOCATE EXISTING IRRIGATION MAINLINE AND CONTROL WIRES AS REQUIRED. USE EXISTING MAINLINE LOCATION WHEN POSSIBLE. ADJUSTMENTS TO THE EXISTING MAINLINE LAYOUT TO BE APPROVED BY BSD REPRESENTATIVE, AND AS-BUILT LOCATIONS DOCUMENTED ON PLANS TO BE SUBMITTED TO BEAVERTON SCHOOL DISTRICT.
- 14. INSTALL TRACER WIRE WITH ALL VALVES, MAINLINE AND

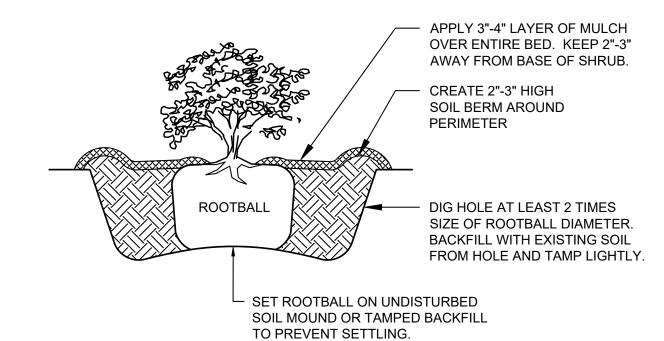

- 1. CAREFULLY REMOVE CONTAINERS, WRAPPINGS, WIRES AND TIES FROM ROOTBALL BEFORE PLANTING.
- 2. LOOSEN OUTSIDE ROOTS, AND UNWRAP ANY CIRCLING ROOTS.
- 3. ADD COMMERCIAL SLOW RELEASE FERTILIZER TABLETS TO BACKFILL AT 6" DEPTH.

SHRUB PLANTING


NOT TO SCALE

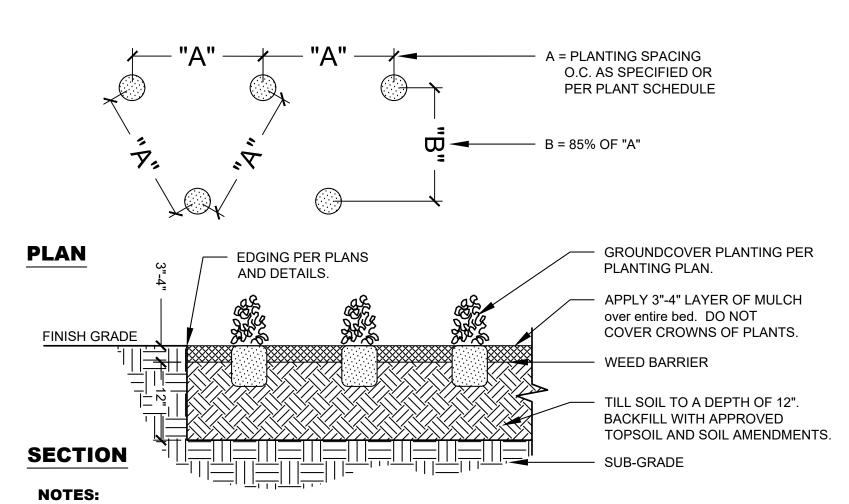

- CAREFULLY REMOVE CONTAINERS, WRAPPINGS, WIRES AND TIES FROM ROOTBALL BEFORE PLANTING
- 2. LOOSEN OUTSIDE ROOTS, AND UNWRAP ANY CIRCLING ROOTS. 3. ADD COMMERCIAL SLOW RELEASE FERTILIZER TABLETS TO BACKFILL AT 6" DEPTH.

GROUND COVER PLANTING

NOT TO SCALE

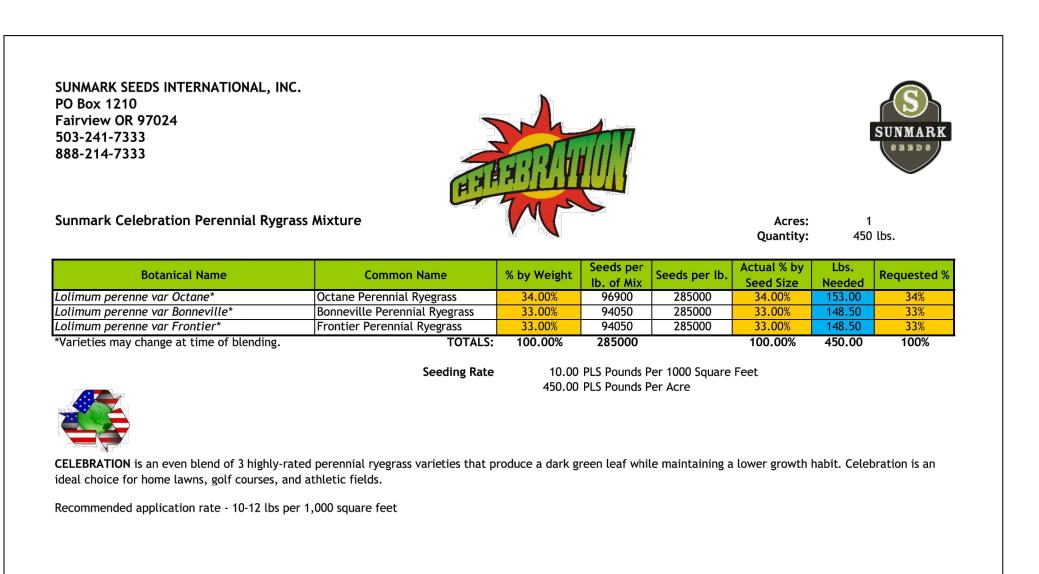

SUNMARK CELEBRATION PERENNIAL RYEGRASS MIXTURE

LANDSCAPE NOTES

- 1. BEFORE ANY EXCAVATION CALL DIG SAFELY OREGON 1-800-332-2344 OR 811 TO LOCATE UNDERGROUND UTILITIES. NOTIFY LANDSCAPE ARCHITECT OF ANY CONFLICTS WITH PROPOSED OR EXISTING UNDERGROUND UTILITIES.
- 2. PROTECT ALL EXISTING DRAINAGE FACILITIES IN THE WORK AREA. MINIMIZE RUN-OFF WITH BEST MANAGEMENT PRACTICES. REFER TO CIVIL ESC
- 3. COORDINATE WORK SCHEDULE AND OBSERVATIONS WITH LANDSCAPE ARCHITECT PRIOR TO CONSTRUCTION START-UP.
- 4. ALL PLANT MATERIALS SHALL BE INSTALLED AS PER DETAILS.
- 5. ALL PLANT MATERIALS SHALL CONFORM TO THE AMERICAN NURSERYMAN STANDARDS FOR TYPE AND SIZE SHOWN. PLANTS WILL BE REJECTED IF NOT IN A SOUND AND HEALTHY CONDITION.
- 6. ALL PLANTING BEDS SHALL BE COVERED WITH A MINIMUM OF 3" OF SMALL (1" MINUS) BARK MULCH OR BSD APPROVED COVER.
- 7. ALL WORK SHALL BE PERFORMED BY QUALIFIED CONTRACTOR FAMILIAR WITH PLANTING WORK.
- 8. PLANT MATERIAL LOCATIONS SHOWN ARE DIAGRAMMATIC AND MAY BE SUBJECT TO CHANGE IN THE FIELD BY THE LANDSCAPE ARCHITECT BEFORE THE MAINTENANCE PERIOD BEGINS DUE TO UNFORESEEN CONFLICTS.
- 9. PLANT COUNT AND LEGEND IS FOR THE CONVENIENCE OF THE CONTRACTOR. IN THE CASE OF DISCREPANCIES, THE PLAN SHALL TAKE PRECEDENCE.
- 10. PLANT MATERIAL LOCATIONS ARE TO BE ADJUSTED IN THE FIELD AS NECESSARY TO SCREEN UTILITIES, PEDESTRIAN AND TRAFFIC SIGHT LINES, NOR IMPEDE ACCESS.
- 11. THE LANDSCAPE ARCHITECT RESERVES THE RIGHT TO MAKE SUBSTITUTIONS, ADDITIONS AND DELETIONS IN THE PLANTING SCHEME AS NECESSARY WHILE WORK IS IN PROGRESS. SUCH CHANGES ARE TO BE ACCOMPANIED BY EQUITABLE ADJUSTMENTS IN THE CONTRACT PRICE IF/WHEN NECESSARY.
- 12. ALL PLANT MATERIAL SHALL BE GUARANTEED FOR A PERIOD OF TWO YEARS BEGINNING AT THE DATE OF ACCEPTANCE BY THE OWNER. REPLACE ALL PLANT MATERIAL FOUND DEAD OR NOT IN A HEALTHY CONDITION IMMEDIATELY WITH THE SAME SIZE AND SPECIES AT NO COST TO THE OWNER.
- 13. ALL PLANTING LOCATED ADJACENT TO SIGNS SHALL BE FIELD ADJUSTED SO AS NOT TO INTERFERE WITH VISIBILITY OF THE SIGNS.
- 14. ALL PLANTING AREAS TO HAVE POSITIVE DRAINAGE TO EXISTING DRAINAGE SYSTEM. FINISH GRADES SHALL PROVIDE A SMOOTH TRANSITION WITH ADJACENT SURFACES IN ACCORDANCE WITH THE SITE GRADING PLAN.
- 15. AMEND EXISTING APPROVED TOPSOIL AT A RATION OF THREE CUBIC YARDS OF APPROVED COMPOST PER 1000 SQUARE FEET OF PLANTING AREA. ROTO-TILL ORGANIC MATER A MINIMUM OF 6" INTO TOPSOIL.
- 16. FERTILIZE ALL TREES AND SHRUBS WITH PLANTING TABLETS. QUANTITY PER MANUFACTURER'S RECOMMENDATIONS.
- 17. ALL PLANTING BEDS SHALL HAVE A MINIMUM 18" DEPTH OF TOPSOIL. LAWN AREAS SHALL HAVE A MINIMUM 12" DEPTH OF TOPSOIL. SPREAD, COMPACT
- AND FINE GRADE TOPSOIL TO A SMOOTH AND UNIFORM GRADE. 17.1. 0" BELOW ADJACENT SURFACES OF PLANTER BED AREAS.
- 17.2. 1-1/2" BELOW ADJACENT SURFACES OF TURF SOD AREAS. 17.3. 1" BELOW ADJACENT SURFACES OF TURF SEED AREAS.
- 18. IMMEDIATELY CLEAN UP ANY TOPSOIL OR OTHER DEBRIS ON THE SITE CREATED BY LANDSCAPE OPERATIONS AND DISPOSE OF PROPERLY OFF SITE.
- 19. 12" MINIMUM TOPSOIL DEPTH IS REQUIRED PER BSD TECHNICAL STANDARDS. REUSE EXISTING TOPSOIL ON SITE. SUPPLEMENT WITH IMPORTED TOPSOIL WHEN QUANTITIES ARE INSUFFICIENT. VERIFY QUALITY AND CONDITION OF TOPSOIL AS A GROWING MEDIUM. TOPSOIL SHALL BE A LOOSE, SANDY LOAM, CLEAN AND FREE OF TOXIC MATERIALS, NOXIOUS WEEDS, WEED SEEDS, ROCKS, GRASS OR OTHER FOREIGN MATERIAL AND HAVE A PH OF 6.0 TO 7.0. IF THE ON SITE TOPSOIL DOES NOT MEET MINIMUM STANDARDS,
- CONTRACTOR SHALL EITHER: 19.1. PROVIDE APPROVED IMPORTED MATERIALS.
- 19.2. IMPROVE AND AMEND ON SITE TOPSOIL WITH METHODS APPROVED BY THE LANDSCAPE ARCHITECT.

BUGBEY & ASSOCIATES LANDSCAPE ARCHITECTURE

> 88685 Faulhaber Rd Elmira, OR 97437 541-654-1513 bugbeyla@gmail.com

SPENCER BEUGBEY OREGON 02/05/2010


○ Ⅲ ◊ ST ST 139 PC

CONSTRUCTION DRAWINGS PERMIT AND BIDDING SET

ISSUE			
#	DESCRIPTI	ON	DATE
1	BSD COMM	IENTS	03/10/2020
DATE		02/18/2020	
PROJECT NO. CAD DWG FILE DRAWN BY		7839 SUNSET HS - CD.DWG	
		CHECK	KED BY

PLANTING DETAILS & NOTES

SCALE: NOT TO SCALE

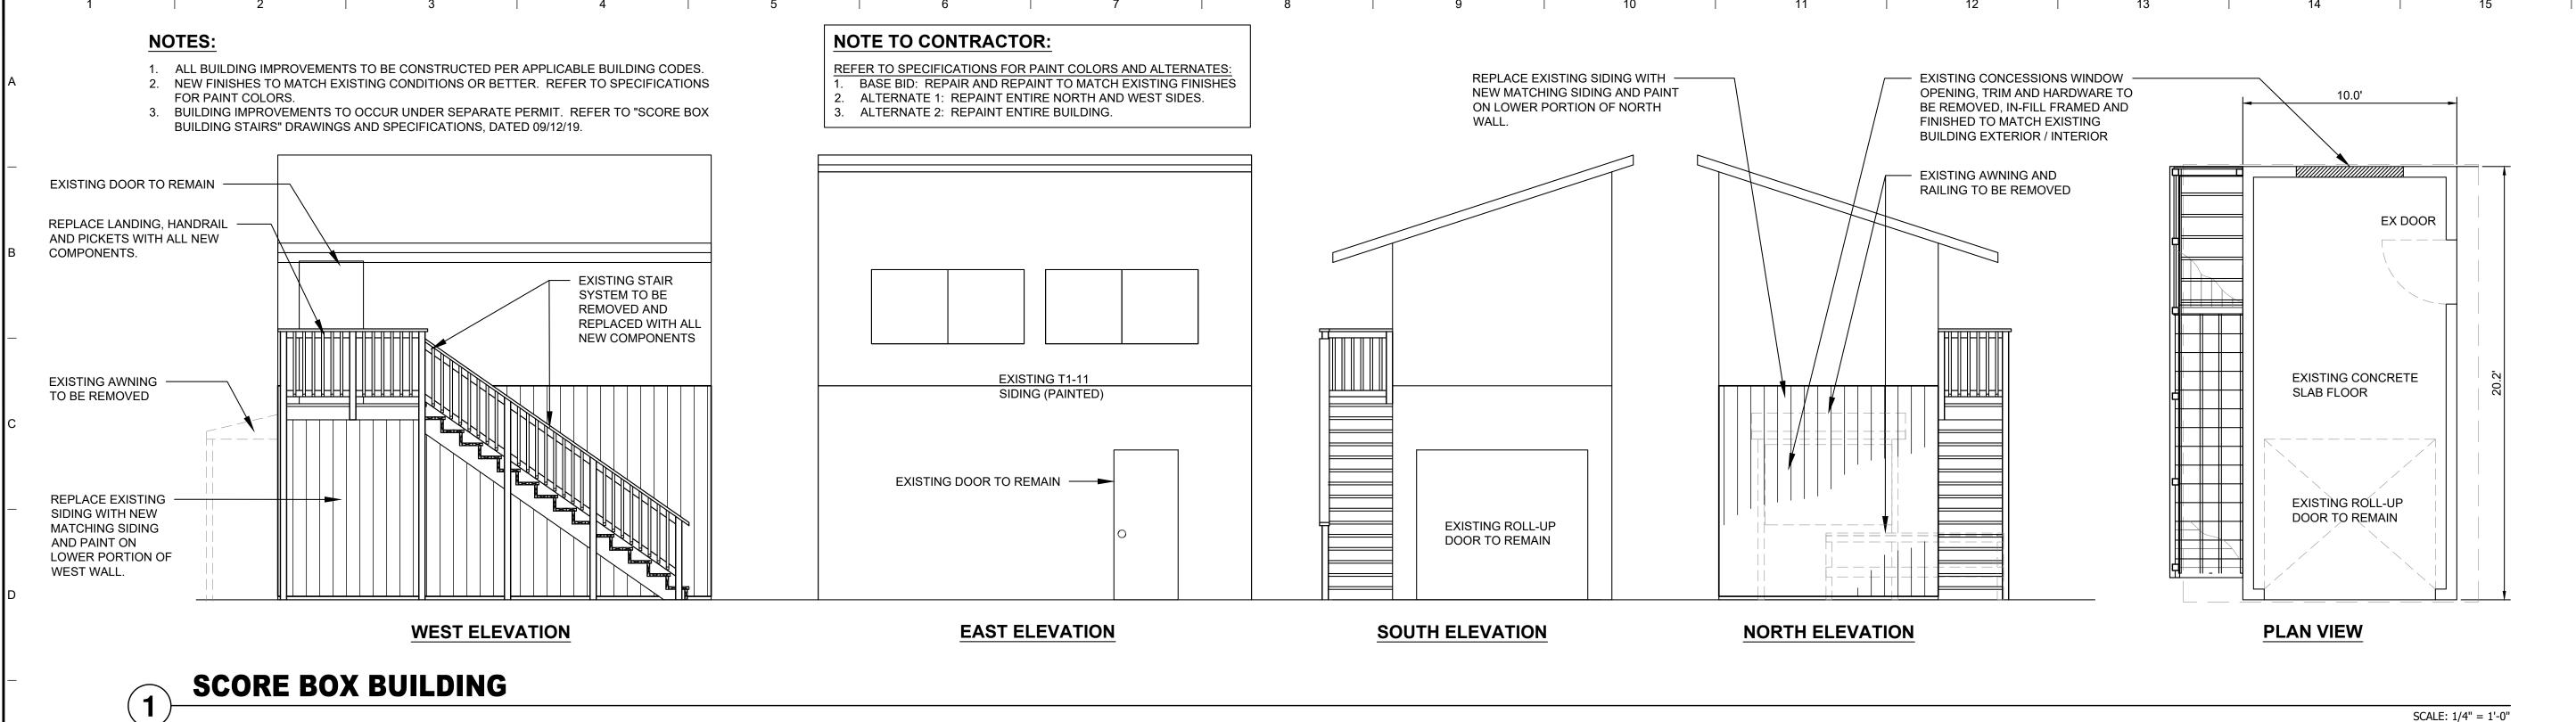

EXISTING SIGNAGE TO REMAIN


NOTE: BLEACHER COMPONENTS TO BE PROTECTED THROUGHOUT THE DURATION OF THE PROJECT. CLEAN AND RE-INSTALL OVER 1/2"-0 GRAVEL PER PLANS. (TYP OF 3)

SCALE: 1/4" = 1'-0"

EXISTING WOOD RUNNERS. REPLACE IF DEFICIENT.

PROTECT EXISTING CHAIN

LINK AND FRAMED BACKING

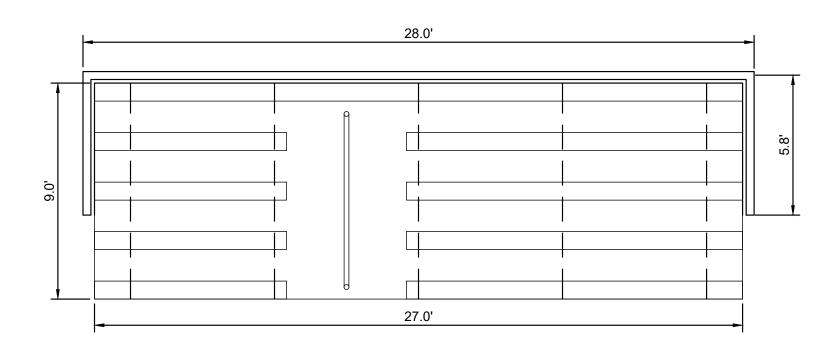

PLAN VIEW

EXISTING BLEACHERS

CHAIN LINK FENCE NOTES: REFER TO SPECIFICATIONS FOR ADDITIONAL INFORMATION

VINYL COATED CHAIN-LINK FABRIC

- 1. FENCE FABRIC WILL MEET ASTM F 668 CLASS 2B, FUSED-BONDED, AS MANUFACTURED BY PACIFIC FENCE & WIRE COMPANY OR APPROVED EQUAL.
- 2. FENCE FABRIC WILL BE BLACK, HAVE A KNUCKLE/KNUCKLE SELVAGE. THE WIRE WILL HAVE A MINIMUM 9-GAUGE CORE AND 8-GAUGE FINISH.
- 3. THE STANDARD DIAMOND SIZE WILL BE 2".
- 4. FABRIC ENDS SHALL OCCUR ONLY AT TERMINAL, CORNER, OR PULL POSTS. ATTACH FABRIC TO TERMINAL, CORNER, OR PULL POSTS WITH TENSION BARS AND TENSION BAR CLIPS WITH MAXIMUM 12" ON CENTER. FASTEN FABRIC TO LINE POSTS, TOP, BRACE, AND BOTTOM RAILS WITH TENSION WIRE WITH MAXIMUM 15" ON CENTER.

POSTS AND RAIL

- 5. POSTS AND RAIL 4" AND UNDER WILL MEET ASTM F 1043 GROUP
- 6. POSTS 6-58" AND 8-5/8" OD WILL MEET ASTM F 1043 GROUP 1-A. 7. BACK POSTS WILL HAVE A POWDER-COATED FINISH OVER THE GALVANIZED PIPE.

POST FOOTINGS

- 8. FENCES 6' AND UNDER WILL HAVE: 8.1. 36" X 10" TERMINAL/GATE POST FOOTINGS
- 8.2. 24" X 8" LINE POST FOOTINGS

TENSION WIRE

- 9. VINYL COATED TENSION WIRE WILL HAVE A 6-GAUGE FINISH/9-GAUGE CORE AND WILL BE MARCELLED. 10. VINYL COATED TENSION WIRE WILL MEET ASTM F 1664 CLASS 2A.
- 11. VINYL COATED HOG RINGS WILL HAVE A 9-GAUGE FINISH. 12. HOG RINGS WILL BE SPACED AT A MINIMUM OF 24".


- 13. BLACK FENCE FITTINGS WILL BE POWDER-COATED.
- 14. HEAVY BRACE AND TENSION BANDS 1/8" X 1" ARE REQUIRED. 15. VINYL COATED FENCE TIES WILL HAVE A 9-GAUGE FINISH WITH AN 11-GAUGE CORE WIRE.

INSTALLATION

16. POSTS SHALL BE SET IN CONCRETE WITH FENCE POST EXTENDING THROUGH BOTTOM OF CONCRETE.

- 17. TOP RAILS SHALL BE INSTALLED THROUGH LINE POST CAPS AND SPLICED WITH 6" SLEEVES. BOTTOM RAIL OR TENSION WIRE SHALL BE UNIFORMLY 1" ABOVE FINISH GRADE.
- 18. FABRIC SHALL BE INSTALLED TAUT, ON OUTSIDE OF POSTS AND RAILS, UNIFORMLY 1" ABOVE GROUND LEVEL.
- 19. MOW STRIP TO BE 4" THICK BY 24" WIDE CONCRETE MOW-STRIP, CENTERED ON THE FENCE AND FLUSH WITH THE FINISH GRADE, UNLESS OTHERWISE NOTED.

- 20. GATES WILL COMPLY WITH ASTM F 1043 GROUP 1-C, ASTM F 900, AND WILL HAVE COMMERCIAL GRADE HARDWARE.
- 21. ALL GATES WILL SWING OPEN AND HAVE HOLD OPEN BRACKETS TO SECURE GATE IN PLACE WHEN OPEN. 22. COMMERCIAL GRADE FORK LATCHES ARE TO BE INSTALLED ON
- GATES AND ABLE TO ACCOMMODATE DISTRICT AND FIRE DEPARTMENT PADLOCKS.
- 23. SINGLE GATE LATCHES SHALL BE CAPABLE OF RETAINING THE GATE IN A CLOSED POSITION AND SHALL HAVE A PROVISION FOR A
- 24. DOUBLE GATE LATCHES SHALL HAVE A DROP ROD OR A PLUNGER BAR ARRANGED TO ENGAGE THE GATE STOP. LATCHING DEVICES SHALL HAVE A PROVISION FOR A PADLOCK.
- 25. KEEPERS SHALL BE PROVIDED FOR ALL GATES OVER 5' TALL.

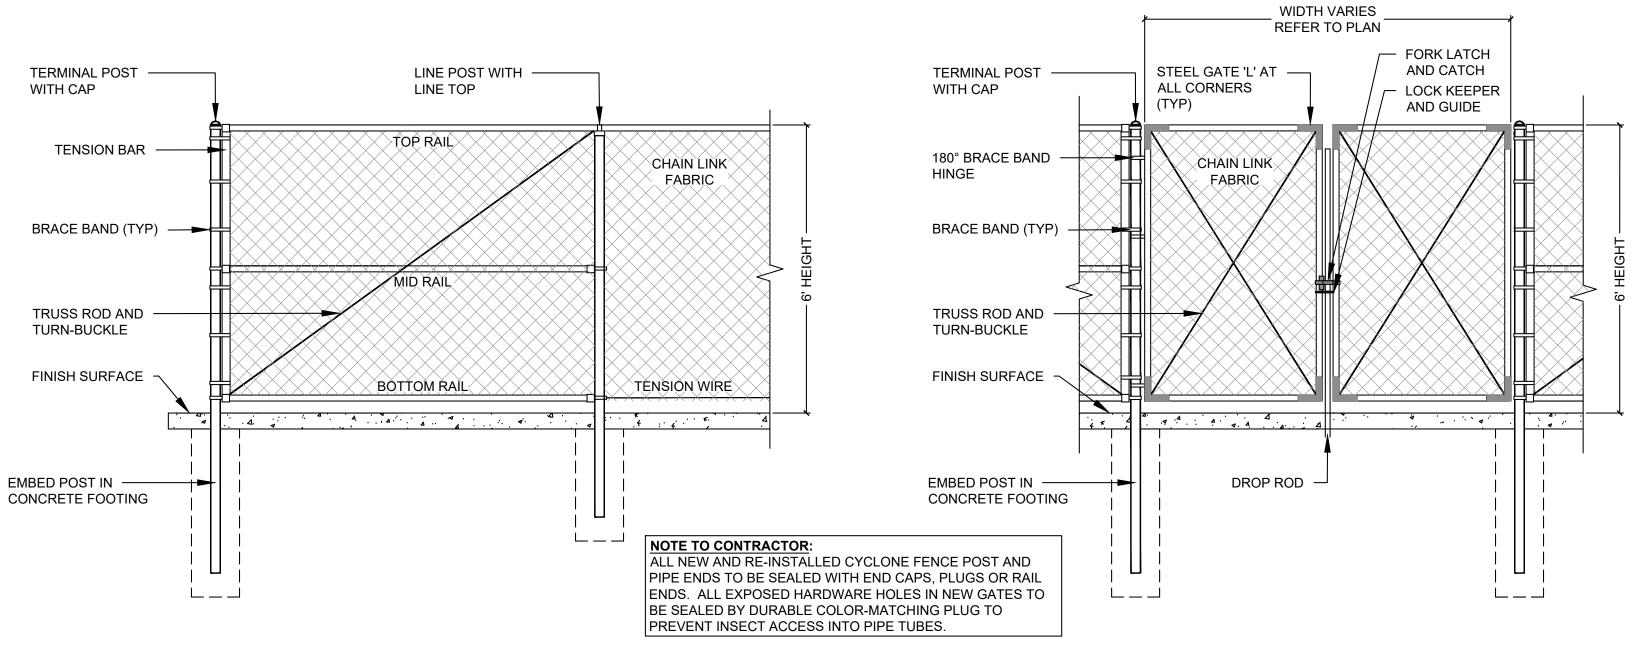

CHAIN LINK FENCE - 6' TALL

NOT TO SCALE

DOUBLE CHAIN LINK GATE

NOT TO SCALE

BUGBEY & ASSOCIATES LANDSCAPE ARCHITECTURE

> 88685 Faulhaber Rd Elmira, OR 97437 541-654-1513

bugbeyla@gmail.com

SPENCER B BUGBEY OREGON 02/05/2010


OL VEMENTS EO SUNSET SUNSET STADIUM 13840 NW PORTLANI

CONSTRUCTION DRAWINGS PERMIT AND BIDDING SET

ISSUE							
#	DESCRIPTI	ON	DATE				
1	BSD COMM	IENTS	03/10/2020				
DATE		02/18/2020					
PROJECT NO. CAD DWG FILE DRAWN BY		7839 SUNSET HS - CD.DWG					
				SBB, KHW			
		CHEC	(ED BY	SBB			

LANDSCAPE **DETAILS**


SCALE: NOT TO SCALE

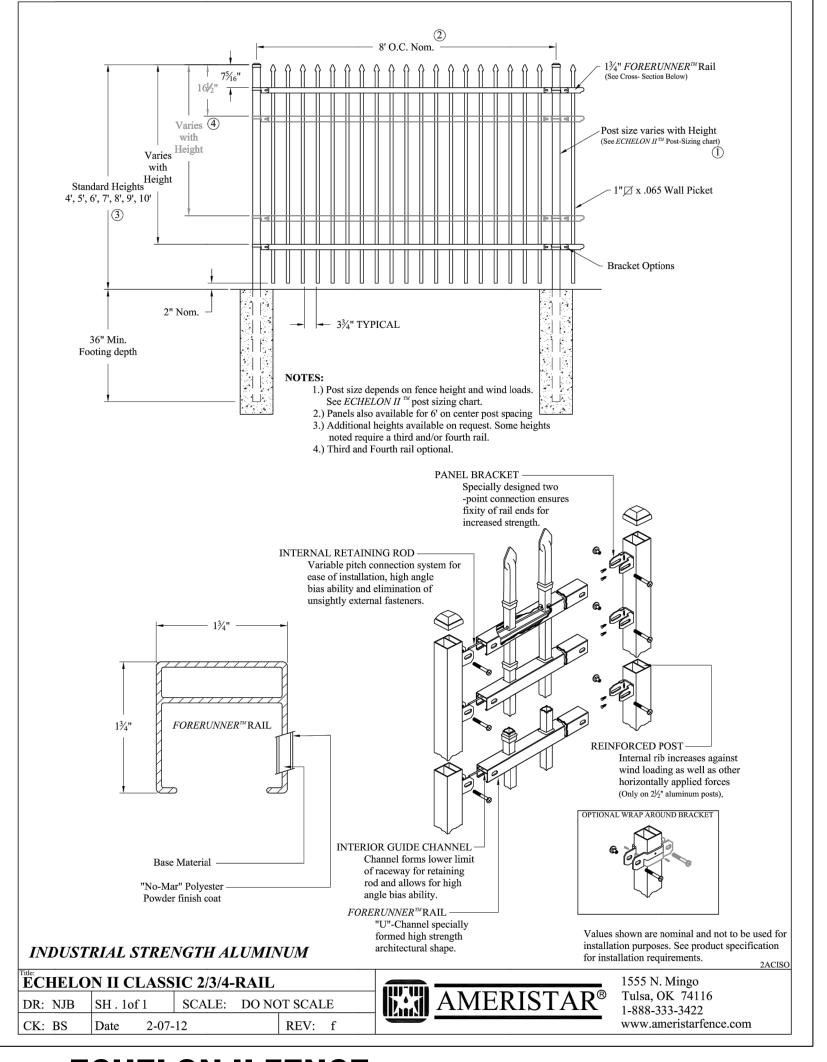

OF FOOTING. CENTER

POST IN FOOTING.

METAL RAIL FENCE AND GATE

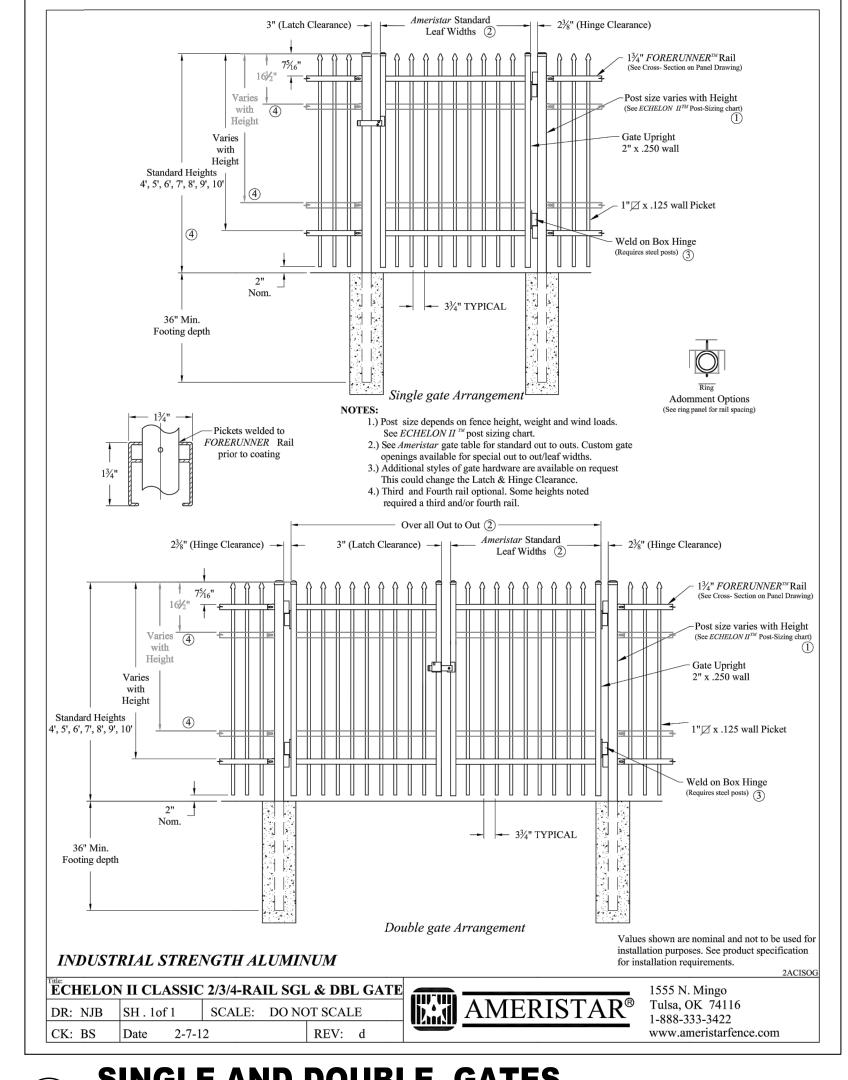


		· I			<u> Iinimui</u>	n Sizes for E	chelon I	I Posts			
Fence Posts Panel Height 2-1/2" x 2-1/2" x .080" Alum. Up to & Inc.				C) II.:l							
2-1/2		ium.	Up to & In	icluding (o Heigi	ıı					
3" x 3" x .120"			Over 6' Up	to & In	cluding	8' Height					
4" x 4" x .250"			Over 8' He								
					:						
							Gate Heig				
Gate Leaf <u>I</u>		Up to	& Including	<u> 4'</u>		4' Up to &			Up to &		Up to &
TT 4 42					Includ			Includin	<u>g 8'</u>	Includia	ng 10'
Up to 4'		3" x 3	" x .120" A	lum.		" x .250 Alun x 12 Ga. steel		4" x 11	Ga. steel	4" x 11	Ga. steel
4'1" to 6'		4" x 4	" x .250 Alu	ım.					~		~
			x 12Ga. stee		3" x 1	2 Ga. steel		4" x 11	Ga. steel	4" x 11	Ga. steel
6'1" to 8'		4" x 1	1 Ga. steel		4" x 1	1 Ga. steel			Ga. steel		6" steel
8'1" to 10'			1 Ga. steel			1 Ga. steel		6" x 3/1			6" steel
10'1" to 12'			1 Ga. steel			/16" steel		6" x 3/1			6" steel
12'1" to 14'		6" x 3	/16" steel		6" x 3	/16" steel		6" x 3/1	6" steel	6" x 3/1	6" steel
			Tal	blo 2 C	ooting	Performance	Doguire	omonts			
Quality Charact	teristics	ASTM	I Test Metho		vating .	Performan					
Adhesion	D3359 – Method B			-				ting) over 9	0% of test area	(Tape and	
						knife test).			<i>-</i>		` -
Corrosion Resistance B		B117 &	17 & D1654				Corrosion Resistance over 1,000 hours (Scribed per D1654; failure				
				mode is accumulation of 1/8" coating loss from scribe or				or medium			
Immant Dogistor		D2794					#8 blisters). Impact Resistance over 60 inch lb. (Forward impact using 0.625"				
Impact Resistar	ice	D2/94	•			ball).	esistance (over 60 i	nen ib. (For	ward impact us	sing 0.623
Weathering Res	sistance	D822 1	D2244, D523 (60° Method)			Weathering Resistance over 1,000 hours (Failure mode is 60% loss					
			,	of gloss or color variance of more than 3 delta-E color units)							
C	E. DI	TNOTE				Post Spacing			pe		
Span	For INV		25" Rail)	1	,	, GENESIS, & 2.625" Rail)	X MAJES	SIIC			
Post Size	2-1/2		3"	2-1/		3"	2-1/2	2"	3"	2-1/2"	3"
Bracket Type		Industri		Indus		Industrial		Industr			ıstrial
J1		Flat Mo		Unive	I	Universal		Flat Mo			vivel
		(BB30	1)	(BB3	02)	(BB303)		(BB30	1)	(BB	304)*
Post Settings ± ½" O.C.	94-1/2	2"	95"	96	,,	96.5"	96"	,	96-1/2"	*97.5"	*98"
Chan	For INV	INCIDI	TE®	For CI	ACCIC	CENECIC O	O- NAATES	CTIC			
Span	1		.375" Rail)			, GENESIS, & 7.75" Rail)	x ivi/iJES	3110			
Post Size	2-1/2		3"	2-1/		3"	2-1/2	2"	3"	2-1/2"	3"
Bracket Type		Industr		Indus		Industrial		Industr			ıstrial
• •		Flat Mo		Unive	ersal	Universal		Flat Mo			vivel
		(BB30	1)	(BB3	02)	(BB303)		(BB30	1)	(BB	304)*
Post Settings 75" 75.5"		71.5	5"	72"	71.5	,,,,	72"	*73"	*73.5"		
± ½" O.C.										l	
*Note: When u	sing DD2	04 033	al brooksta s	n aither	or both	ands of a man	al ingtalla	tion car	a must be tel	ran to anounc t	ha engaina
*Note: when t between post ar											ne spacing
comment post at	ia aajonin	-5 Pierce	meen app			wiii roqui	. c ammili	ing one (, com chas	or the puller.	
•											

ECHELON II FENCE

SINGLE AND DOUBLE GATES

NOT TO SCALE

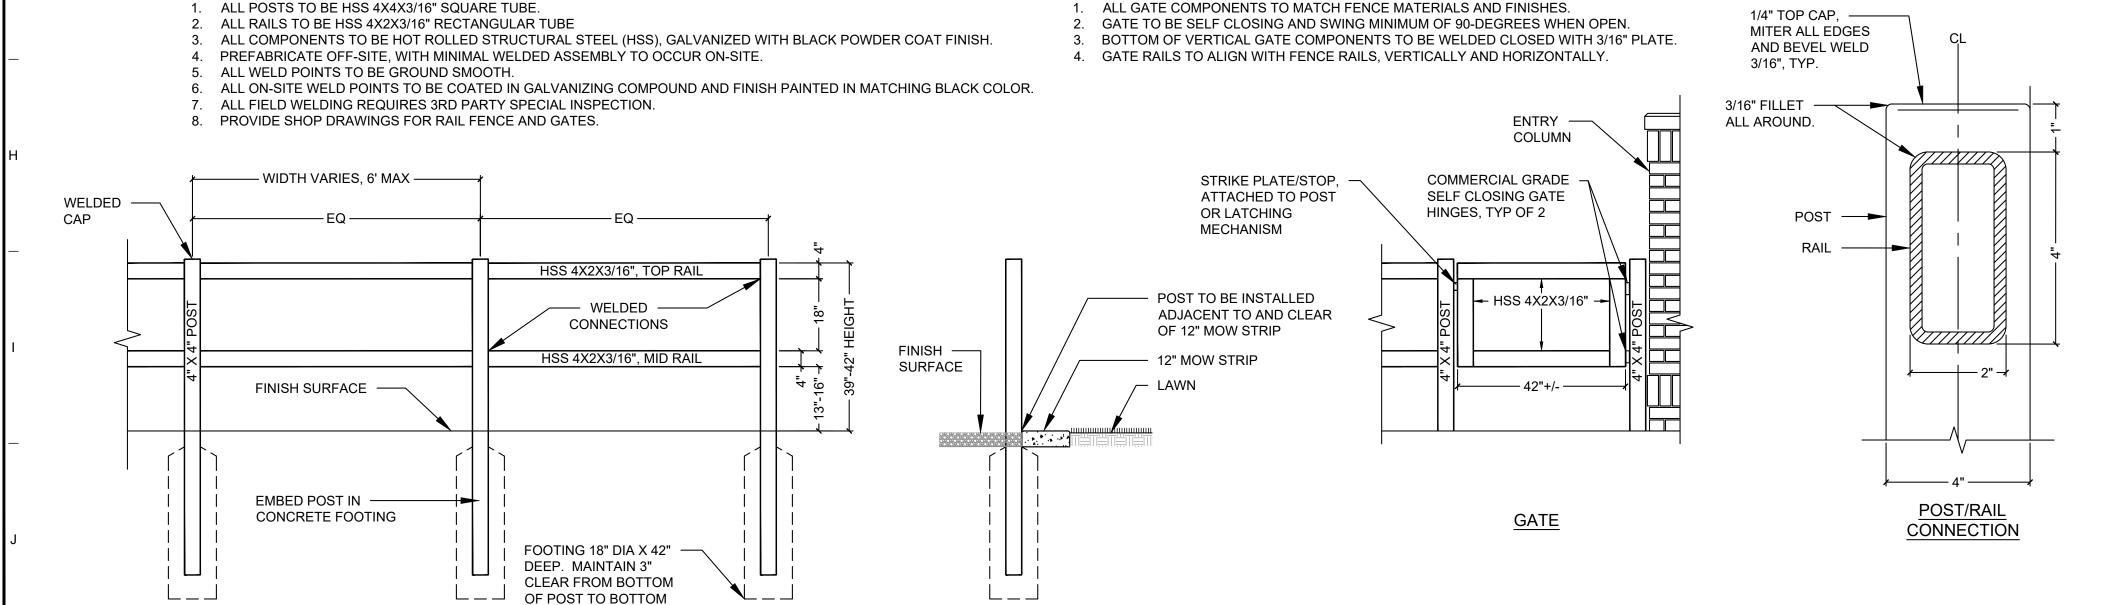

GATE NOTES:

NOT TO SCALE

COMMERCIAL ALUMINIUM FENCE, **GATES AND BRICK COLUMN NOTES**

PRE-FABRICATED ALUMINUM FENCE FENCE

- 1. <u>BASIS OF DESIGN STANDARD:</u> INSTALL AMERISTAR ECHELON II, 6' TALL CLASSIC
- 2. FENCE INSTALLER TO PROVIDE SHOP DRAWINGS FOR REVIEW AND APPROVAL CITY OF BEAVERTON STAFF.
- WITH BLACK POWDER COAT FINISH. BLACK POWDER COAT FINISH AND/OR
- MATCHING OUTDOOR RATED BLACK PAINTED FINISH.

COLUMNS

NOT TO SCALE

- 6. BRICK SELECTION, COLOR AND FINISH TO BE APPROVED BY BEAVERTON SCHOOL DISTRICT REPRESENTATIVES.
- 7. COLUMN CAPS TO BE PRE-CAST CONCRETE, FLAT TOP WITH CHAMFERED UPPER EDGE. COLOR TO BE APPROVED BY BEAVERTON SCHOOL DISTRICT REPRESENTATIVES.
- 8. ENTRY COLUMN DECORATIVE BALLS TO BE PRECAST, 18" BALL. COLOR AND FINISH TO MATCH CAPS.
- 9. REFER TO STRUCTURAL DRAWINGS FOR COLUMN AND FOOTING REINFORCEMENT.

FENCE ATTACHMENTS

- 10. FENCE POSTS AT COLUMNS WILL BE WITH APPROVED HARDWARE.
- 11. BLACK FENCE FITTINGS WILL BE POWDER-COATED.

REFER TO SPECIFICATIONS FOR ADDITIONAL INFORMATION

- INSTALLATION
- STYLE WITH 4 RAILS, COLOR BLACK.
- BY BEAVERTON SCHOOL DISTRICT AND 3. POST SIZE AND MATERIAL TO BE VERIFIED
- BY CONTRACTOR TO COMPLY WITH MANUFACTURER SPECIFICATIONS. 4. ALL FENCE PICKETS AND RAILS TO BE
- COMMERCIAL GRADE ALUMINUM FENCING 5. ALL HARDWARE AND FASTENERS TO HAVE

- SECURELY ATTACHED TO BRICK COLUMNS

12. LAYOUT AND INSTALLATION TO BE COORDINATED WITH CONCRETE WORK. LOCATE FENCE POSTS AT CONCRETE SCORE JOINTS AS SHOWN ON PLANS

- WHERE APPLICABLE. 13. PICKETS AND RAILS TO BE INSTALLED LEVEL AND PLUMB. STEPS IN ELEVATION WILL OCCUR AT POST LOCATIONS.
- 14. BOTTOM OF FENCE TO BE INSTALLED 2" ABOVE FINISH GRADE/MOW STRIP.
- 15. MOW STRIP TO BE 4" THICK BY 24" WIDE CONCRETE MOW-STRIP, CENTERED ON THE FENCE AND FLUSH WITH THE FINISH GRADE, UNLESS OTHERWISE NOTED.

GATES

- 16. DOUBLE GATES WILL SWING OPEN. 21. ALL SWING GATES WILL HAVE HOLD OPEN BRACKETS TO SECURE GATE IN PLACE
- WHEN OPEN. 22. COMMERCIAL GRADE FORK LATCHES ARE TO BE INSTALLED ON GATES AND ABLE TO ACCOMMODATE DISTRICT AND FIRE
- DEPARTMENT PADLOCKS. 23. DOUBLE GATE LATCHES SHALL HAVE A DROP ROD OR A PLUNGER BAR ARRANGED TO ENGAGE THE GATE STOP. LATCHING DEVICES SHALL HAVE A
- PROVISION FOR A PADLOCK. 24. KEEPERS SHALL BE PROVIDED FOR ALL GATES OVER 5' TALL.
- 25. CANTILEVER STYLE SLIDE GATE WITH THE APPROPRIATE COVERS WILL BE
- REQUIRED. 26. CANTILEVER STYLE SLIDE GATE TO BE INSTALLED PER MANUFACTURERS SPECIFICATIONS. BASIS OF DESIGN STANDARD: AMERISTAR TRANSPORT II CANTILEVER GATE. REFER TO SHEET L5.1.

BUGBEY & ASSOCIATES LANDSCAPE ARCHITECTURE

> 88685 Faulhaber Rd Elmira, OR 97437 541-654-1513 bugbeyla@gmail.com




HIGO SITE SUNSET SUNSET STADIUM 13840 NW PORTLANI


CONSTRUCTION DRAWINGS PERMIT AND BIDDING SET

#	DESCRIPTI	ON	DATE
1	BSD COMM	1ENTS	03/10/2020
DATE		02/18/2020	
PROJECT NO. CAD DWG FILE DRAWN BY		7839	
		SUNSET HS - CD.DWG	
		SBB, KHW	
CHEC	KED BY	SBB	


LANDSCAPE **DETAILS**

SCALE: NOT TO SCALE

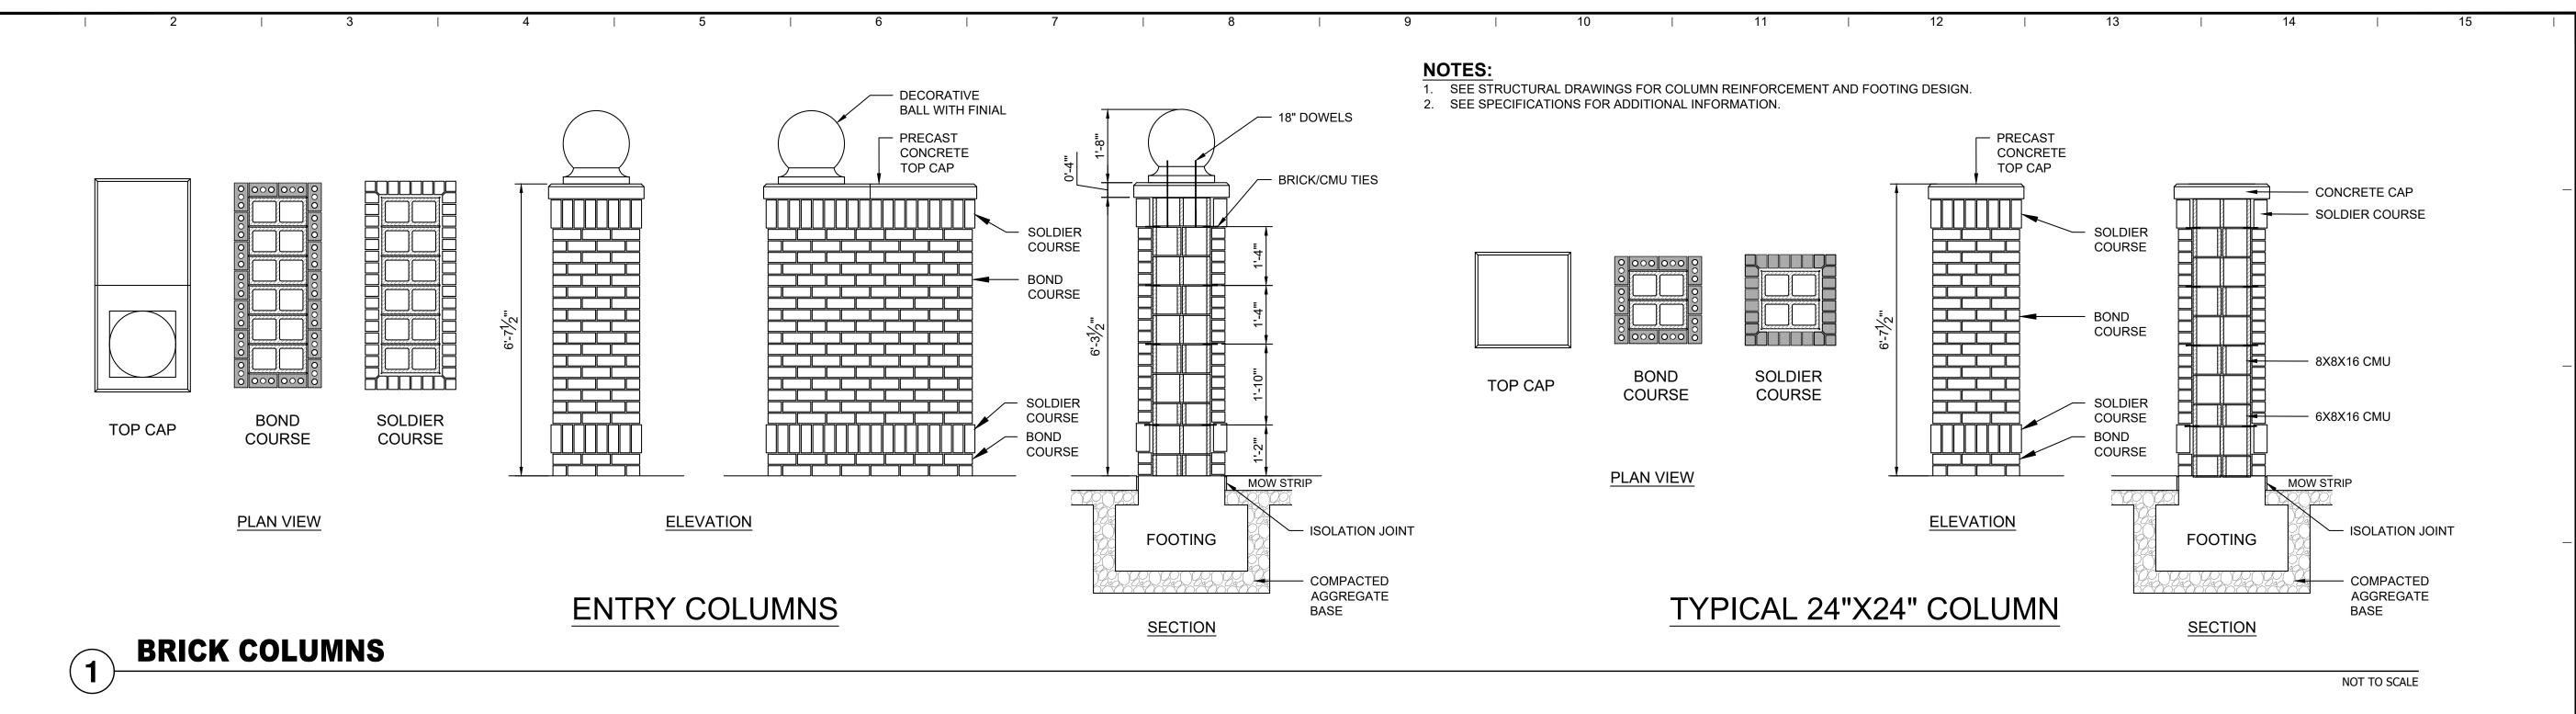

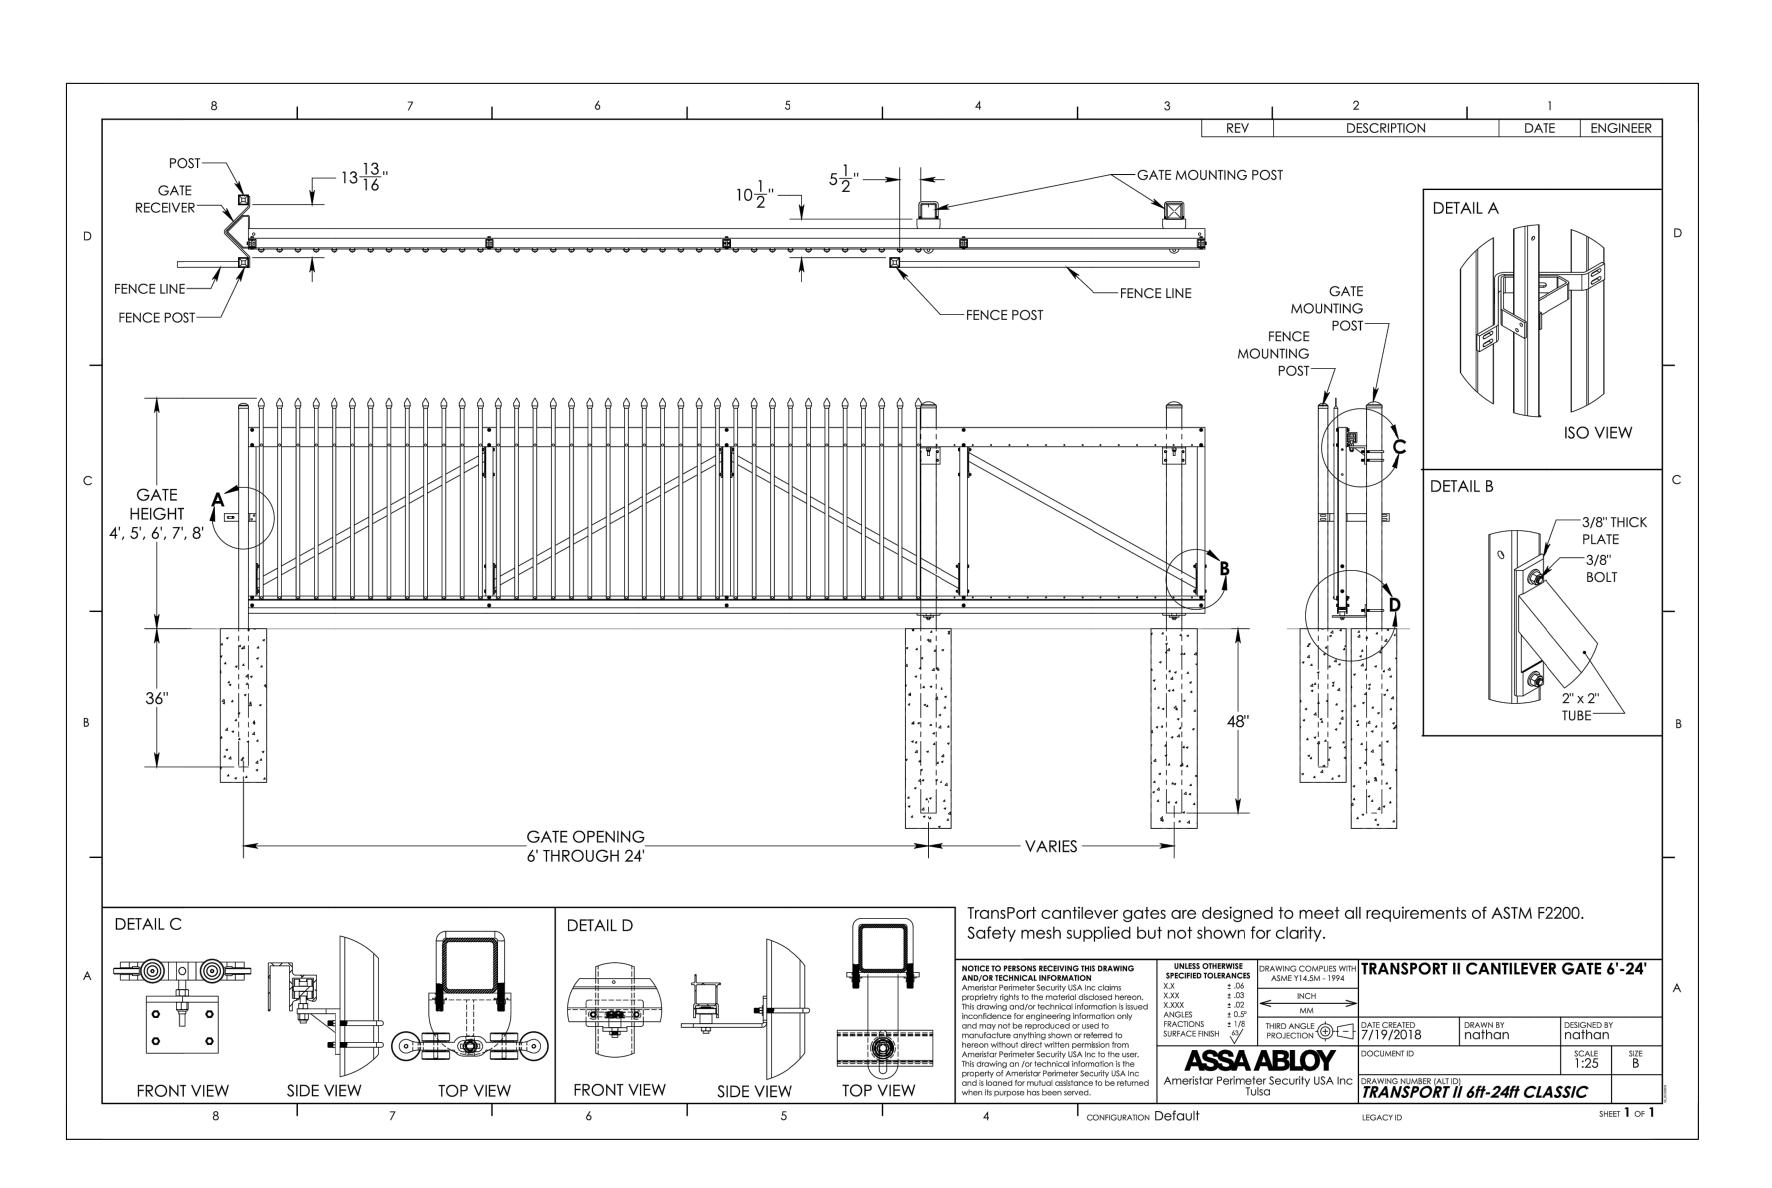

VEHICULAR ENTRY CANTILEVER GATE

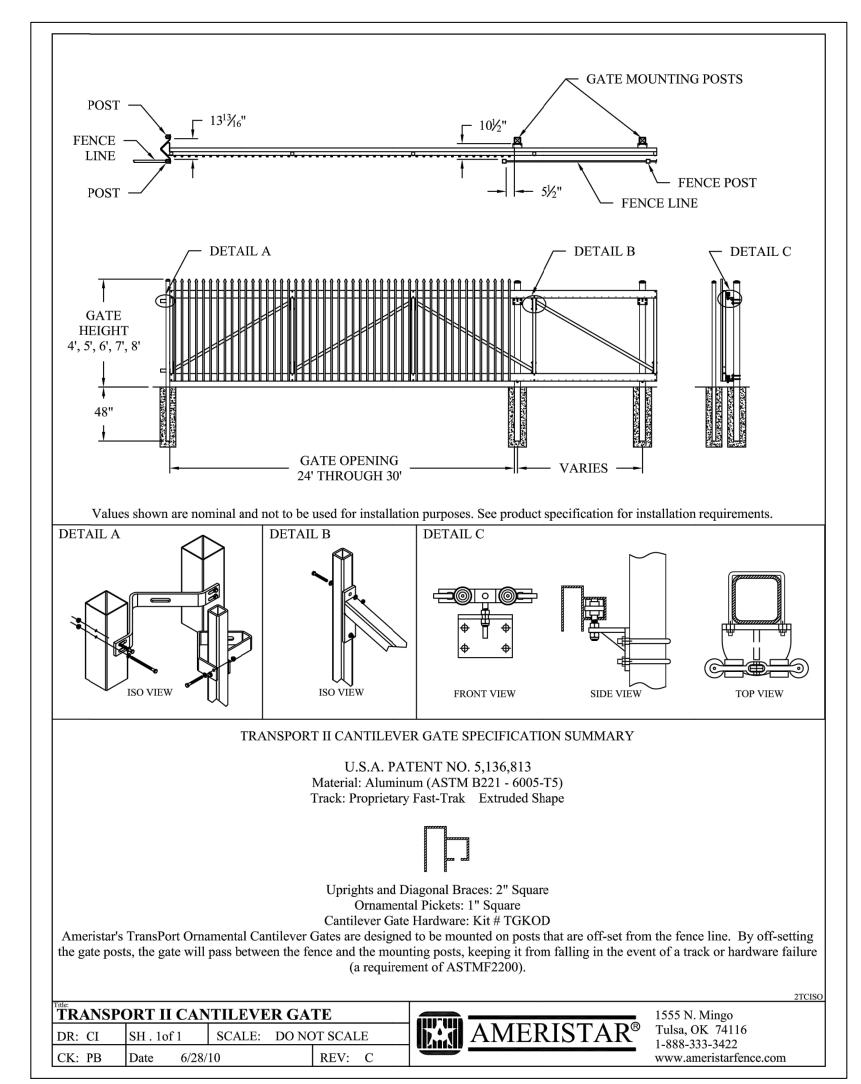

VEHICULAR ENTRY CANTILEVER GATE
AT FOOTBALL FIELD ENTRANCE

NOT TO SCALE

NOT TO SCALE

BUGBEY & ASSOCIATES LANDSCAPE ARCHITECTURE

> 88685 Faulhaber Rd Elmira, OR 97437 541-654-1513 bugbeyla@gmail.com



SUNSET HIGH SCHOOL DISTRICT
SUNSET HIGH SCHOOL
STADIUM SITE IMPROVEMENTS
13840 NW CORNELL ROAD
PORTI AND OR 97229


CONSTRUCTION DRAWINGS
PERMIT AND BIDDING SET


		_		
ISSUE				
#	DESCRIPTI	ON	DATE	
1	BSD COMM	IENTS	03/10/2020	
DATE		02/18/2020		
PROJECT NO.		7839		
CAD D	WG FILE	SUNSET HS - CD.DWG		
DRAW	N BY	SBB, KHW		
CHEC	KED BY	SBB		

LANDSCAPE DETAILS

SCALE: NOT TO SCALE

L5.2

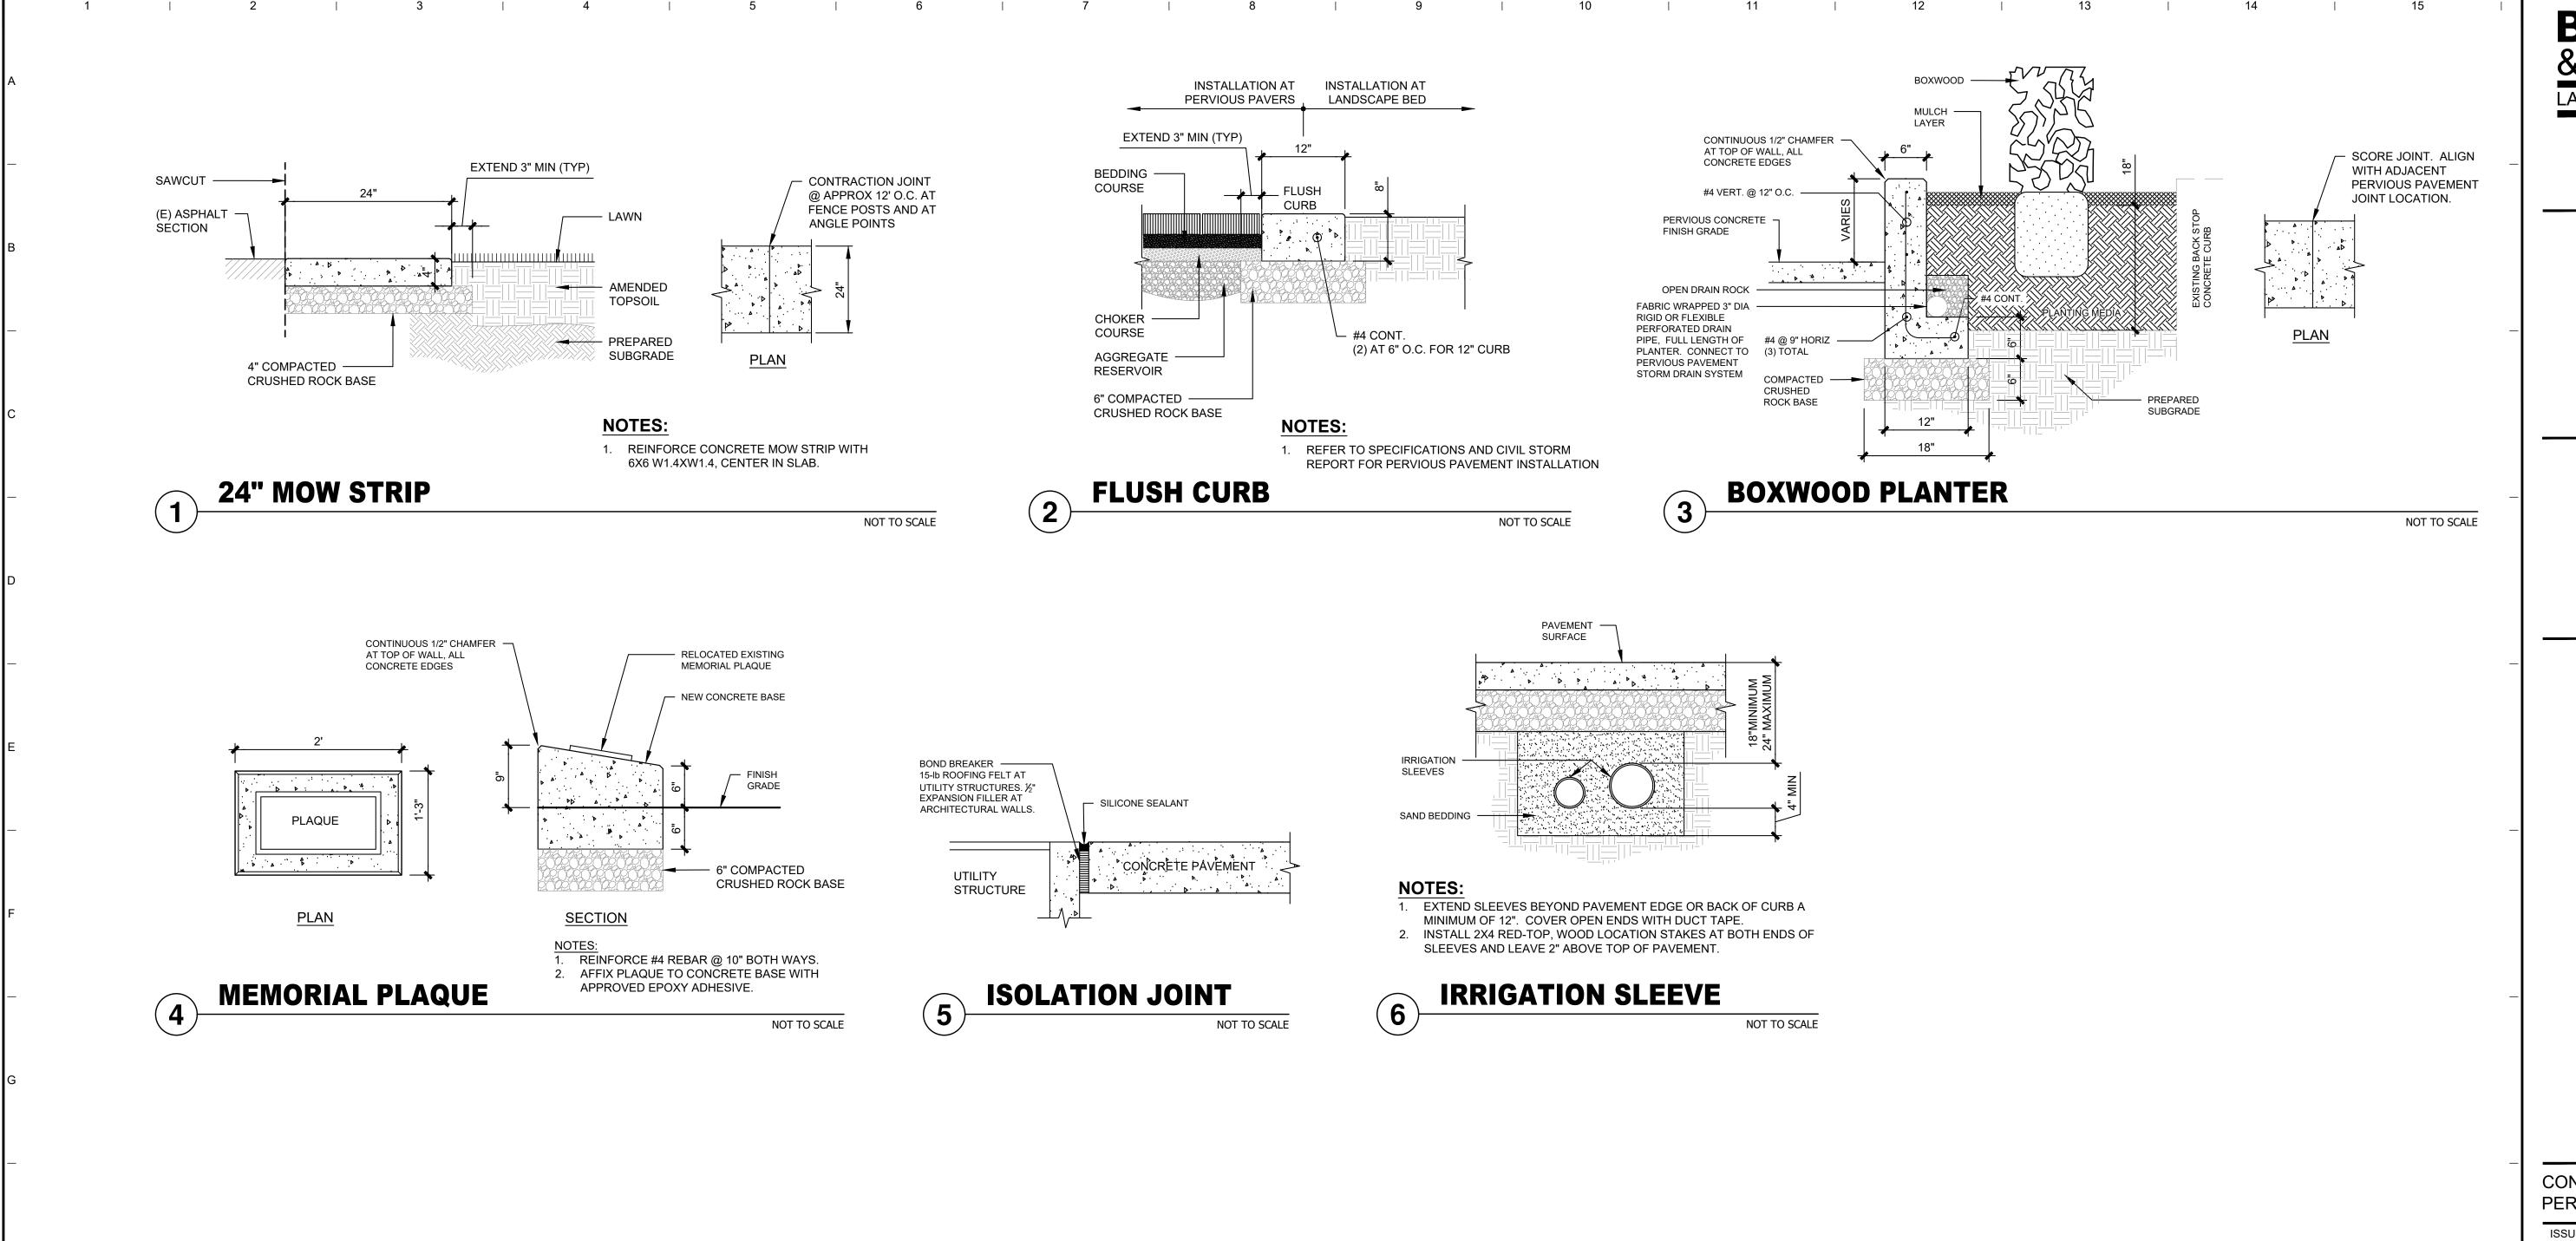

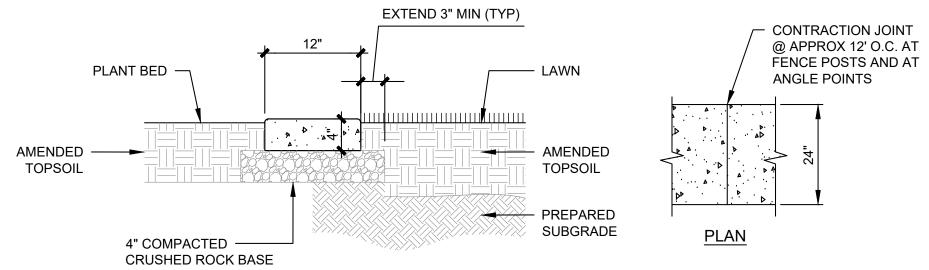

 REINFORCE CONCRETE MOW STRIP WITH 6X6 W1.4XW1.4, CENTER IN SLAB.

7 12" MOW STRIP

NOT TO SCALE

BUGBEY & ASSOCIATES LANDSCAPE ARCHITECTURE

> 88685 Faulhaber Rd Elmira, OR 97437 541-654-1513 bugbeyla@gmail.com

SPENCER BEUGBEY
OREGON
02/05/2010
OREGON
OZ/05/2010

SUNSET HIGH SCHOOL DISTRIC
SUNSET HIGH SCHOOL
STADIUM SITE IMPROVEMENTS
13840 NW CORNELL ROAD
PORTLAND, OR 97229

CONSTRUCTION DRAWINGS
PERMIT AND BIDDING SET


ISSUE					
#	DESCRIPTI	ON	DATE		
1	BSD COMM	IENTS	03/10/2020		
DATE		02/18/2020			
PROJECT NO.		7839			
CAD DWG FILE		SUNSET HS - CD.DWG			
DRAW	N BY	SBB, KHW			
CHEC	KED BY	SBB	·		


LANDSCAPE DETAILS

SCALE: NOT TO SCALE

:1:

L5.3

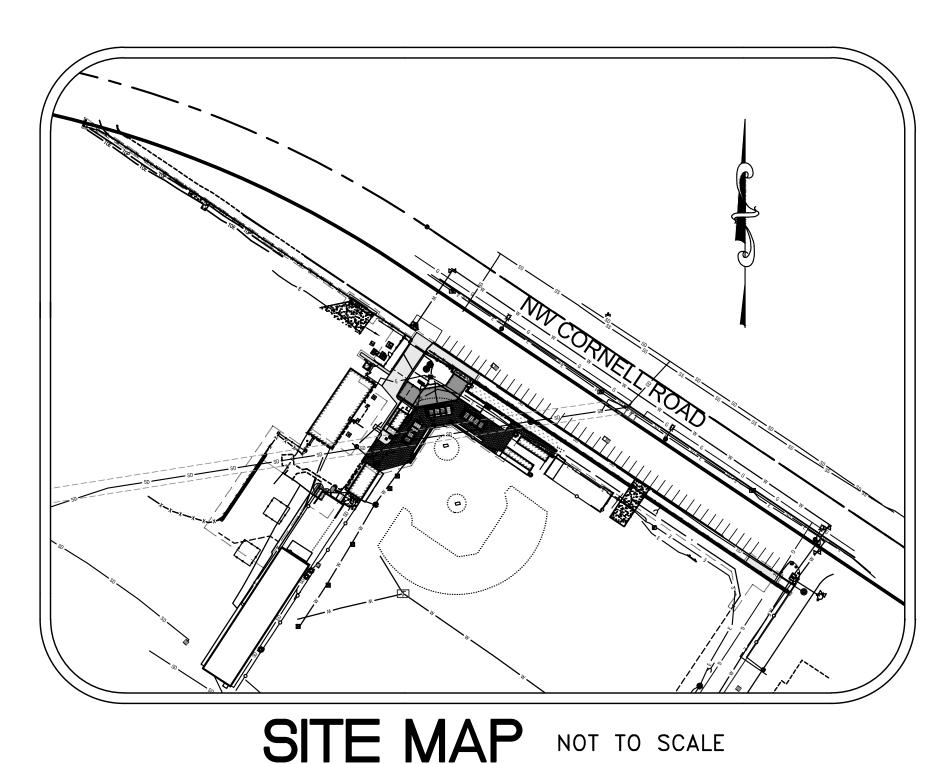

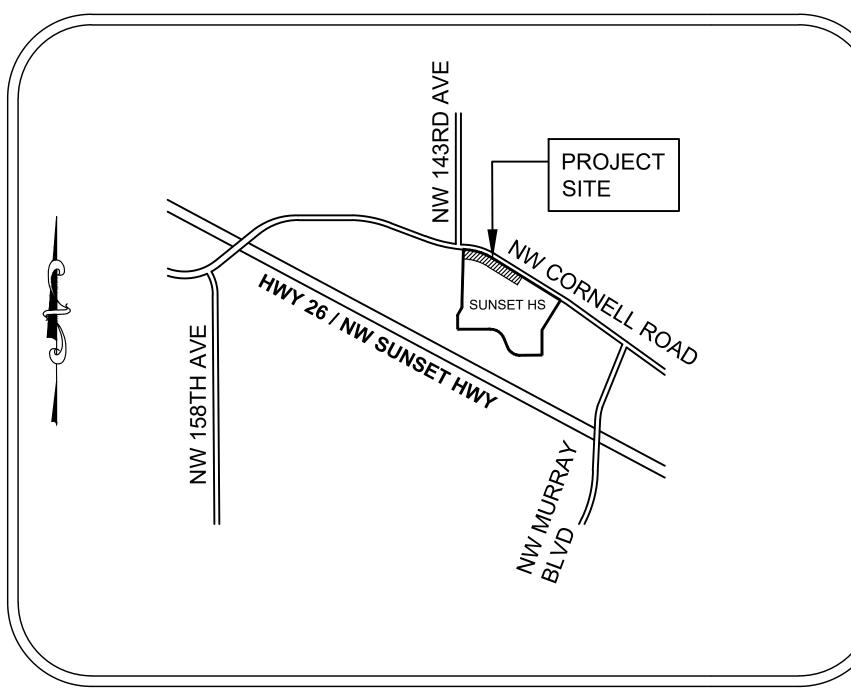

VICINITY MAP

PROJECT LOCATION:

13840 NW CORNELL ROAD BEAVERTON, OREGON LATITUDE = 45.529557, LONGITUDE = -122.821811

PROPERTY DESCRIPTION:

NOT TO SCALE

TAX LOT 1300 (WASHINGTON COUNTY TAX MAP 1N133BC) LOCATED IN THE SOUTHWEST 1/4 OF SECTION 33, TOWNSHIP 1 NORTH,

RANGE 1 WEST, WILLAMETTE MERIDIAN, WASHINGTON COUNTY, OREGON

ATTENTION EXCAVATORS:

OREGON LAW REQUIRES YOU TO FOLLOW RULES ADOPTED BY THE OREGON UTILITY NOTIFICATION CENTER. THOSE RULES ARE SET FORTH IN OAR 952-001-0010 THROUGH OAR 952-001-0090. YOU MAY OBTAIN COPIES OF THESE RULES FROM THE CENTER BY CALLING 503-232-1987. IF YOU HAVE ANY QUESTIONS ABOUT THE RULES, YOU MAY CONTACT THE CENTER. YOU MUST NOTIFY THE CENTER AT LEAST TWO BUSINESS DAYS. BEFORE COMMENCING AN EXCAVATION. CALL 503-246-6699.

ESC PLAN FOR SUNSET HIGH SCHOOL

DEVELOPER

DEVELOPER/COMPANY: BEAVERTON SCHOOL DISTRICT CONTACT: DOAA ELHAGGAN, PROJECT MANAGER, FACILITIES DEVELOPMENT 16550 SW MERLOT ROAD BEAVERTON, OR 97003 PHONE: 503-356-4433 EMAIL: Doaa_EI_Haggan@beaverton.k12.or.us

ENGINEERING FIRM

JANET TURNER ENGINEERING, LLC CONTACT: JANET TURNER, P.E. 16869 65TH AVENUE, BOX #194 LAKE OSWEGO, OR 97035 PHONE: 541-510-0878 EMAIL: JTURNER@JTURNERENGINEERING.COM

SURVEYING FIRM

MONTOYA LAND SURVEYING, LLC CONTACT: JAMES S. MONTOYA P.O. BOX 250 BROWNSVILLE, OR 97327 PHONE: 541-221-2427

NARRATIVE DESCRIPTIONS

EXISTING SITE CONDITIONS

EXISTING BALLFIELD VIEWING AREA WITH GRAVEL SURFACES. METAL BLEACHERS AND EXISTING SCORE BOX BUILDING

DEVELOPED CONDITIONS

REDEVELOPED VIEWING/SEATING AREA, WITH ASSOCIATED VEHICULAR AND PEDESTRIAN PAVEMENT IMPROVEMENTS. UTILITY INFRASTRUCTURE AND LANDSCAPE IMPROVEMENTS.

NATURE OF CONSTRUCTION AND ACTIVITY TIME TABLE

- CLEARING DATES, FROM & TO:
- MASS GRADING DATES, FROM & TO: TBD UTILITY INSTALLATION DATES, FROM & TO: TBD
- SITE CONSTRUCTION DATES. FROM & TO: TBD FINAL STABILIZATION DATES, FROM & TO: TBD

TOTAL SITE AREA = 41,398 SF = 0.95 ACRES

TOTAL DISTURBED AREA = 6.818 = 0.16 ACRES

<u>SITE SOIL CLASSIFICATION</u> (PER NATURAL RESOURCES CONSERVATION SERVICE (NRCS) WEB SOIL SURVEY OF WASHINGTON COUNTY) ALOHA SILT LOAM, O TO 3 PERCENT SLOPES, MAP UNIT 1 VERBOORT SILTY CLAY LOAM, 0 TO 3 PERCENT SLOPES, MAP UNIT 2027A.

STORMWATER POND AT 14375 NW SCIENCE PARK DRIVE

INSPECTION FREQUENCY:

	SITE CONDITION	MINIMUM FREQUENCY
1.	ACTIVE PERIOD	WEEKLY WHEN STORMWATER RUNOFF, INCLUDING RUNOFF FROM SNOW MELT, IS OCCURRING. AT LEAST ONCE EVERY MONTH, REGARDLESS OF WHETHER STORMWATER RUNOFF IS OCCURRING.
2.	PRIOR TO THE SITE BECOMING INACTIVE OR IN ANTICIPATION OF SITE INACCESSIBILITY.	ONCE TO ENSURE THAT EROSION AND SEDIMENT CONTROL MEASURES ARE IN WORKING ORDER. ANY NECESSARY MAINTENANCE AND REPAIR MUST BE MADE PRIOR TO LEAVING THE SITE.
3.	INACTIVE PERIODS GREATER THAN FOURTEEN (14) CONSECUTIVE CALENDAR DAYS.	ONCE EVERY MONTH.
4.	PERIODS DURING WHICH THE SITE IS INACCESSIBLE DUE TO INCLEMENT WEATHER.	IF PRACTICAL, INSPECTIONS MUST OCCUR DAILY AT A RELEVANT AND ACCESSIBLE DISCHARGE POINT OR DOWNSTREAM LOCATION.
5.	PERIODS DURING WHICH DISCHARGE IS UNLIKELY DUE TO FROZEN CONDITIONS.	MONTHLY. RESUME MONITORING IMMEDIATELY UPON MELT, OR WHEN WEATHER CONDITIONS MAKE DISCHARGES LIKELY.

- HOLD A PRE-CONSTRUCTION MEETING OF PROJECT CONSTRUCTION PERSONNEL THAT INCLUDES THE INSPECTOR TO DISCUSS EROSION AND SEDIMENT CONTROL MEASURES AND CONSTRUCTION LIMITS.
- ALL INSPECTIONS MUST BE MADE IN ACCORDANCE WITH DEQ 1200-CN PERMIT REQUIREMENTS.
- INSPECTION LOGS MUST BE KEPT IN ACCORDANCE WITH DEQ'S 1200-CN PERMIT REQUIREMENTS. RETAIN A COPY OF THE ESCP AND ALL REVISIONS ON SITE AND MAKE IT AVAILABLE ON REQUEST TO DEQ, AGENT, OR THE LOCAL MUNICIPALITY. DURING INACTIVE PERIODS OF GREATER THAN SEVEN (7) CONSECUTIVE CALENDAR DAYS, RETAIN THE ESCP AT THE CONSTRUCTION SITE OR AT ANOTHER LOCATION

STANDARD EROSION AND SEDIMENT CONTROL PLAN DRAWING NOTES:

- 1. ALL PERMIT REGISTRANTS MUST IMPLEMENT THE ESCP. FAILURE TO IMPLEMENT ANY OF THE CONTROL MEASURES OR PRACTICES DESCRIBED IN THE ESCP IS A VIOLATION OF THE PERMIT.
- 2. THE ESCP MEASURES SHOWN ON THIS PLAN ARE MINIMUM REQUIREMENTS FOR ANTICIPATED SITE CONDITIONS. DURING THE CONSTRUCTION PERIOD, UPGRADE THESE MEASURES AS NEEDED TO COMPLY WITH ALL APPLICABLE LOCAL, STATE, AND FEDERAL EROSION AND SEDIMENT CONTROL REGULATIONS.
- SUBMISSION OF ALL ESCP REVISIONS IS NOT REQUIRED. SUBMITTAL OF THE ESCP REVISIONS IS ONLY UNDER SPECIFIC CONDITIONS. SUBMIT ALL NECESSARY REVISION TO DEQ OR AGENT.
- PHASE CLEARING AND GRADING TO THE MAXIMUM EXTENT PRACTICAL TO PREVENT EXPOSED INACTIVE AREAS FROM BECOMING A SOURCE OF EROSION.
- 5. IDENTIFY, MARK, AND PROTECT (BY FENCING OFF OR OTHER MEANS) CRITICAL RIPARIAN AREAS AND VEGETATION INCLUDING IMPORTANT TREES AND ASSOCIATED ROOTING ZONES, AND VEGETATION AREAS TO BE PRESERVED. IDENTIFY VEGETATIVE BUFFER ZONES BETWEEN THE SITE AND SENSITIVE AREAS (E.G., WETLANDS), AND OTHER AREAS TO BE PRESERVED, ESPECIALLY IN PERIMETER AREAS.
- PRESERVE EXISTING VEGETATION WHEN PRACTICAL AND RE-VEGETATE OPEN AREAS. RE-VEGETATE OPEN AREAS WHEN PRACTICABLE BEFORE AND AFTER GRADING OR CONSTRUCTION. IDENTIFY THE TYPE OF VEGETATIVE SEED
- EROSION AND SEDIMENT CONTROL MEASURES INCLUDING PERIMETER SEDIMENT CONTROL MUST BE IN PLACE BEFORE VEGETATION IS DISTURBED AND MUST REMAIN IN PLACE AND BE MAINTAINED, REPAIRED, AND PROMPTLY IMPLEMENTED FOLLOWING PROCEDURES ESTABLISHED FOR THE DURATION OF CONSTRUCTION, INCLUDING PROTECTION FOR ACTIVE STORM DRAIN INLETS AND CATCH BASINS AND APPROPRIATE NON-STORMWATER
- ESTABLISH CONCRETE TRUCK AND OTHER CONCRETE EQUIPMENT WASHOUT AREAS BEFORE BEGINNING CONCRETE WORK. DIRECT ALL WASH WATER INTO A PIT OR LEAK-PROOF CONTAINER. HANDLE WASH WATER AS WASTE. CONCRETE DISCHARGE TO WATERS OF THE STATE IS PROHIBITED.
- 9. APPLY TEMPORARY AND/OR PERMANENT SOIL STABILIZATION MEASURES IMMEDIATELY ON ALL DISTURBED AREAS AS GRADING PROGRESSES AND FOR ALL ROADWAYS INCLUDING GRAVEL ROADWAYS.
- 10. ESTABLISH MATERIAL AND WASTE STORAGE AREAS, AND OTHER NON-STORMWATER CONTROLS 11. PREVENT TRACKING OF SEDIMENT ONTO PUBLIC OR PRIVATE ROADS USING BMPS SUCH AS: GRAVELED (OR
- PAVED) EXITS AND PARKING AREAS, GRAVEL ALL UNPAVED ROADS LOCATED ONSITE, OR USE AN EXIT TIRE WASH. THESE BMPS MUST BE IN PLACE PRIOR TO LAND-DISTURBING ACTIVITIES.
- 12. WHEN TRUCKING SATURATED SOILS FROM THE SITE, EITHER USE WATER-TIGHT TRUCKS OR DRAIN LOADS ON
- 13. USE BMPS TO PREVENT OR MINIMIZE STORMWATER EXPOSURE TO POLLUTANTS FROM SPILLS; VEHICLE AND EQUIPMENT FUELING, MAINTENANCE, AND STORAGE; OTHER CLEANING AND MAINTENANCE ACTIVITIES: AND WASTE HANDLING ACTIVITIES. THESE POLLUTANTS INCLUDE FUEL, HYDRAULIC FLUID, AND OTHER OILS FROM VEHICLES AND MACHINERY, AS WELL AS DEBRIS, LEFTOVER PAINTS, SOLVENTS, AND GLUES FROM CONSTRUCTION
- 14. IMPLEMENT THE FOLLOWING BMPS WHEN APPLICABLE: WRITTEN SPILL PREVENTION AND RESPONSE PROCEDURES. EMPLOYEE TRAINING ON SPILL PREVENTION AND PROPER DISPOSAL PROCEDURES, SPILL KITS IN ALL VEHICLES. REGULAR MAINTENANCE SCHEDULE FOR VEHICLES AND MACHINERY. MATERIAL DELIVERY AND STORAGE CONTROLS. TRAINING AND SIGNAGE, AND COVERED STORAGE AREAS FOR WASTE AND SUPPLIES.
- 15. USE WATER, SOIL-BINDING AGENT OR OTHER DUST CONTROL TECHNIQUE AS NEEDED TO AVOID WIND-BLOWN
- 16. THE APPLICATION RATE OF FERTILIZERS USED TO REESTABLISH VEGETATION MUST FOLLOW MANUFACTURER'S RECOMMENDATIONS TO MINIMIZE NUTRIENT RELEASES TO SURFACE WATERS. EXERCISE CAUTION WHEN USING TIME-RELEASE FERTILIZERS WITHIN ANY WATERWAY RIPARIAN ZONE.
- 17. IF A STORMWATER TREATMENT SYSTEM (FOR EXAMPLE, ELECTRO—COAGULATION, FLOCCULATION, FILTRATION, ETC.) FOR SEDIMENT OR OTHER POLLUTANT REMOVAL IS EMPLOYED, SUBMIT AN OPERATION AND MAINTENANCE PLAN (INCLUDING SYSTEM SCHEMATIC, LOCATION OF SYSTEM, LOCATION OF INLET, LOCATION OF DISCHARGE, DISCHARGE DISPERSION DEVICE DESIGN. AND A SAMPLING PLAN AND FREQUENCY) BEFORE OPERATING THE TREATMENT SYSTEM. OBTAIN PLAN APPROVAL BEFORE OPERATING THE TREATMENT SYSTEM. OPERATE AND MAINTAIN THE TREATMENT SYSTEM ACCORDING TO MANUFACTURER'S SPECIFICATIONS.
- 18. AT THE END OF EACH WORKDAY SOIL STOCKPILES MUST BE STABILIZED OR COVERED, OR OTHER BMPS MUST BE IMPLEMENTED TO PREVENT DISCHARGES TO SURFACE WATERS OR CONVEYANCE SYSTEMS LEADING TO
- SURFACE WATERS. 19. CONSTRUCTION ACTIVITIES MUST AVOID OR MINIMIZE EXCAVATION AND CREATION OF BARE GROUND DURING WET WEATHER OCTOBER 01 - MAY 31.
- 20. SEDIMENT FENCE: REMOVE TRAPPED SEDIMENT BEFORE IT REACHES ONE THIRD OF THE ABOVE GROUND FENCE HEIGHT AND BEFORE FENCE REMOVAL.
- 21. OTHER SEDIMENT BARRIERS (SUCH AS BIOBAGS): REMOVE SEDIMENT BEFORE IT REACHES TWO INCHES DEPTH ABOVE GROUND HEIGHT. AND BEFORE BMP REMOVAL. 22. CATCH BASINS: CLEAN BEFORE RETENTION CAPACITY HAS BEEN REDUCED BY FIFTY PERCENT. SEDIMENT BASINS
- PERCENT AND AT COMPLETION OF PROJECT. 23. WITHIN 24 HOURS, SIGNIFICANT SEDIMENT THAT HAS LEFT THE CONSTRUCTION SITE, MUST BE REMEDIATED. INVESTIGATE THE CAUSE OF THE SEDIMENT RELEASE AND IMPLEMENT STEPS TO PREVENT A RECURRENCE OF THE DISCHARGE WITHIN THE SAME 24 HOURS. ANY IN-STREAM CLEAN UP OF SEDIMENT SHALL BE PERFORMED

and sediment traps: remove trapped sediments before design capacity has been reduced by fifty

- ACCORDING TO THE OREGON DIVISION OF STATE LANDS REQUIRED TIMEFRAME. 24. THE INTENTIONAL WASHING OF SEDIMENT INTO STORM SEWERS OR DRAINAGE WAYS MUST NOT OCCUR.
- VACUUMING OR DRY SWEEPING AND MATERIAL PICKUP MUST BE USED TO CLEANUP RELEASED SEDIMENTS. 25. PROVIDE PERMANENT EROSION CONTROL MEASURES ON ALL EXPOSED AREAS. DO NOT REMOVE TEMPORARY SEDIMENT CONTROL PRACTICES UNTIL PERMANENT VEGETATION OR OTHER COVER OF EXPOSED AREAS IS ESTABLISHED. HOWEVER, DO REMOVE ALL TEMPORARY EROSION CONTROL MEASURES AS EXPOSED AREAS BECOME STABILIZED, UNLESS DOING SO CONFLICTS WITH LOCAL REQUIREMENTS. PROPERLY DISPOSE OF CONSTRUCTION MATERIALS AND WASTE, INCLUDING SEDIMENT RETAINED BY TEMPORARY BMPS.
- 26. IF VEGETATIVE SEED MIXES ARE SPECIFIED, SEEDING MUST TAKE PLACE NO LATER THAT SEPTEMBER 1; THE TYPE AND PERCENTAGES OF SEED IN THE MIX MUST BE IDENTIFIED ON THE PLANS.
- 27. ALL PUMPING OF SEDIMENT LADEN WATER SHALL BE DISCHARGED OVER AN UNDISTURBED, PREFERABLY VEGETATED AREA, AND THROUGH A SEDIMENT CONTROL BMP I.E. (FILTER BAG).
- 28. ALL EXPOSED SOILS MUST BE COVERED DURING THE WET WEATHER PERIOD, OCTOBER 01 MAY 31 MAINTAIN THE EXISTING NATURAL BUFFER WITHIN THE 50-FOOT ZONE FOR THE DURATION OF THE PERMIT
- 29. IF WATER OF THE STATE IS WITHIN THE PROJECT SITE OR WITHIN 50 FEET OF THE PROJECT BOUNDARY COVERAGE, OR MAINTAIN LESS THAN THE ENTIRE EXISTING NATURAL BUFFER AND PROVIDE ADDITIONAL EROSION AND SEDIMENT CONTROL BMPS.

C0.0

NO SCALE

THE PERMITTEE IS REQUIRED TO MEET ALL THE CONDITIONS OF THE 1200-CN PERMIT. THIS ESCP AND GENERAL CONDITIONS HAVE BEEN DEVELOPED TO FACILITATE COMPLIANCE WITH THE 1200-CN PERMIT REQUIREMENTS. IN CASES OF DISCREPANCIES OR OMISSIONS. THE 1200-CN PERMIT REQUIREMENTS SUPERCEDE REQUIREMENTS OF THIS PLAN.

BMP MATRIX FOR CONSTRUCTION PHASES

		MASS	UTILITY	STREET	FINAL	WET WEATHER
	CLEARING	GRADING	INSTALLATION	CONSTRUCTION	STABILIZATION	(OCT. 1 - MAY 31ST
EROSION PREVENTION						
PRESERVE NATURAL VEGETATION	** X	Х	Х	Х	Х	Х
GROUND COVER	1				Х	Х
HYDRAULIC APPLICATIONS					Х	
PLASTIC SHEETING						Х
MATTING					Х	Х
DUST CONTROL	Х	Х	Х	Х	Х	Х
TEMPORARY/ PERMANENT SEEDING		Х	Χ	Х	Х	Х
BUFFER ZONE						
R:						
SEDIMENT CONTROL						
SEDIMENT FENCE (PERIMETER)	** X	Х	Χ	Х	Χ	χ
SEDIMENT FENCE (INTERIOR)			Χ	Х	Х	χ
STRAW WATTLES						
FILTER BERM						
INLET PROTECTION	** X	Х	Х	Х	χ	χ
DEWATERING						χ
SEDIMENT TRAP	Х	Х	Х	Х		
NATURAL BUFFER ENCROACHMENT						
ER:						
RUN OFF CONTROL				χ	χ	
CONSTRUCTION ENTRANCE	** X	Х	Х	Х	χ	Х
PIPE SLOPE DRAIN						
OUTLET PROTECTION						
SURFACE ROUGHENING						
CHECK DAMS						
ER:						
POLLUTION PREVENTION						
PROPER SIGNAGE	Х	Х	Х	Х	Х	Х
HAZ WASTE MGMT	Х	Х	Х	Х	Х	Х
SPILL KIT ON-SITE	Х	Х	Х	Х	χ	Х
CONCRETE WASHOUT AREA	Х	Х	Х	Х	χ	Х
ER:						
* SIGNIFIES ADD	OITIONAL BMP'S	REQUIRED	FOR WORK WITHIN	1 50' OF WATER OF	THE STATE	
SIGITII ILS ADD	//// DIVIL DIVIL O		TOIL HOILI HILLING	1 55 SI WILLIA OF	L O!/!IL.	

SIGNIFIES ADDITIONAL BMP'S REQUIRED FOR WORK WITHIN 50 OF WATER OF THE STATE. ** SIGNIFIES BMP THAT WILL BE INSTALLED PRIOR TO ANY GROUND DISTURBING ACTIVITY.

RATIONALE STATEMENT

A COMPREHENSIVE LIST OF AVAILABLE BEST MANAGEMENT PRACTICES (BMP) OPTIONS BASED ON DEQ'S GUIDANCE MANUAL HAS BEEN REVIEWED TO COMPLETE THIS EROSION AND SEDIMENT CONTROL PLAN. SOME OF THE ABOVE LISTED BMP'S WERE NOT CHOSEN BECAUSE THEY WERE DETERMINED TO NOT EFFECTIVELY MANAGE EROSION PREVENTION AND SEDIMENT CONTROL FOR THIS PROJECT BASED ON SPECIFIC SITE CONDITIONS, INCLUDING SOIL CONDITIONS TOPOGRAPHIC CONSTRAINTS, ACCESSIBILITY TO THE SITE, AND OTHER RELATED CONDITIONS, AS THE PROJECT PROGRESSES AND THERE IS A NEED TO REVISE THE ESC PLAN, AN ACTION PLAN WILL BE SUBMITTED.


		INITIAL	•	
PERMITTEE'S	SITE INSPEC	TOR: IBD		
PHONE:				
DESCRIPTION OF EXI	Perience:			

SHEET INDEX

EROSION AND SEDIMENT CONTROL PLANS

- CO.O EROSION AND SEDIMENT CONTROL COVER SHEET
- CO.1 CLEARING AND DEMOLITION EROSION AND SEDIMENT CONTROL PLAN
- CO.2 GRADING AND UTILITY CONSTRUCTION EROSION AND SEDIMENT CONTROL PLAN
- CO.3 EROSION AND SEDIMENT CONTROL DETAILS

REVISIONS: EROSION AND SEDIMENT CONTROL COVER SHEET

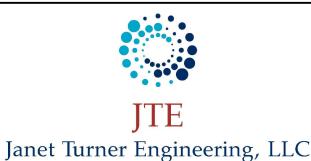

PREPARED FOR: CLEAN WATER SERVICES 2550 SW HILLSBORO HIGHWAY HILLSBORO, OR 97123 PHONE: 503-681-3600 FAX: 503-681-3603

DRAWING NO.:

AWS

SUNSET HIGH SCHOOL


WASHINGTON COUNTY

OREGON WASHINGTON COUNTY TAX MAP 1N133B




DATE: MARCH 10, 2020

JOB NUMBER XXXX SHEET

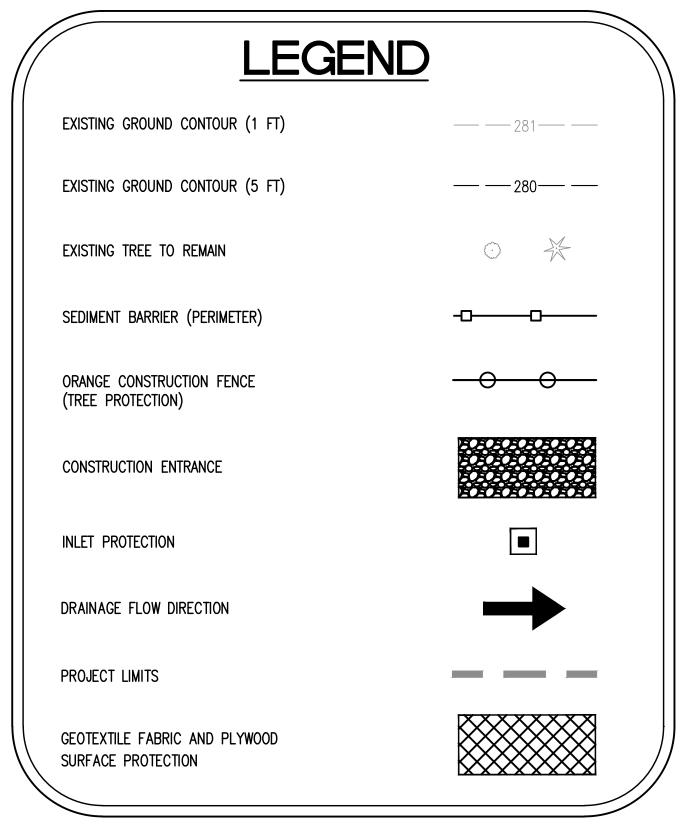

THESE EROSION AND SEDIMENT CONTROL PLANS ASSUME "DRY WEATHER" CONSTRUCTION. "WET WEATHER" CONSTRUCTION MEASURES NEED TO BE APPLIED BETWEEN OCTOBER 1ST AND MAY 31ST.

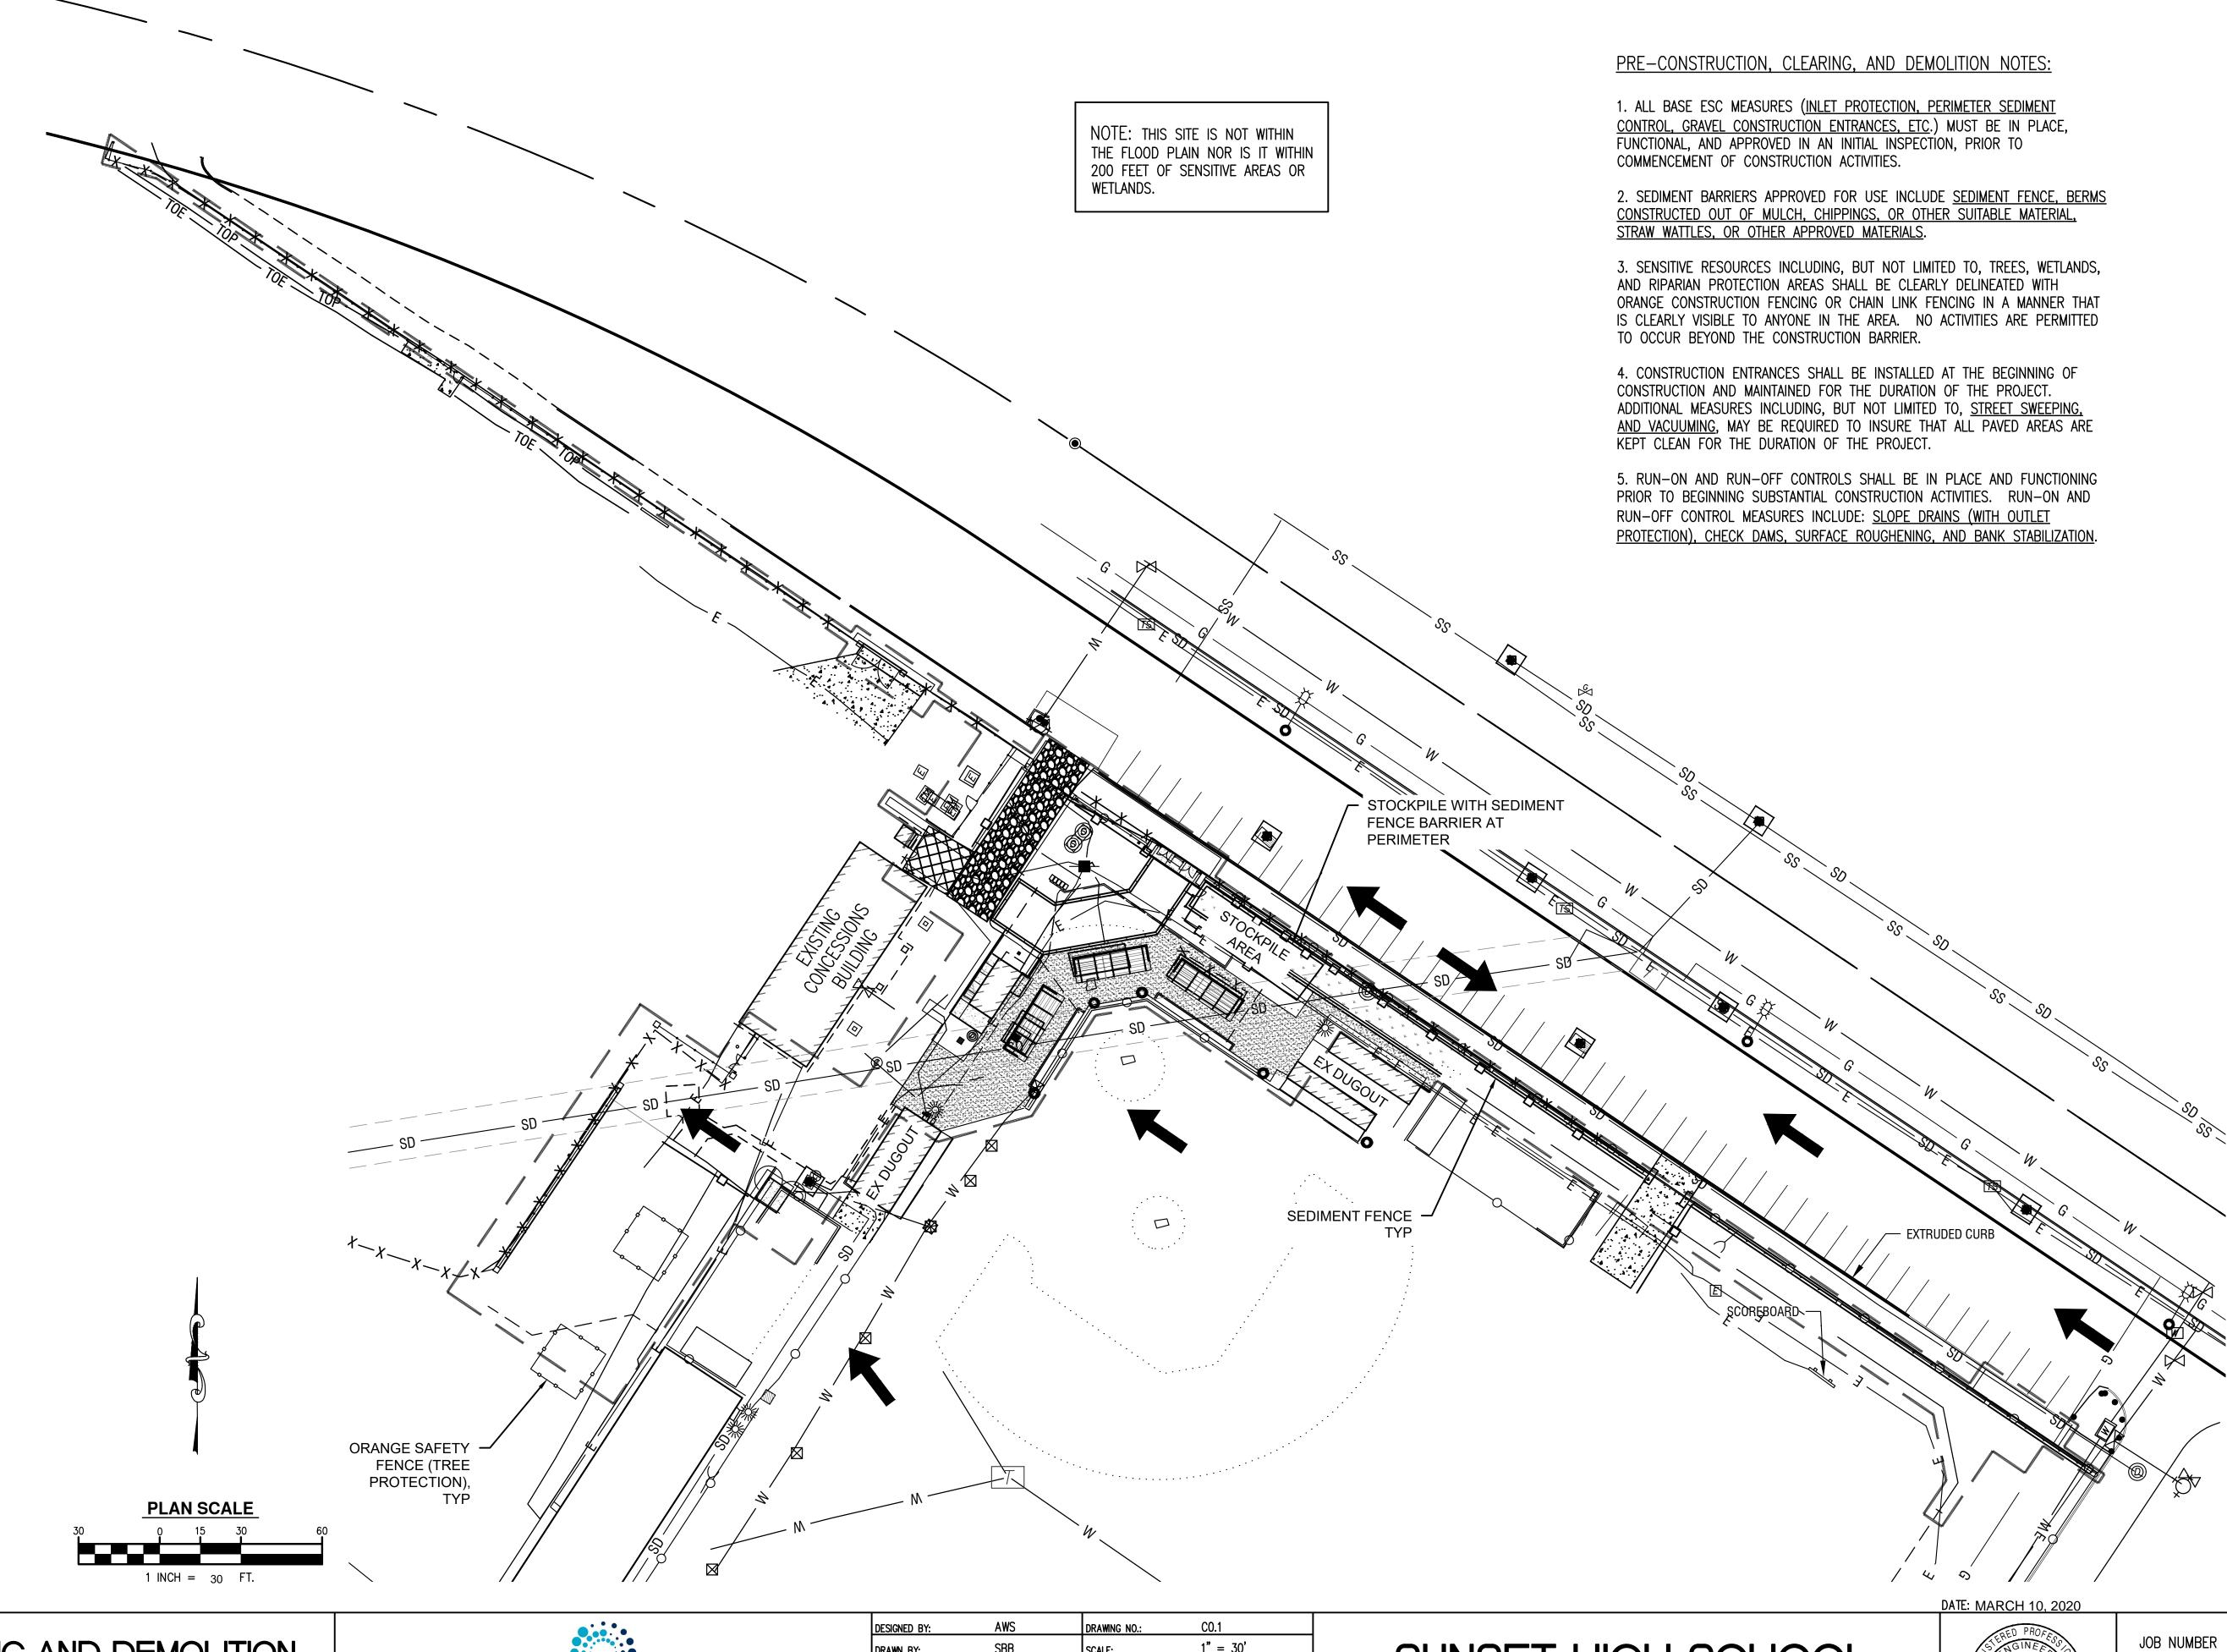

REVISIONS: CLEARING AND DEMOLITION, **EROSION AND** SEDIMENT CONTROL PLAN



DESIGNED BY:	AWS	DRAWING NO.:	C0.1	
DRAWN BY:	SBB	SCALE:	1" = 30'	
CHECKED BY:	JTE			SUNSET HIGH
PRE	PARED FO	2550 S HILLSBO PHONE:	WATER SERVICES W HILLSBORO HIGHWAY DRO, OR 97123 503-681-3600 03-681-3603	WASHINGTON COUNTY TAX LOTS 1300


SUNSET HIGH SCHOOL



OREGON WASHINGTON COUNTY TAX MAP 1N133BC

XXXX

SHEET CO.1

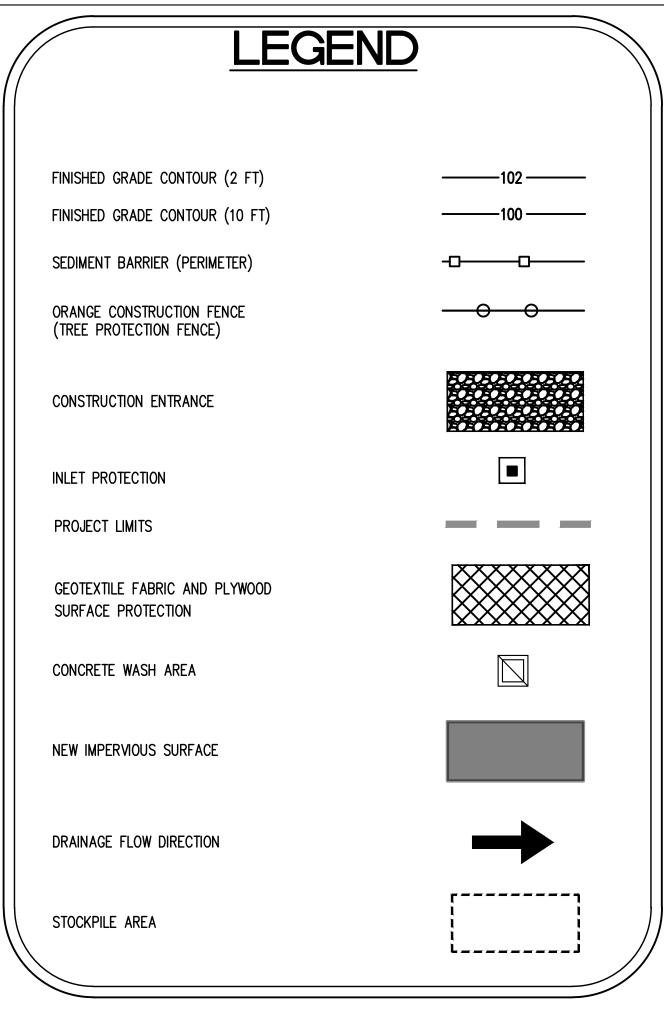

THESE EROSION AND SEDIMENT CONTROL PLANS ASSUME "DRY WEATHER" CONSTRUCTION. "WET WEATHER" CONSTRUCTION MEASURES NEED TO BE APPLIED BETWEEN OCTOBER 1ST AND MAY 31ST.

EROSION AND SEDIMENT CONTROL BMP IMPLEMENTATION:

- 1. ALL BASE ESC MEASURES (INLET PROTECTION, PERIMETER SEDIMENT CONTROL, GRAVEL CONSTRUCTION ENTRANCES, ETC.) MUST BE IN PLACE, FUNCTIONAL, AND APPROVED IN AN INITIAL INSPECTION, PRIOR TO COMMENCEMENT OF CONSTRUCTION ACTIVITIES.
- 2. MAJORITY OF SITE EARTHWORK OPERATIONS SHALL BE PLACEMENT OF IMPORTED FILL MATERIAL, WITH LIMITED EXCAVATION/CUT. STOCKPILE AREA WILL BE LIMITED IN SIZE AND NOT REQUIRE RELOCATION.
- 3. ALL "SEDIMENT BARRIERS (TO BE INSTALLED AFTER GRADING)" SHALL BE INSTALLED IMMEDIATELY FOLLOWING ESTABLISHMENT OF FINISHED GRADE AS SHOWN ON THESE PLANS.
- 4. LONG TERM SLOPE STABILIZATION MEASURES "INCLUDING MATTING" SHALL BE IN PLACE OVER ALL EXPOSED SOILS BY OCTOBER 1.
- 5. ALL STORMWATER FACILITIES SHALL BE CONSTRUCTED AND LANDSCAPED PRIOR TO THE STORM WATER SYSTEM FUNCTIONING AND SITE PAVING.
- 6. INLET PROTECTION SHALL BE IN-PLACE IMMEDIATELY FOLLOWING PAVING

WET WEATHER EROSION CONTROL NOTE:

PLAN SCALE

FUNCTIONAL.

ON SEPTEMBER 1ST OF EACH YEAR, IF THERE ARE EXPOSED SOILS, DISTURBED AREAS, OR GROUND-COVER VEGETATION NOT FULLY ESTABLISHED SUFFICIENT TO PREVENT EROSION, A SPECIFIC 1. SEED USED FOR TEMPORARY OR PERMANENT SEEDING SHALL BE EROSION CONTROL PLAN SHALL BE PREPARED BASED ON THE EXISTING AND EXPECTED SITE CONDITIONS USING THE WET WEATHER EROSION PREVENTION MEASURES (SEE EROSION PREVENTION AND SEDIMENT CONTROL PLANNING AND DESIGN MANUAL CHAPTER 4 FOR REQUIREMENTS). FOR SURFACE WATER FACILITIES, FIBER MATTING SHALL BE INSTALLED IN ALL AREAS EXPOSED TO WATER FLOW OR INUNDATION: FREE-FLOATING MULCH SHALL NOT BE USED IN AREAS SUBJECT TO INUNDATION. FIBER MATTING SHALL EITHER BE SEEDED (PER THE DESIGN) OR PLACED PRIOR TO PLANTING OF PLUGS, CUTTINGS, REEDS, RUSHES, OR SHRUBS. ALL MEASURES AND SPECIFICATIONS FOR MATERIALS USED SHALL BE PER PLAN OR AS SPECIFICALLY APPROVED BY THE ENGINEER AND CITY INSPECTOR. IF ANY ADDITIONAL AREAS BECOME EXPOSED, DISTURBED, OR STRIPPED OF VEGETATION BETWEEN OCTOBER 1ST AND MAY 31ST, THE PLAN SHALL BE REVISED OR OTHERWISE EXPANDED PER THE STANDARDS AND AS DIRECTED BY THE ENGINEER AND CITY INSPECTOR. PRIOR TO OCTOBER 1ST OF EACH YEAR, WET WEATHER MEASURES SHALL BE INSTALLED AND FULLY


GRADING AND UTILITY EROSION AND SEDIMENT **CONSTRUCTION NOTES:**

- COMPOSED OF ONE OF THE FOLLOWING MIXTURES, UNLESS OTHERWISE
 - A. VEGETATED CORRIDOR AREAS REQUIRE NATIVE SEED MIXES. SEE RESTORATION PLAN FOR APPROPRIATE SEED MIX. B. DWARF GRASS MIX (MIN. 100 LB./AC.)
 - 1. DWARF PERENNIAL RYEGRASS (80% BY WEIGHT)
 - 2. CREEPING RED FESCUE (20% BY WEIGHT) C. STANDARD HEIGHT GRASS MIX (MIN. 100LB./AC.)
 - 1. ANNUAL RYEGRASS (40% BY WEIGHT) 2. TURF-TYPE FESCUE (60% BY WEIGHT)
- 2. SLOPE TO RECEIVE TEMPORARY OR PERMANENT SEEDING SHALL HAVE THE SURFACE ROUGHENED BY MEANS OF TRACK-WALKING OR THE USE OF OTHER APPROVED IMPLEMENTS. SURFACE ROUGHENING IMPROVES SEED BEDDING AND REDUCES RUN-OFF VELOCITY.
- 3. LONG TERM SLOPE STABILIZATION MEASURES SHALL INCLUDE THE - ESTABLISHMENT OF PERMANENT VEGETATIVE COVER VIA SEEDING WITH APPROVED MIX AND APPLICATION RATE.
- 4. TEMPORARY SLOPE STABILIZATION MEASURES SHALL INCLUDE: COVERING EXPOSED SOIL WITH PLASTIC SHEETING, STRAW MULCHING, WOOD CHIPS, OR OTHER APPROVED MEASURES.

- 5. STOCKPILED SOIL OR STRIPPINGS SHALL BE PLACED IN A STABLE LOCATION AND CONFIGURATION. DURING "WET WEATHER" PERIODS. STOCKPILES SHALL BE COVERED WITH PLASTIC SHEETING OR STRAW MULCH. SEDIMENT FENCE IS REQUIRED AROUND THE PERIMETER OF THE STOCKPILE.
- 6. EXPOSED CUT OR FILL AREAS SHALL BE STABILIZED THROUGH THE USE OF TEMPORARY SEEDING AND MULCHING, EROSION CONTROL BLANKETS OR MATS, MID-SLOPE SEDIMENT FENCES OR WATTLES, OR OTHER APPROPRIATE MEASURES. SLOPES EXCEEDING 25% MAY REQUIRE ADDITIONAL EROSION CONTROL MEASURES.
- 7. AREAS SUBJECT TO WIND EROSION SHALL USE APPROPRIATE DUST CONTROL MEASURES INCLUDING THE APPLICATION OF A FINE SPRAY OF WATER, PLASTIC SHEETING, STRAW MULCHING, OR OTHER APPROVED MEASURES.
- 8. CONSTRUCTION ENTRANCES SHALL BE INSTALLED AT THE BEGINNING OF CONSTRUCTION AND MAINTAINED FOR THE DURATION OF THE PROJECT. ADDITIONAL MEASURES INCLUDING, BUT NOT LIMITED TO, TIRE WASHES, STREET SWEEPING, AND VACUUMING MAY BE BE REQUIRED TO INSURE THAT ALL PAVED AREAS ARE KEPT CLEAN FOR THE DURATION OF THE PROJECT.
- 9. ACTIVE INLETS TO STORM WATER SYSTEMS SHALL BE PROTECTED THROUGH THE USE OF APPROVED INLET PROTECTION MEASURES. ALL INLET PROTECTION MEASURES ARE TO BE REGULARLY INSPECTED AND MAINTAINED AS NEEDED.

10. SATURATED MATERIALS THAT ARE HAULED OFF-SITE MUST BE TRANSPORTED IN WATER-TIGHT TRUCKS TO ELIMINATE SPILLAGE OF SEDIMENT AND SEDIMENT-LADEN WATER.

- 11. AN AREA SHALL BE PROVIDED FOR THE WASHING OUT OF CONCRETE TRUCKS IN A LOCATION THAT DOES NOT PROVIDE RUN-OFF THAT CAN ENTER THE STORM WATER SYSTEM. IF THE CONCRETE WASH-OUT AREA CAN NOT BE CONSTRUCTED GREATER THAN 50' FROM ANY DISCHARGE POINT, SECONDARY MEASURES SUCH AS BERMS OR TEMPORARY SETTLING PITS MAY BE REQUIRED. THE WASH-OUT SHALL BE LOCATED WITHIN SIX FEET OF TRUCK ACCESS AND BE CLEANED WHEN IT REACHES 50% OF THE CAPACITY.
- 12. SWEEPINGS FROM EXPOSED AGGREGATE CONCRETE SHALL NOT BE TRANSFERRED TO THE STORM WATER SYSTEM. SWEEPINGS SHALL BE PICKED UP AND DISPOSED IN THE TRASH.
- 13. AVOID PAVING IN WET WEATHER WHEN PAVING CHEMICALS CAN RUN-OFF INTO THE STORM WATER SYSTEM.
- 14. USE BMPs SUCH AS CHECK-DAMS, BERMS, AND INLET PROTECTION TO PREVENT RUN-OFF FROM REACHING DISCHARGE
- 15. COVER CATCH BASINS, MANHOLES, AND OTHER DISCHARGE POINTS WHEN APPLYING SEAL COAT, TACK COAT, ETC. TO PREVENT INTRODUCING THESE MATERIALS TO THE STORM WATER SYSTEM.

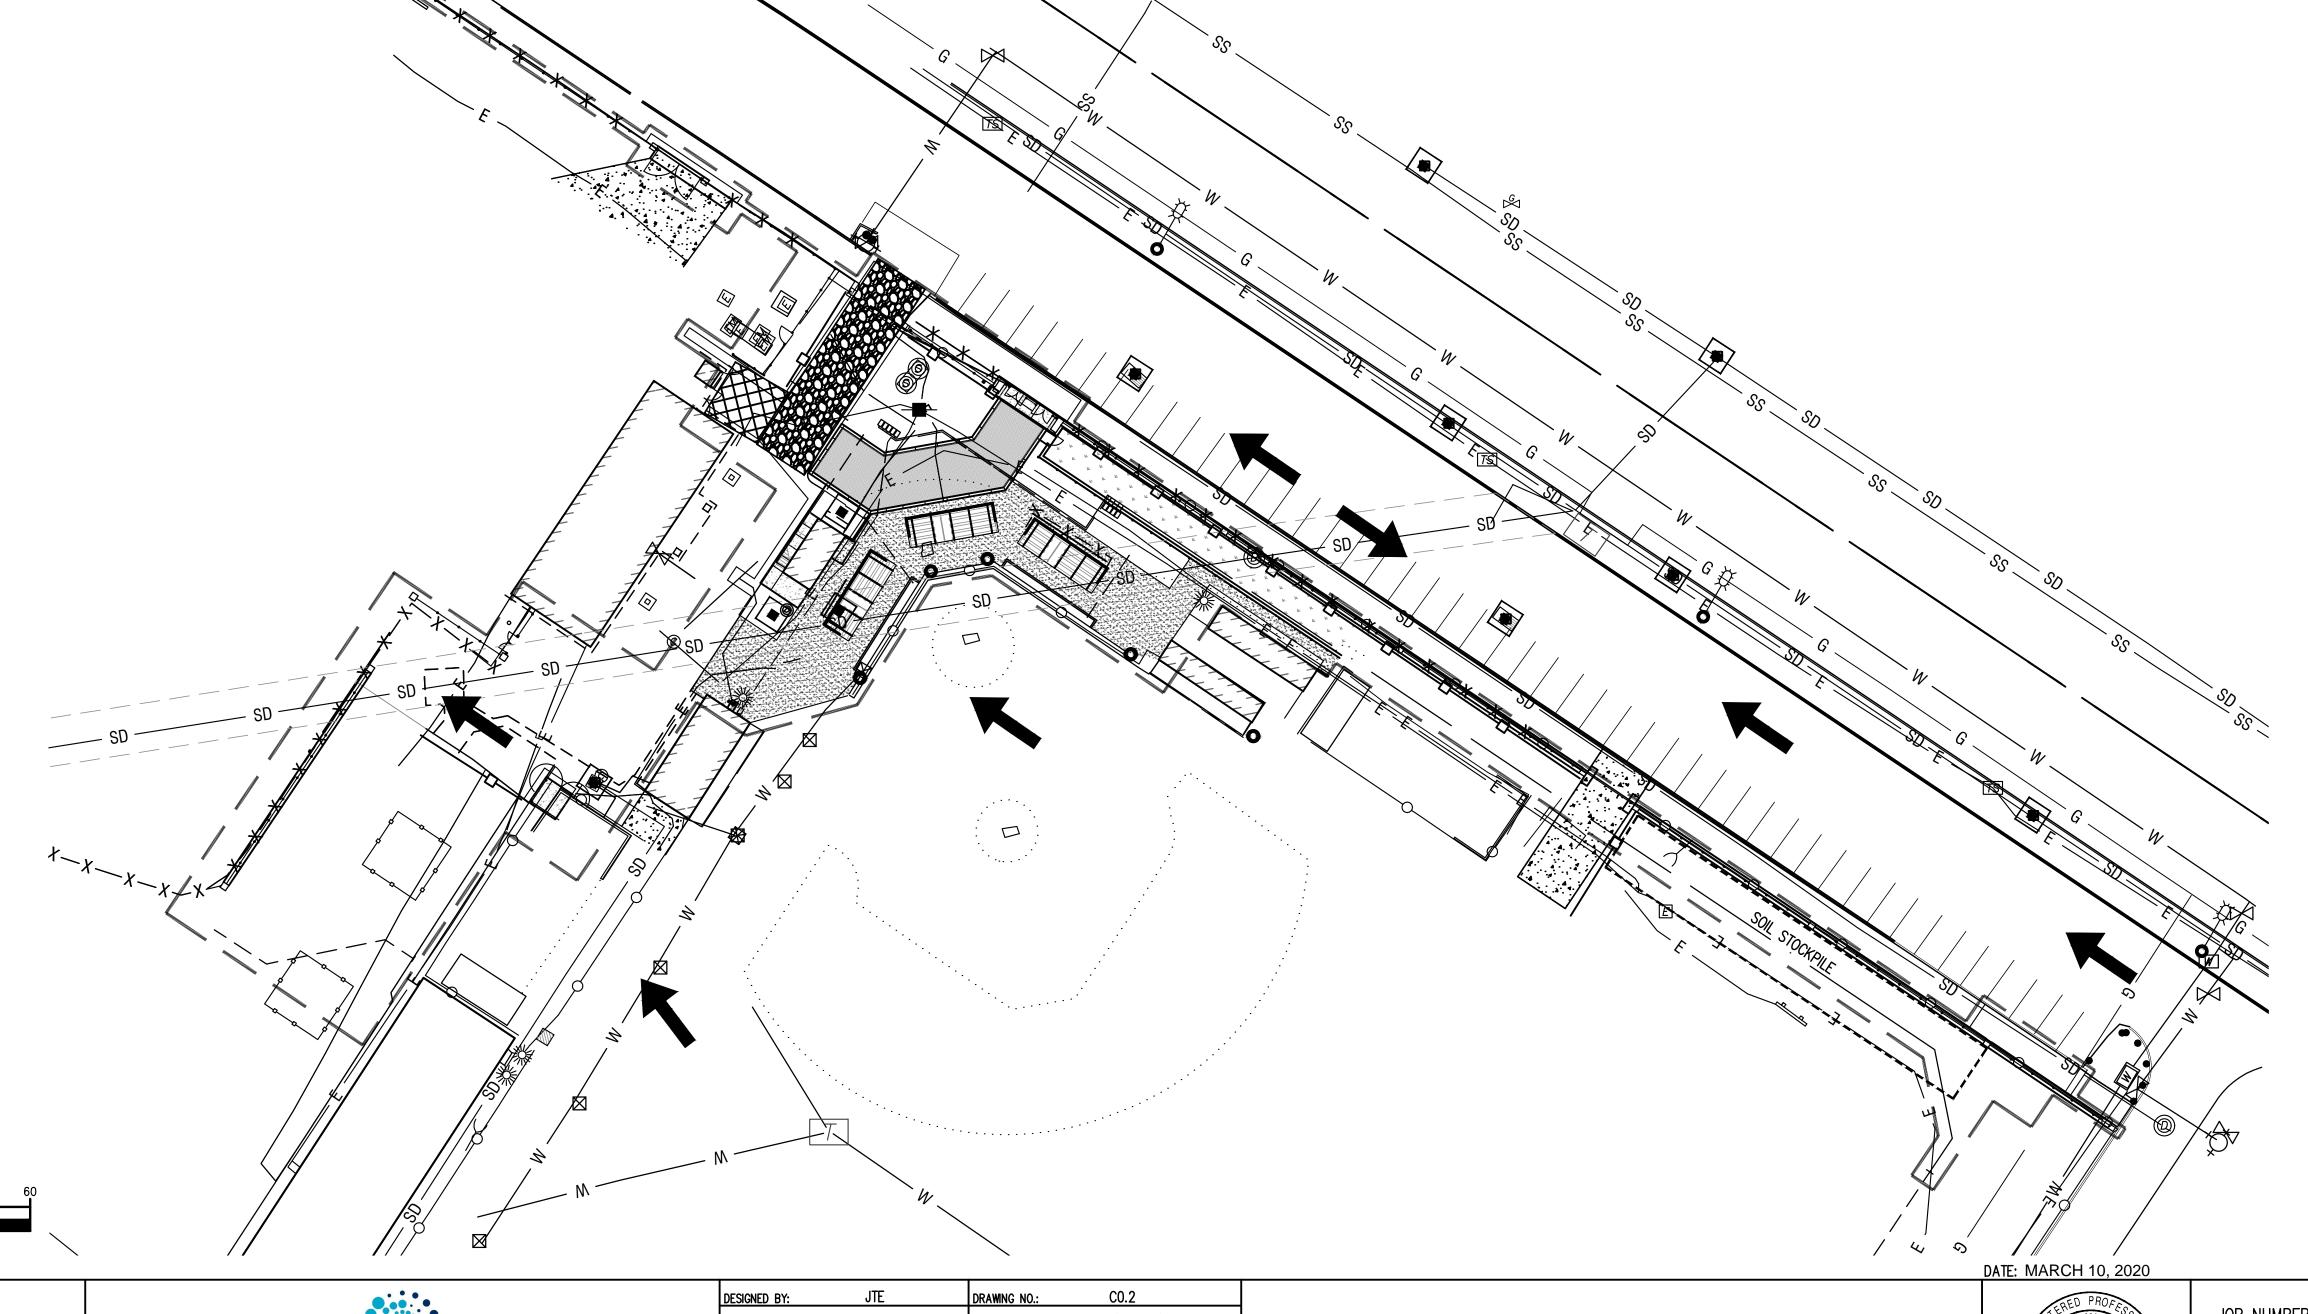

REVISIONS: GRADING AND UTILITY CONSTRUCTION EROSION AND SEDIMENT CONTROL PLAN



DESIGNED BY: DRAWN BY:	JTE SBB	DRAWNG NO.: SCALE:	C0.2 1" = 30'	
CHECKED BY:	JTE PARED FO		WATER SERVICES	SUNSET HIGH
		2550 S HILLSBC	W HILLSBORO HIGHWAY ORO, OR 97123 503-681-3600	WASHINGTON COUNTY

FAX: 503-681-3603

SUNSET HIGH SCHOOL




OREGON

WASHINGTON COUNTY TAX MAP 1N133E


JOB NUMBER XXXX


SHEET

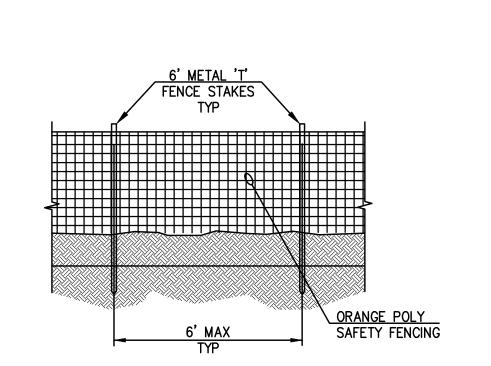



1. MAX SLOPE (PERPENDICULAR TO FENCE) - 1H:1V


2. INSTALL 10' UPHILL OF BIO BERM.

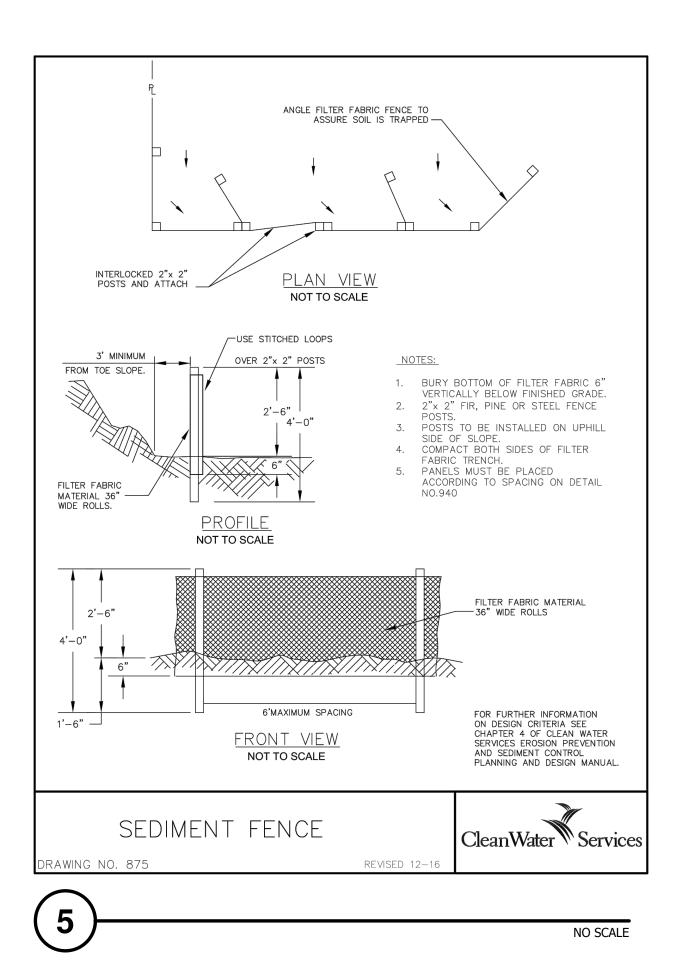

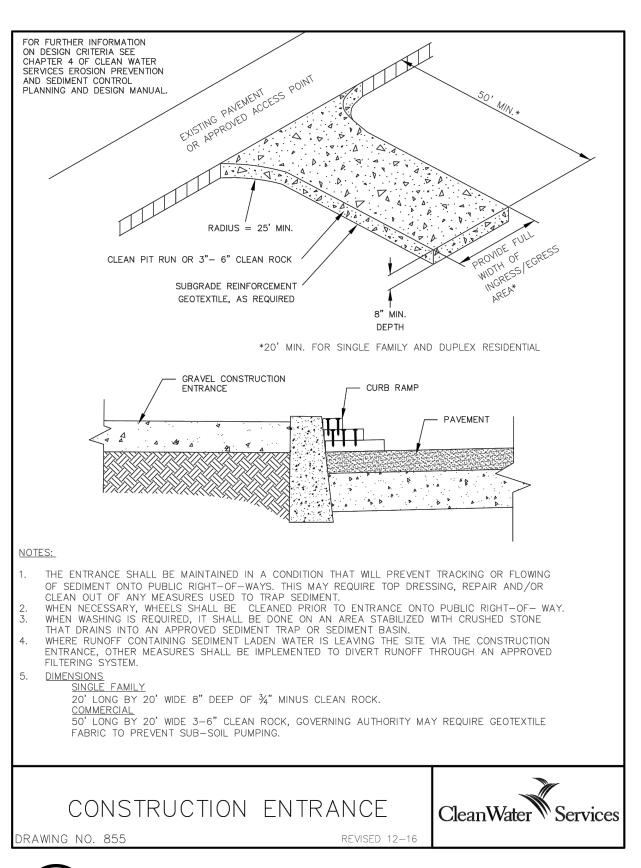


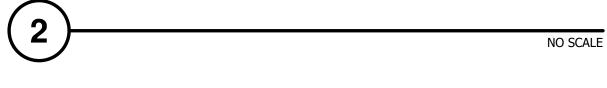

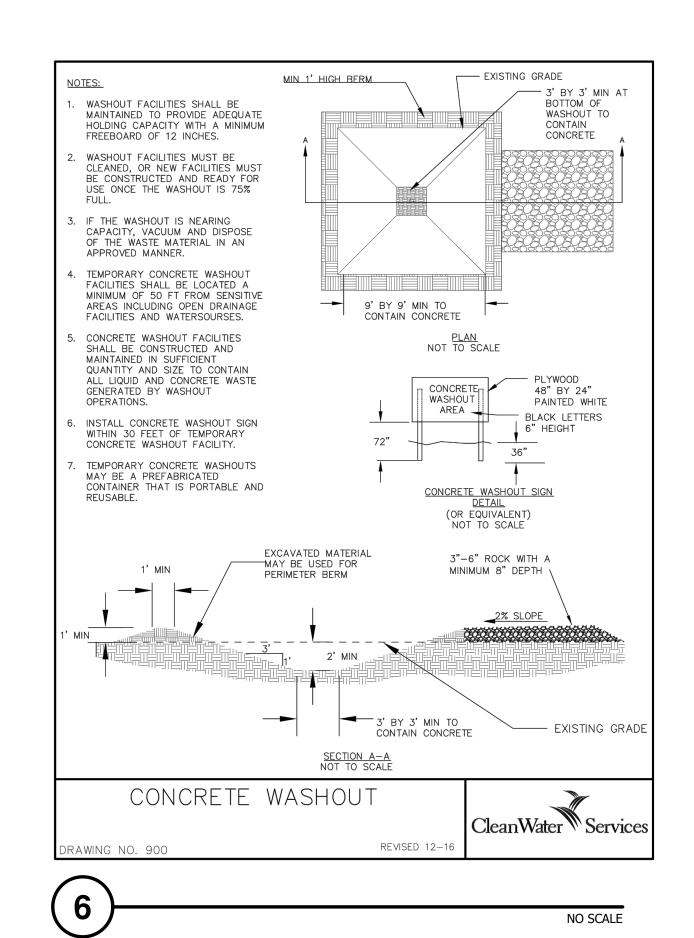

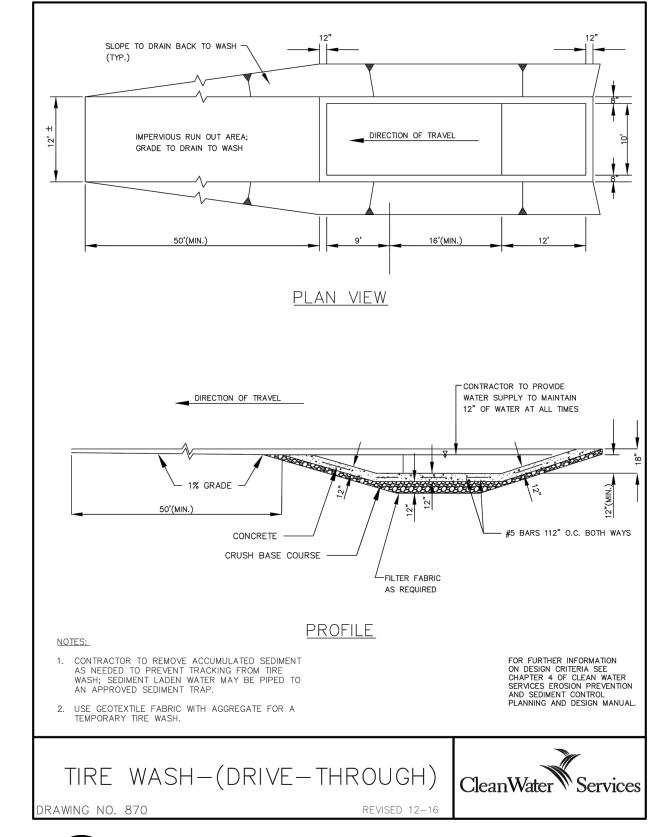

NO SCALE

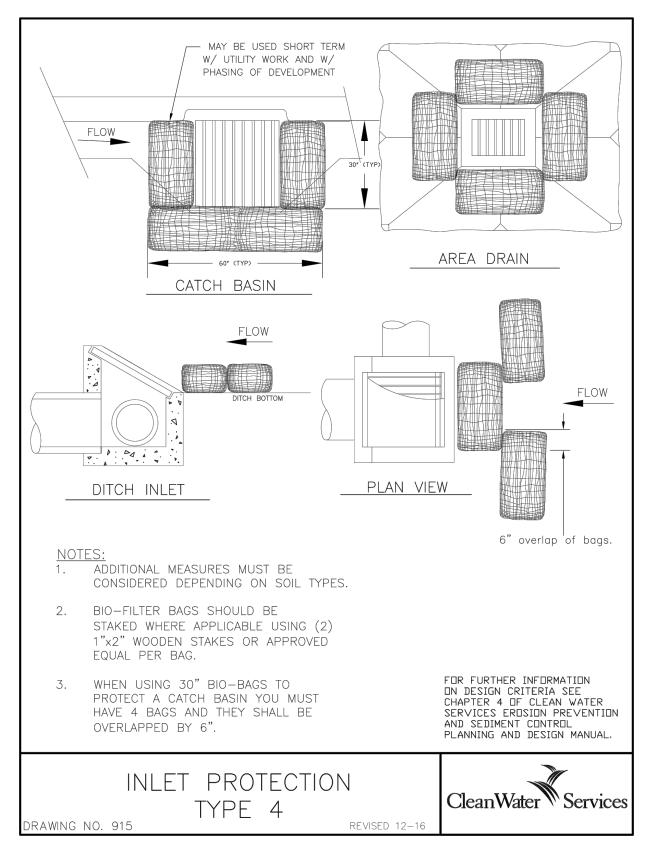

WHEN RAINFALL AND RUNOFF OCCURS, A KNOWLEDGEABLE AND EXPERIENCED PERSON IN THE PRINCIPLES, PRACTICES, INSTALLATION, AND MAINTENANCE OF EROSION AND SEDIMENT CONTROLS WHO WORKS FOR THE PERMITTEE MUST PROVIDE DAILY

INSPECTIONS OF THE EROSION AND SEDIMENT CONTROLS AND DISCHARGE OUTFALLS. . CONSTRUCTION ACTIVITIES MUST AVOID OR MINIMIZE EXCAVATION AND CREATION OF BARE GROUND FROM OCTOBER 1 THROUGH

MAY 31ST EACH YEAR.

- 3. DURING WET WEATHER PERIOD, TEMPORARY STABILIZATION OF THE SITE MUST OCCUR AT THE END OF EACH WORK DAY. SEDIMENT CONTROLS MUST BE INSTALLED AND MAINTAINED ON ALL DOWN GRADIENT SIDES OF THE CONSTRUCTION SITE AT ALL
- TIMES DURING CONSTRUCTION. THEY MUST REMAIN IN PLACE UNTIL PERMANENT VEGETATION OR OTHER PERMANENT COVERING OF . ALL ACTIVE INLETS MUST HAVE SEDIMENT CONTROLS INSTALLED AND MAINTAINED AT ALL TIMES DURING CONSTRUCTION. UNLESS

OTHERWISE APPROVED, A SURFACE MOUNTED AND ATTACHABLE, U-SHAPED FILTER BAG IS REQUIRED FOR ALL CURB INLET CATCH


- SIGNIFICANT AMOUNTS OF SEDIMENT THAT LEAVES THE SITE MUST BE CLEANED UP WITHIN 24 HOURS AND PLACED BACK ON THE SITE AND STABILIZED OR PROPERLY DISPOSED. THE CAUSE OF THE SEDIMENT RELEASE MUST BE FOUND AND PREVENTED FROM CAUSING A RECURRENCE OF THE DISCHARGE WITHIN THE SAME 24 HOURS. ANY IN-STREAM CLEAN UP OF SEDIMENT SHALL BE
- PREFORMED ACCORDING TO THE OREGON DEPARTMENT OF STATE LANDS REQUIRED TIME FRAME. SEDIMENT MUST NOT BE INTENTIONALLY WASHED INTO STORM SEWERS, DRAINAGE WAYS, OR WATER BODIES.
- 8. SEDIMENT MUST BE REMOVED FROM BEHIND ALL SEDIMENT CONTROL MEASURES WHEN IT HAS REACHED A HEIGHT OF 1/3-RD THE BARRIER HEIGHT AND PRIOR TO THE CONTROL MEASURES REMOVAL.
- 9. CLEANING OF ALL STRUCTURES WITH SUMPS MUST OCCUR WHEN THE SEDIMENT RETENTION CAPACITY HAS BEEN REDUCED BY 50% AND AT COMPLETION OF PROJECT. 10. ANY USE OF TOXIC OR OTHER HAZARDOUS MATERIALS MUST INCLUDE PROPER STORAGE, APPLICATION, AND DISPOSAL.
- 11. THE PERMITTEE MUST PROPERLY MANAGE HAZARDOUS WASTES, USED OILS, CONTAMINATED SOILS, CONCRETE WASTE, SANITARY WASTE, LIQUID WASTE, OR OTHER TOXIC SUBSTANCES DISCOVERED OR GENERATED DURING CONSTRUCTION.
- 12. THE APPLICATION RATE OF FERTILIZERS USED TO REESTABLISH VEGETATION MUST FOLLOW MANUFACTURER'S RECOMMENDATIONS. NUTRIENT RELEASES FROM FERTILIZERS TO SURFACE WATERS MUST BE MINIMIZED. TIME RELEASE FERTILIZERS SHOULD BE USED AND
- CARE SHOULD BE MADE IN APPLICATION OF FERTILIZERS WITHIN ANY WATER WAY RIPARIAN ZONE. 13. OWNER OR DESIGNATED PERSON SHALL BE RESPONSIBLE FOR PROPER INSTALLATION AND MAINTENANCE OF ALL EROSION AND SEDIMENT CONTROL MEASURES, IN ACCORDANCE WITH CURRENT CLEAN WATER SERVICES STANDARDS AND STATE, AND FEDERAL
- 14. PRIOR TO ANY LAND DISTURBING ACTIVITIES, THE BOUNDARIES OF THE CLEARING LIMITS, VEGETATED BUFFERS, AND ANY SENSITIVE AREAS SHOWN ON THIS PLAN SHALL BE CLEARLY DELINEATED IN THE FIELD. UNLESS OTHERWISE APPROVED, NO DISTURBANCE IS PERMITTED BEYOND THE CLEARING LIMITS. THE OWNER/PERMITTEE MUST MAINTAIN THE DELINEATION FOR THE DURATION OF THE
- 5. PRIOR TO ANY LAND DISTURBING ACTIVITIES, THE BMPS THAT MUST BE INSTALLED ARE GRAVEL CONSTRUCTION ENTRANCE, PERIMETER SEDIMENT CONTROL, AND INLET PROTECTION. THESE BMPS MUST BE MAINTAINED FOR THE DURATION OF THE PROJECT. 16. IF VEGETATIVE SEED MIXES ARE SPECIFIED, SEEDING MUST TAKE PLACE NO LATER THAN SEPTEMBER 1ST; THE TYPE AND PERCENTAGES

PROJECT. NOTE: VEGETATED CORRIDORS TO BE DELINEATED WITH ORANGE CONSTRUCTION FENCE OR APPROVED EQUAL.

- OF SEED IN THE MIX ARE AS IDENTIFIED ON THE PLANS OR AS SPECIFIED BY THE DESIGN ENGINEER. 17. WATERTIGHT TRUCKS MUST BE USED TO TRANSPORT SATURATED SOILS FROM THE CONSTRUCTION SITE. AN APPROVED EQUIVALENT IS TO DRAIN THE SOIL ON SITE AT A DESIGNATED LOCATION USING APPROPRIATE BMPS; SOIL MUST BE DRAINED SUFFICIENTLY FOR
- 18. ALL PUMPING OF SEDIMENT LADEN WATER MUST BE DISCHARGED OVER AN UNDISTURBED, PREFERABLY VEGETATED AREA, AND
- THROUGH A SEDIMENT CONTROL BMP (I.E. FILTER BAG). 19. THE ESC PLAN MUST BE KEPT ONSITE. ALL MEASURES SHOWN ON THE PLAN MUST BE INSTALLED PROPERLY TO ENSURE THAT SEDIMENT LADEN WATER DOES NOT ENTER A SURFACE WATER SYSTEM, ROADWAY, OR OTHER PROPERTIES.
- 20. THE ESC MEASURES SHOWN ON THIS PLAN ARE THE MINIMUM REQUIREMENTS FOR ANTICIPATED SITE CONDITIONS. DURING THE CONSTRUCTION PERIOD, THESE MEASURES SHALL BE UPGRADED AS NEEDED TO MAINTAIN COMPLIANCE WITH ALL REGULATIONS.
- 21. WRITTEN ESC LOGS ARE SUGGESTED TO BE MAINTAINED ONSITE AND AVAILABLE TO DISTRICT INSPECTORS UPON REQUEST. 22. IN AREAS SUBJECT TO WIND EROSION, APPROPRIATE BMPS MUST BE USED WHICH MAY INCLUDE THE APPLICATION OF FINE WATER
- SPRAYING, PLASTIC SHEETING, MULCHING, OR OTHER APPROVED MEASURES. 23. ALL EXPOSED SOILS MUST BE COVERED DURING WET WEATHER PERIOD.

	EROSION CO SITES LESS		CleanWater
DRAWING NO. 945	ACRE	REVISED 12-16	

NO SCALE

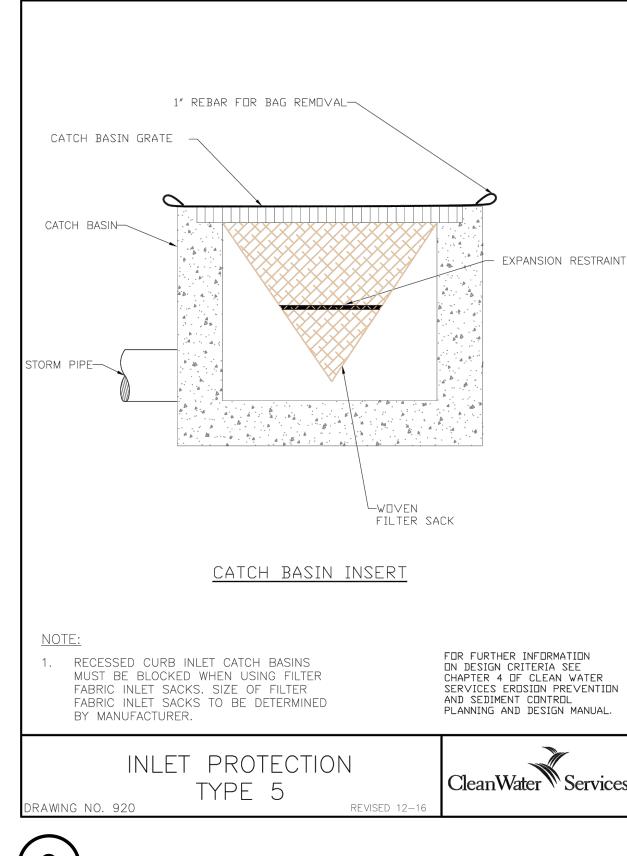


NO SCALE

NO SCALE

REVISIONS:

EROSION AND SEDIMENT CONTROL DETAILS

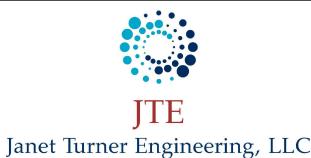

DESIGNED BY:	AWS	DRAWING NO	.: C0.3		
DRAWN BY:	SBB	SCALE:	AS NOTED		
CHECKED BY:	JTE				
PRE	PARED FOR:	CLEAN WATER SERVICES 2550 SW HILLSBORO HIGHWAY			
			.SBORO, OR 97123 ONE: 503-681-3600	W	

FAX: 503-681-3603


SUNSET HIGH SCHOOL

ASHINGTON COUNTY **OREGON** WASHINGTON COUNTY TAX MAP 1N133B0



JOB NUMBER XXXX SHEET

Services

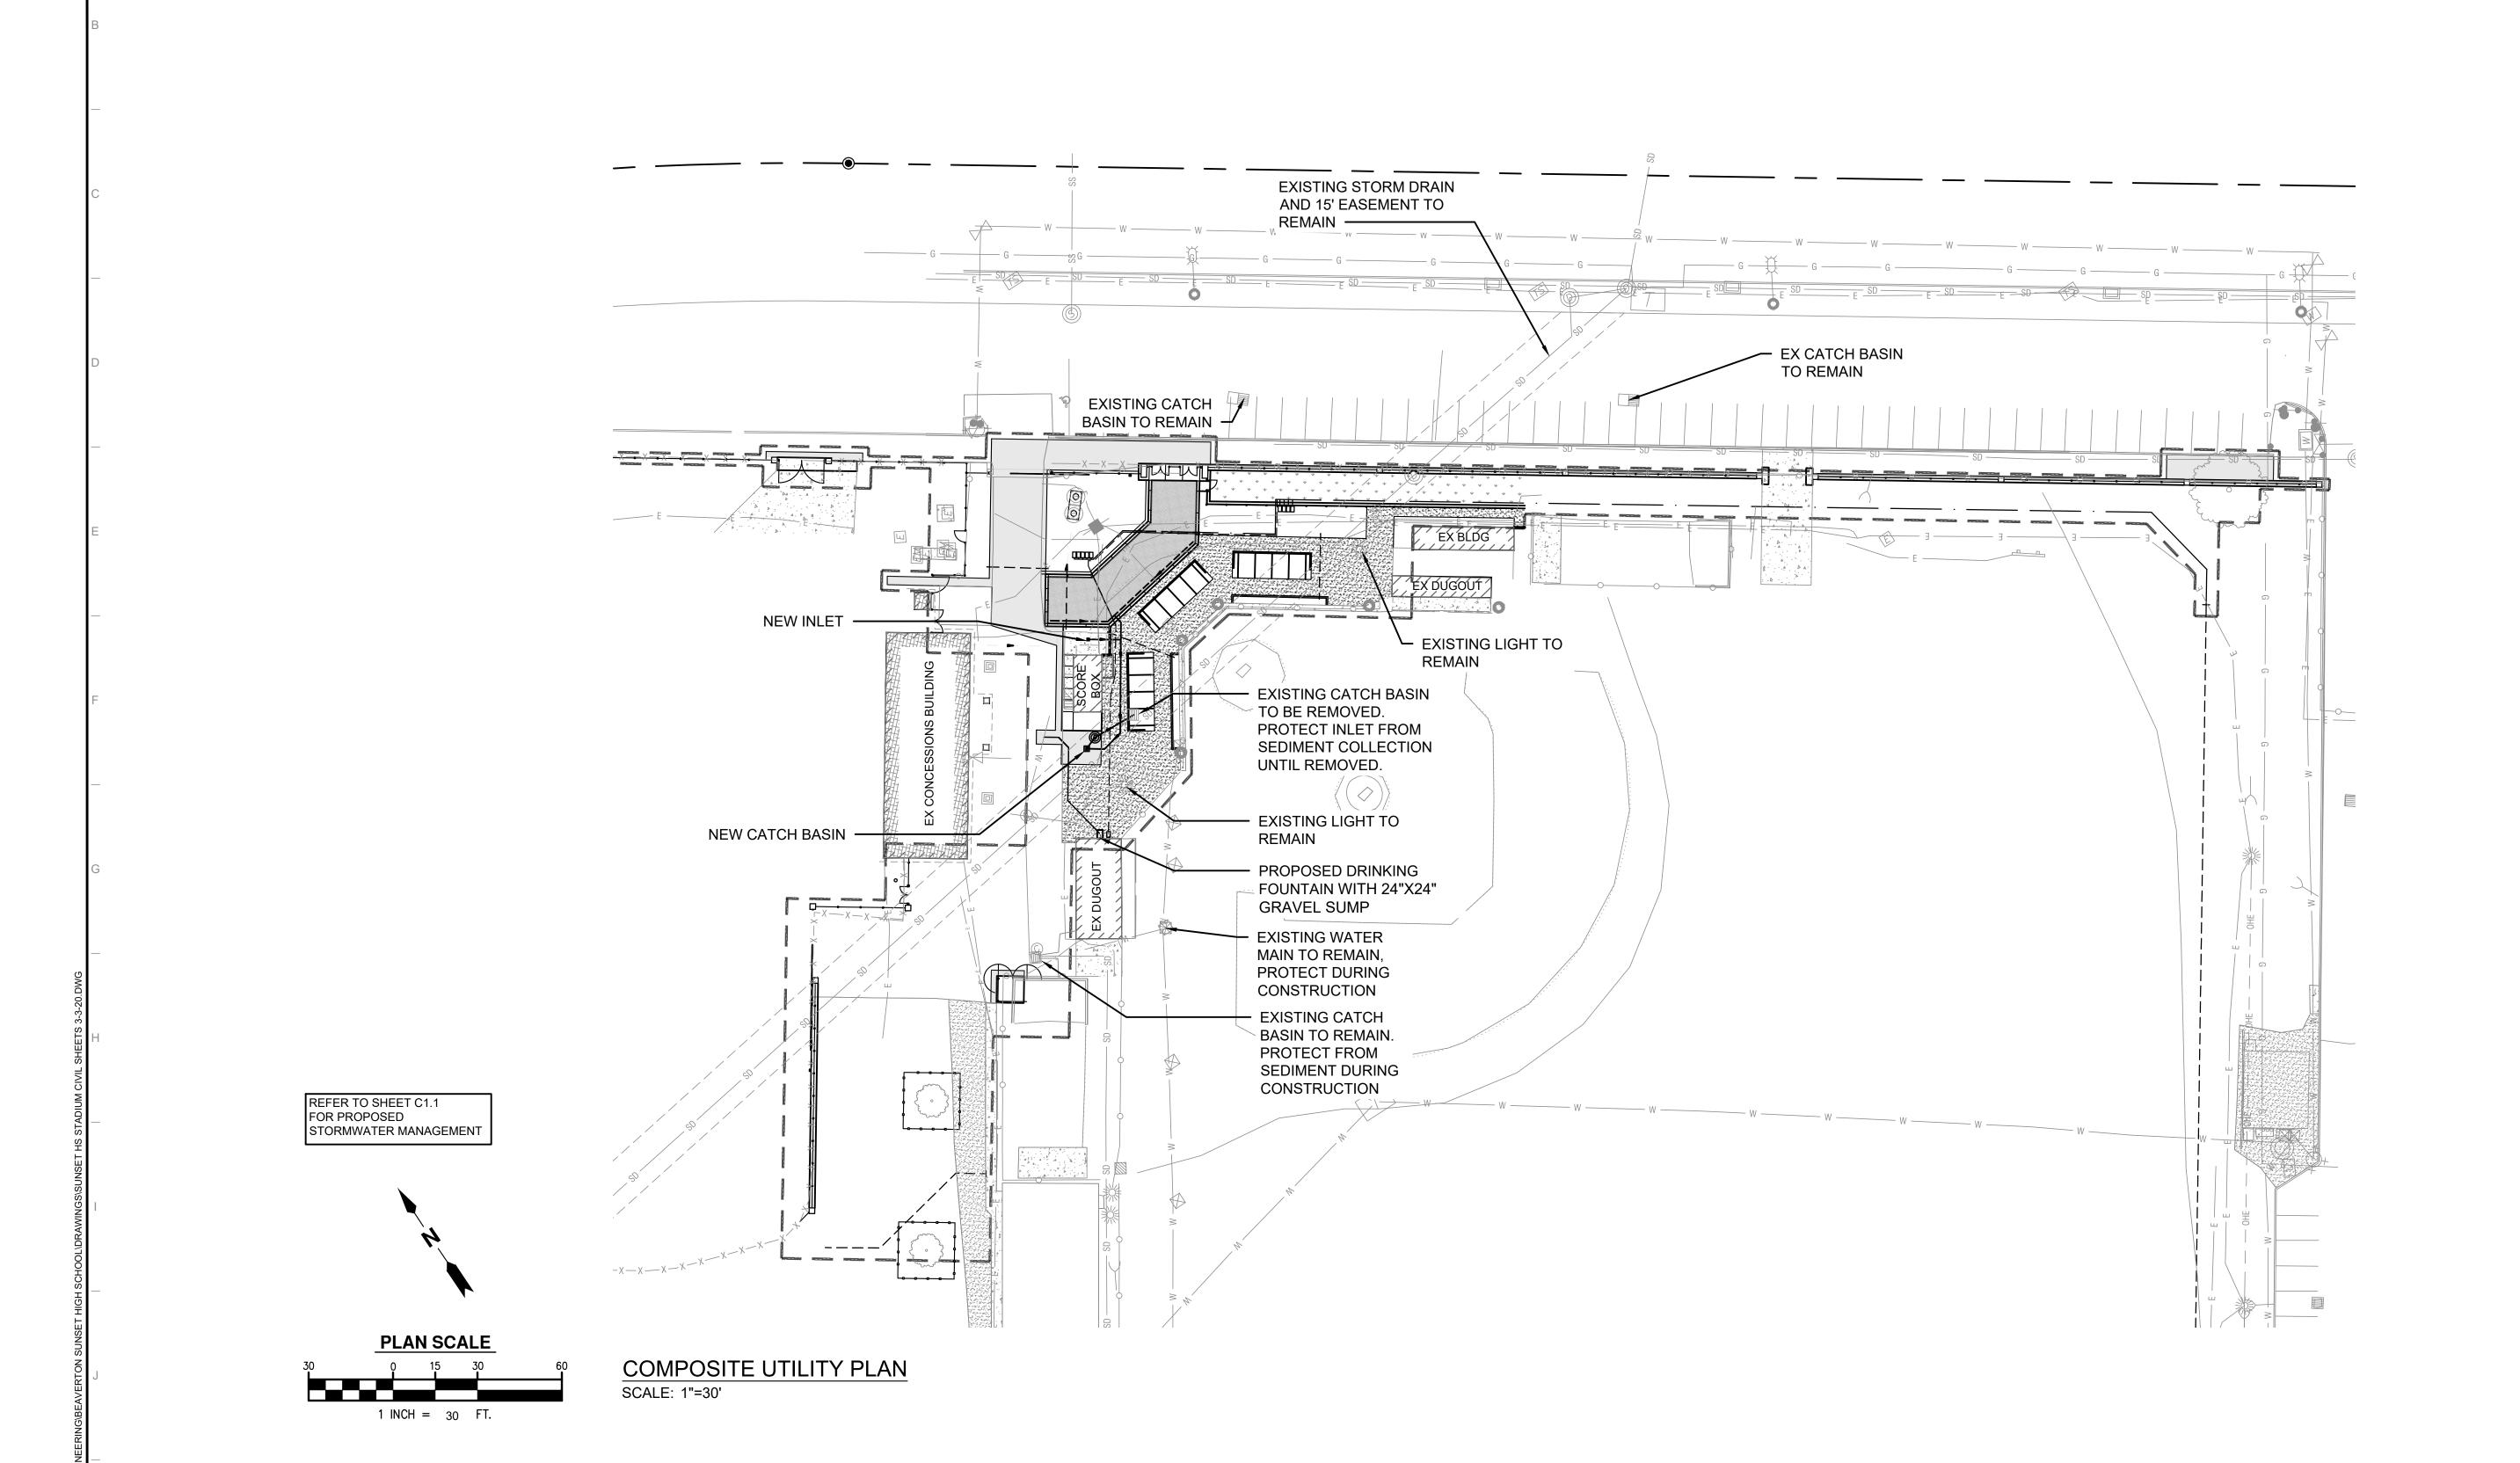



88685 Faulhaber Rd Elmira, OR 97437 541-654-1513 bugbeyla@gmail.com





IN SCHOOL DISTRICT
IIGH SCHOOL
SITE IMPROVEMENTS

CONSTRUCTION DRAWINGS
PERMIT AND BIDDING SET


ISSUE					
#	DESCRIPTI	ON	DATE		
1	BSD COM	BSD COMMENTS			
DATE		2/18/20			
PROJI	ECT NO.				
CAD E	WG FILE				
DDVW	/NI DV	A\A/C			

COMPOSITE UTILITY PLAN

CHECKED BY JLT

SC.

C1.0

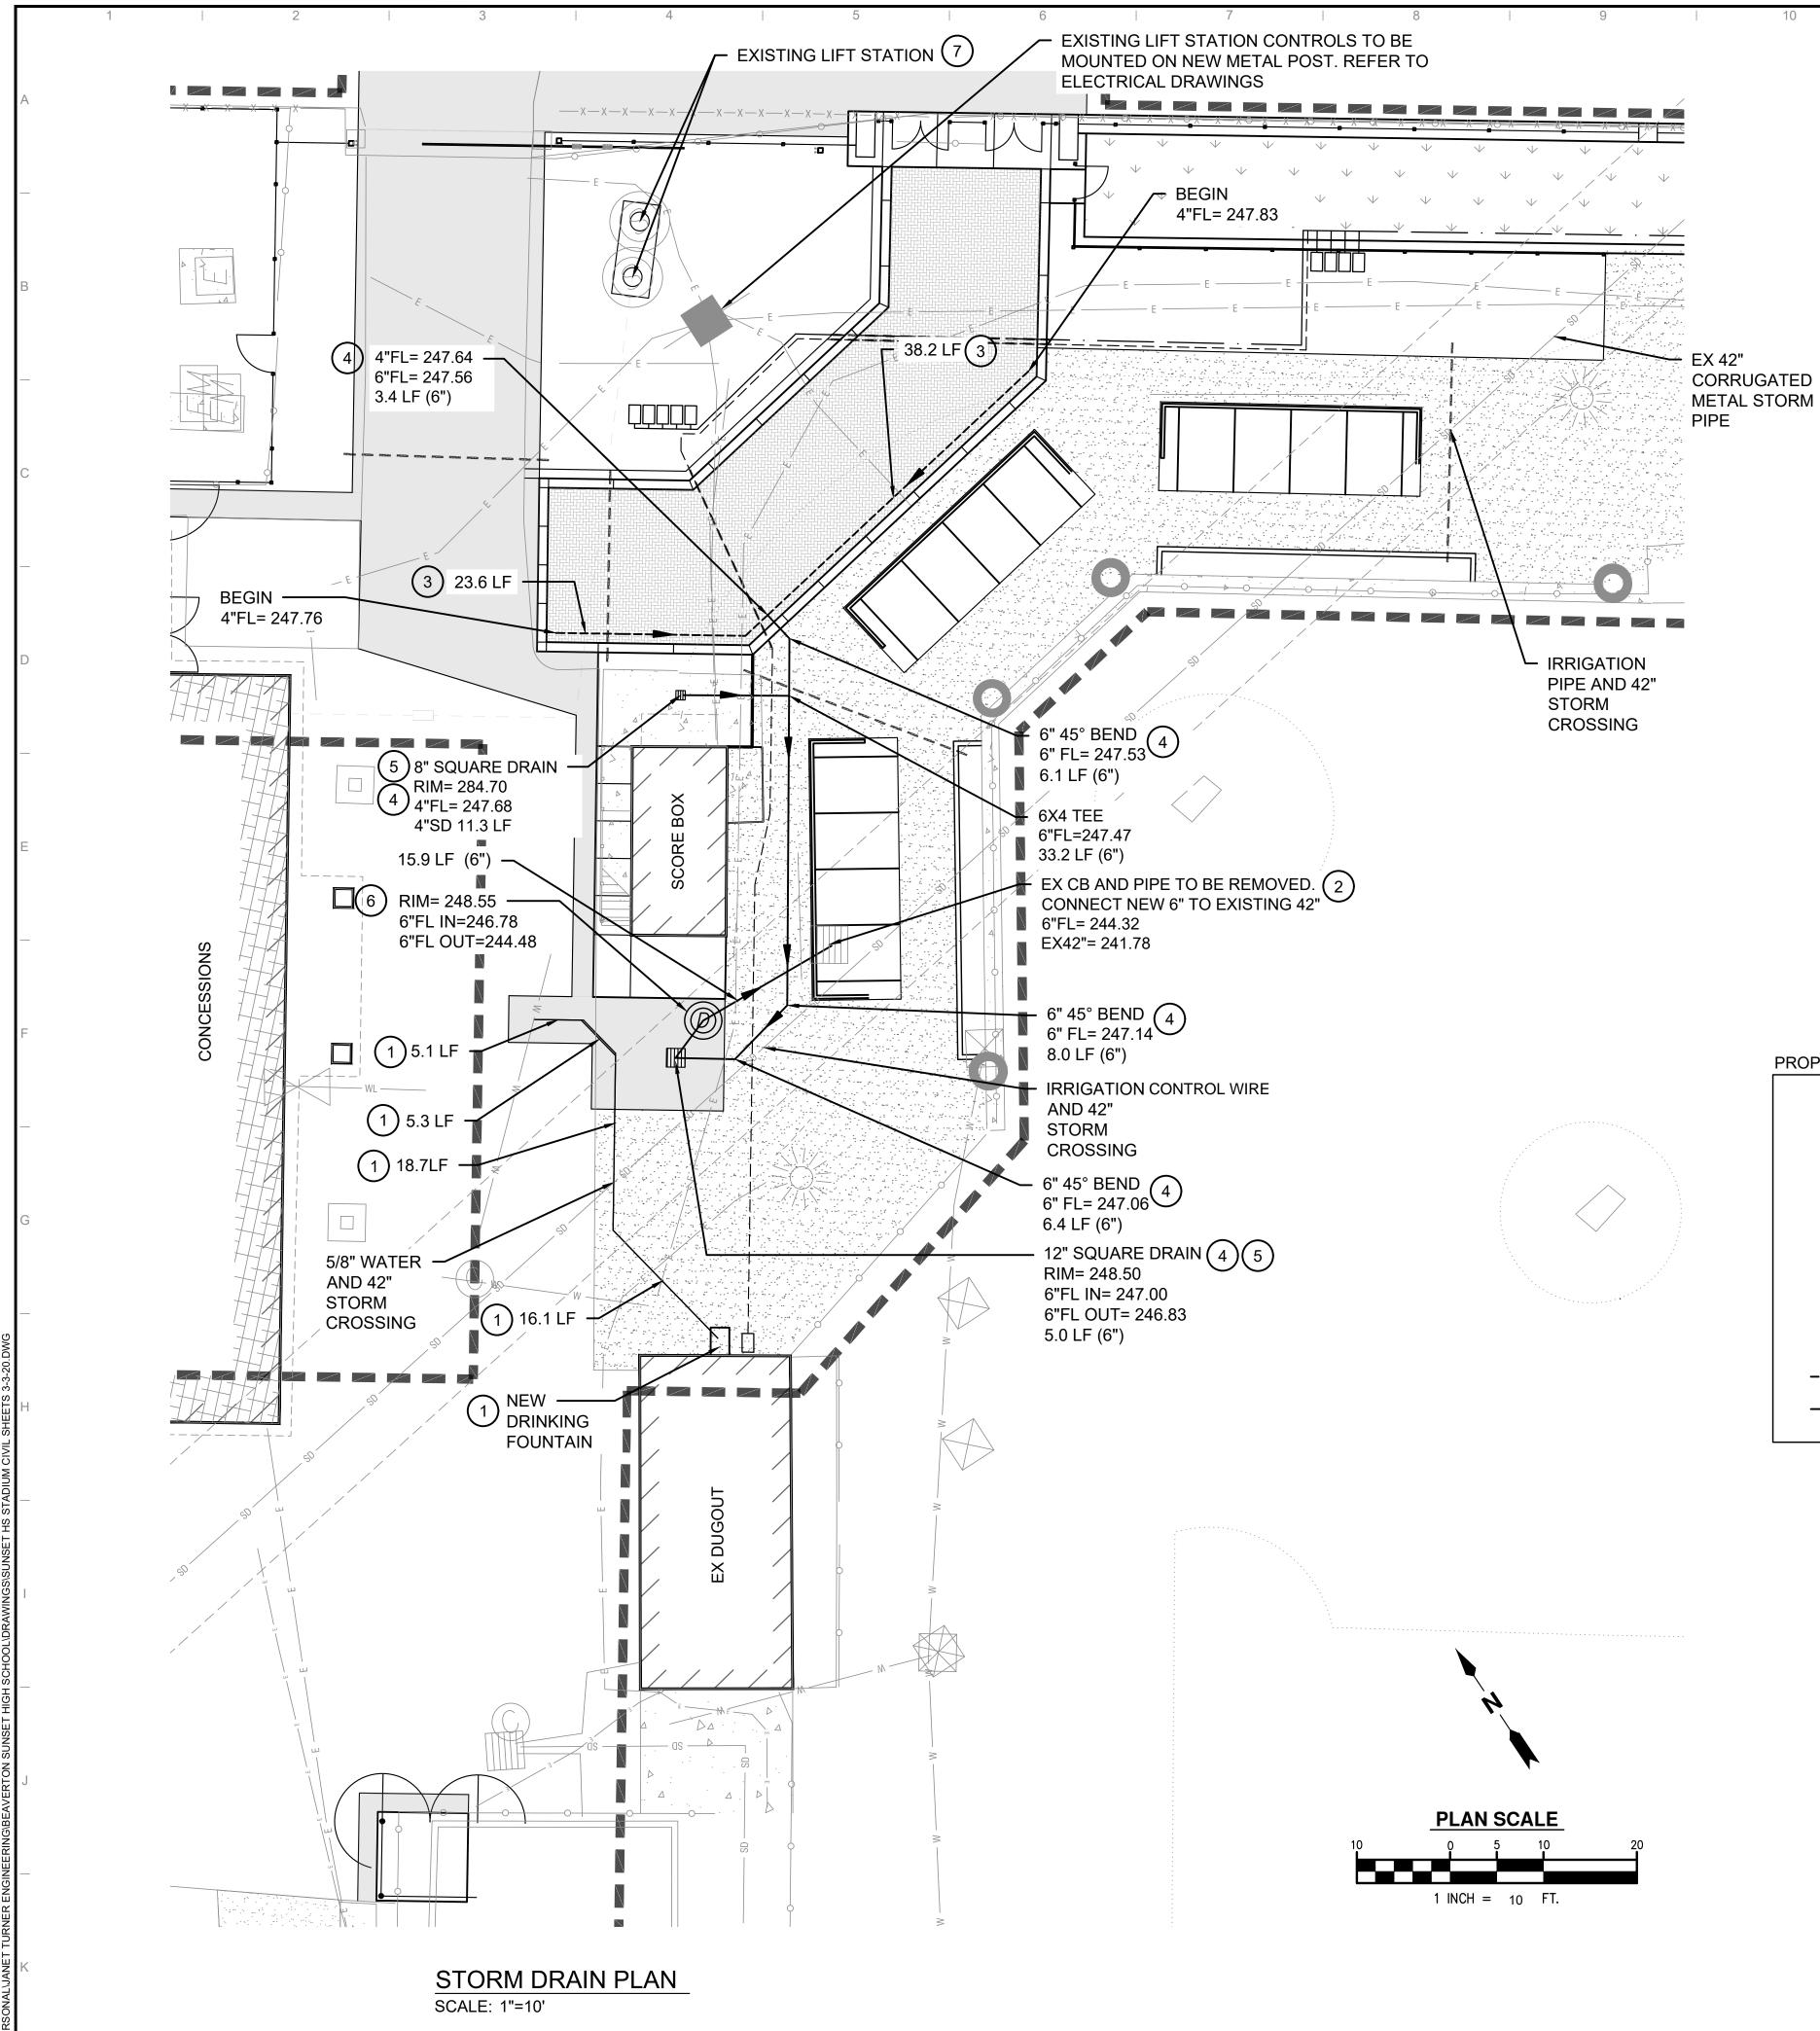

SHEET NOTES:

1. REFER TO LANDSCAPE PLANS AND SPECIFICATIONS FOR PERMEABLE PAVER MATERIALS AND CONSTRUCTION.

CONSTRUCTION NOTES:

- 1. NEW DRINKING FOUNTAIN, REFER TO LANDSCAPE ARCHITECTURAL PLANS. NEW $\frac{5}{8}$ " WATER SUPPLY AS SHOWN. POTHOLE AND EXPOSE EXISTING WATER MAIN AT PROPOSED CONNECTION LOCATION TO CONFIRM PIPE SIZE, LOCATION AND DEPTH AT LEAST 5 DAYS PRIOR TO START OF WATERLINE CONSTRUCTION.
- REMOVE EXISTING CATCH BASIN AND EXPOSE FITTING TO EX 42" STORM MAIN. CONTRACTOR SHALL CONFIRM PIPE LOCATION, DEPTH, SIZE AND CONDITION AT LEAST 5 DAYS PRIOR TO START OF STORM DRAIN CONSTRUCTION AND SHARE FINDINGS WITH ENGINEER. CONNECT NEW 6" STORM DRAIN TO EXISTING 42" STORM, UTILIZING SPECIFIED FITTINGS AS COORDINATED WITH CITY OF BEAVERTON.
- 3. CONSTRUCT 4" PERFORATED PIPE, LENGTH AS SHOWN, SLOPE NO LESS THAN 0.5% (0.0050 FT/FT).
- 4. CONSTRUCT 6"/4" STORM DRAIN, LENGTH AS SHOWN, SLOPE NO LESS THAN 1% (0.0100 FT/FT).
- 5. NEW AREA DRAIN, PER DETAIL 2 ON SHEET C1.2. RIM AS SHOWN.
- CONSTRUCT NEW MECHANICAL TREATMENT ASSEMBLY, RIM AS SHOWN.
 CONSTRUCT 6"SD BETWEEN MANHOLE AND EXISTING 42"SD CONNECTION AS
 SHOWN (PIPE LENGTH AS SHOWN). CONTECH STORMFILTER TREATMENT
 ASSEMBLY SHALL BE PER DETAIL 3, SHEET C1.2, AND AS FURTHER DETAILED IN
 STORM REPORT.
- 7. EXISTING LIFT STATION MANHOLE WITH FIBERGLASS LIDS AND RISERS TO BE REVISED TO BE LOCKING. CONTRACTOR TO COORDINATED WITH BSD AND MANHOLE MANUFACTURER FOR NEW LOCKING LID/RISER CONSTRUCTION.

PROPOSED LEGEND AND ABBREVIATIONS

PROPOSED LEGEND AND ABBREVIATIONS						
_	ASPHALT AREA DRAIN BEAVERTON SCHOOL DISTRICT CATCH BASIN CONSTRUCT EXISTING FLOW LINE FOOT/FEET LENGTH LINEAR FEET MINIMUM SLOPE TYPICAL					
	AREA DRAIN					
	PERFORATED PIPE					
— SD ——	STORM DRAIN					

EXISTING SURVEY LEGEND

	WATER VALVE	•	SIGN
\boxtimes	WATER METER	•	BOLLARD
\boxtimes	IRRIGATION VALVE	0	POLE
W	WATER VAULT	Æ	ADA PARKING
+👉+	FIRE HYDRANT	(C)	ADA FARRING
A	FIRE DEPT CONNECTION	SHAN OF THE	CONIFEROUS TREE
	AREA DRAIN (SQUARE)	2 Marine	
0	STORM DRAIN MANHOLE	<i>(</i> •)	BROADLEAF TREE
0	UTILITY POLE	Charand	
~	GUY ANCHOR	ELEC	ELECTRIC
**	LIGHT POLE	SS	SANITARY SEWER
<u>EM</u>	ELECTRIC METER	AD	AREA DRAIN
E	ELECTRIC RISER	SD	STORMWATER
TR	ELECTRIC TRANSFORMER	©	SEWER MANHOLE
E	ELECTRIC VAULT	©	CLEANOUT
	TELEPHONE RISER	•	METAL POST
U	UNKNOWN UTILITY VAULT	T	TELEPHONE VAULT
	CONCRETE TRASH CAN	R/W	RIGHT OF WAY
	WATER QUALITY CATCH BASIN	(i)	FOUND MONUMENT
	\triangle	REFER TO D	ETAIL AND BENCHMARK TABL
		DENOTES B	UILDING OVERHEAD
	375———		UILDING OVERHEAD UR INTERVAL
	375	5.0' CONTO	
	0.0	5.0' CONTO	UR INTERVAL
	0.0	5.0' CONTOL 1.0 CONTOL HATCH DEN	UR INTERVAL JR INTERVAL
	0.0	5.0' CONTOL 1.0 CONTOL HATCH DEN	UR INTERVAL UR INTERVAL OTES BUILDING
(5,55,53,53,53,53,53,53,53		5.0' CONTOL 1.0 CONTOL HATCH DEN HATCH DEN	UR INTERVAL UR INTERVAL OTES BUILDING OTES BUILDING OVERHANG
(1.00.00.00.00.00.00.00.00.00.00.00.00.00		5.0' CONTOL 1.0 CONTOL HATCH DEN HATCH DEN HATCH DEN	UR INTERVAL JR INTERVAL OTES BUILDING OTES BUILDING OVERHANG OTES ASPHALT PAVEMENT
(1.00.00.00.00.00.00.00.00.00.00.00.00.00		5.0' CONTOU 1.0 CONTOU HATCH DEN HATCH DEN HATCH DEN HATCH DEN	UR INTERVAL UR INTERVAL OTES BUILDING OTES BUILDING OVERHANG OTES ASPHALT PAVEMENT OTES CONCRETE
		5.0' CONTOL 1.0 CONTOL HATCH DEN HATCH DEN HATCH DEN HATCH DEN HATCH DEN	UR INTERVAL UR INTERVAL OTES BUILDING OTES BUILDING OVERHANG OTES ASPHALT PAVEMENT OTES CONCRETE OTES GRAVEL PAINT STRIPE
		5.0' CONTOU 1.0 CONTOU HATCH DEN HATCH DEN HATCH DEN HATCH DEN PAVEMENT CHAIN LINK	UR INTERVAL UR INTERVAL OTES BUILDING OTES BUILDING OVERHANG OTES ASPHALT PAVEMENT OTES CONCRETE OTES GRAVEL PAINT STRIPE FENCE
		5.0' CONTOU 1.0 CONTOU HATCH DEN HATCH DEN HATCH DEN HATCH DEN HATCH DEN PAVEMENT CHAIN LINK UNDERGRO	UR INTERVAL UR INTERVAL OTES BUILDING OTES BUILDING OVERHANG OTES ASPHALT PAVEMENT OTES CONCRETE OTES GRAVEL PAINT STRIPE FENCE UND STORM DRAIN LINE
		5.0' CONTOU 1.0 CONTOU HATCH DEN HATCH DEN HATCH DEN HATCH DEN HATCH DEN PAVEMENT CHAIN LINK UNDERGRO	UR INTERVAL UR INTERVAL OTES BUILDING OTES BUILDING OVERHANG OTES ASPHALT PAVEMENT OTES CONCRETE OTES GRAVEL PAINT STRIPE FENCE UND STORM DRAIN LINE



88685 Faulhaber Rd Elmira, OR 97437 541-654-1513 bugbeyla@gmail.com



Janet Turner Engineering, LLC



STON SCHOOL DISTRICT

THIGH SCHOOL

M SITE IMPROVEMENTS

W CORNELL ROAD


CONSTRUCTION DRAWINGS
PERMIT AND BIDDING SET

ISSUE			
#	DESCRIPTI	DATE	
1	BSD COM	03/10/2020	
DATE	•	2/18/20	•
PROJE	ECT NO.		
CAD D	WG FILE		
DRAW	N BY	AWS	
CHEC	KED BY	JLT	

STORM DRAIN PLAN

SCALE:


C1.1

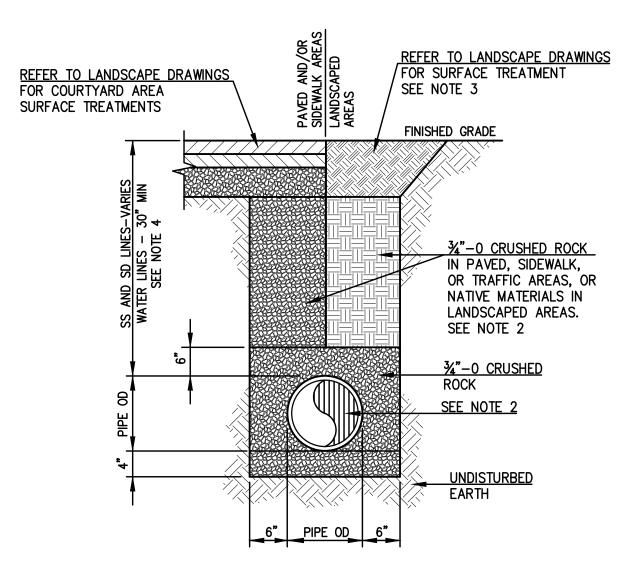

1. WATER LINES THAT PARALLEL SANITARY SEWER LINES SHALL BE LOCATED A MINIMUM OF 12" ABOVE SEWER LINES, WHERE SERVICES ARE NOT HORIZONTALLY SEPARATED BY 10'.

- 2. WITHIN 5' OF A BUILDING STRUCTURE, BUILDING CODE APPROVED PIPE MATERIAL AND 3/4"-0
- CRUSHED ROCK BACKFILL SHALL BE USED. 3. SAWCUT, REMOVE AND REPAIR EXISTING SURFACES TO MATCH EXISTING ASPHALT, CONCRETE, OR LANDSCAPING IN AREAS WHICH DO NOT RECEIVE NEW IMPROVEMENTS. PROVIDE 4" MIN DEPTH ASPHALT PAVEMENT, 4" MIN DEPTH CONCRETE PAVEMENT, OR MATCH EXISTING PAVEMENT DEPTH, WHICHEVER IS GREATER.
- 4. 36" MINIMUM FOR FIRE SERVICE PIPES UNDER AREAS TRAFFICKED BY VEHICLES. (NFPA 24, 10-4) 5. INSTALL TRACER WIRE ON ANY PIPELINE(S) CONSTRUCTED OF NON-METALLIC PIPE MATERIAL.

TYPICAL TRENCHING & BACKFILL SECTION

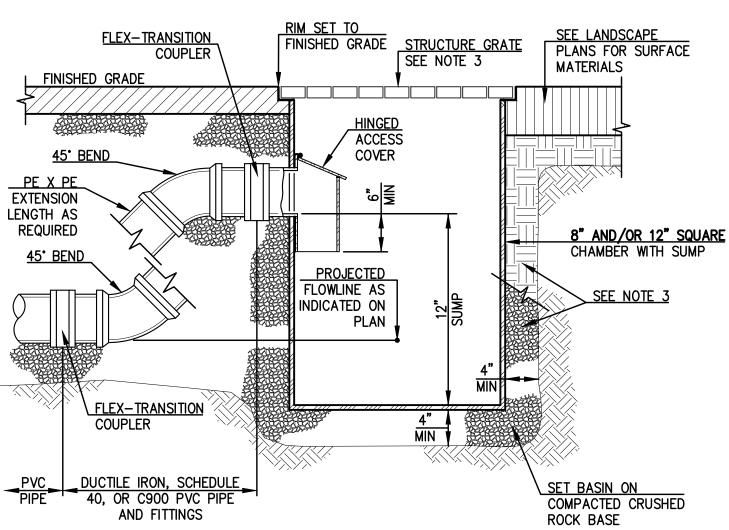

- NOTES

 1. TRACER WIRE SHALL ENTER STRUCTURE AT PIPE INLET OR OUTLET. PROVIDE ADEQUATE

 1. TRACER WIRE SHALL ENTER STRUCTURE AT PIPE INLET OR OUTLET. PROVIDE ADEQUATE

 1. TRACER WIRE SHALL ENTER STRUCTURE AT PIPE INLET OR OUTLET. PROVIDE ADEQUATE AND PIPE INLET OR OUTLET. FREE WIRE TO EXTEND 24" ABOVE TOP OF GRATE TO FACILITATE TESTING. COIL WIRE AND SECURE WITH NON-CORROSIVE FASTENER 2" UNDER FRAME.
- 2. LOCATION SPECIFIED ON PLAN INDICATES CENTER OF GRATED SECTION OF BASIN. 3. BACKFILL AROUND BASIN USING CRUSHED ROCK IN PAVEMENT OR SIDEWALK AREAS OR
- NATIVE MATERIAL IN LANDSCAPE AREAS.
- 4. ALL STRUCTURES SHALL BE PROVIDED WITH ADA-APPROVED GRATES.

STANDARD AREA DRAIN (AD)

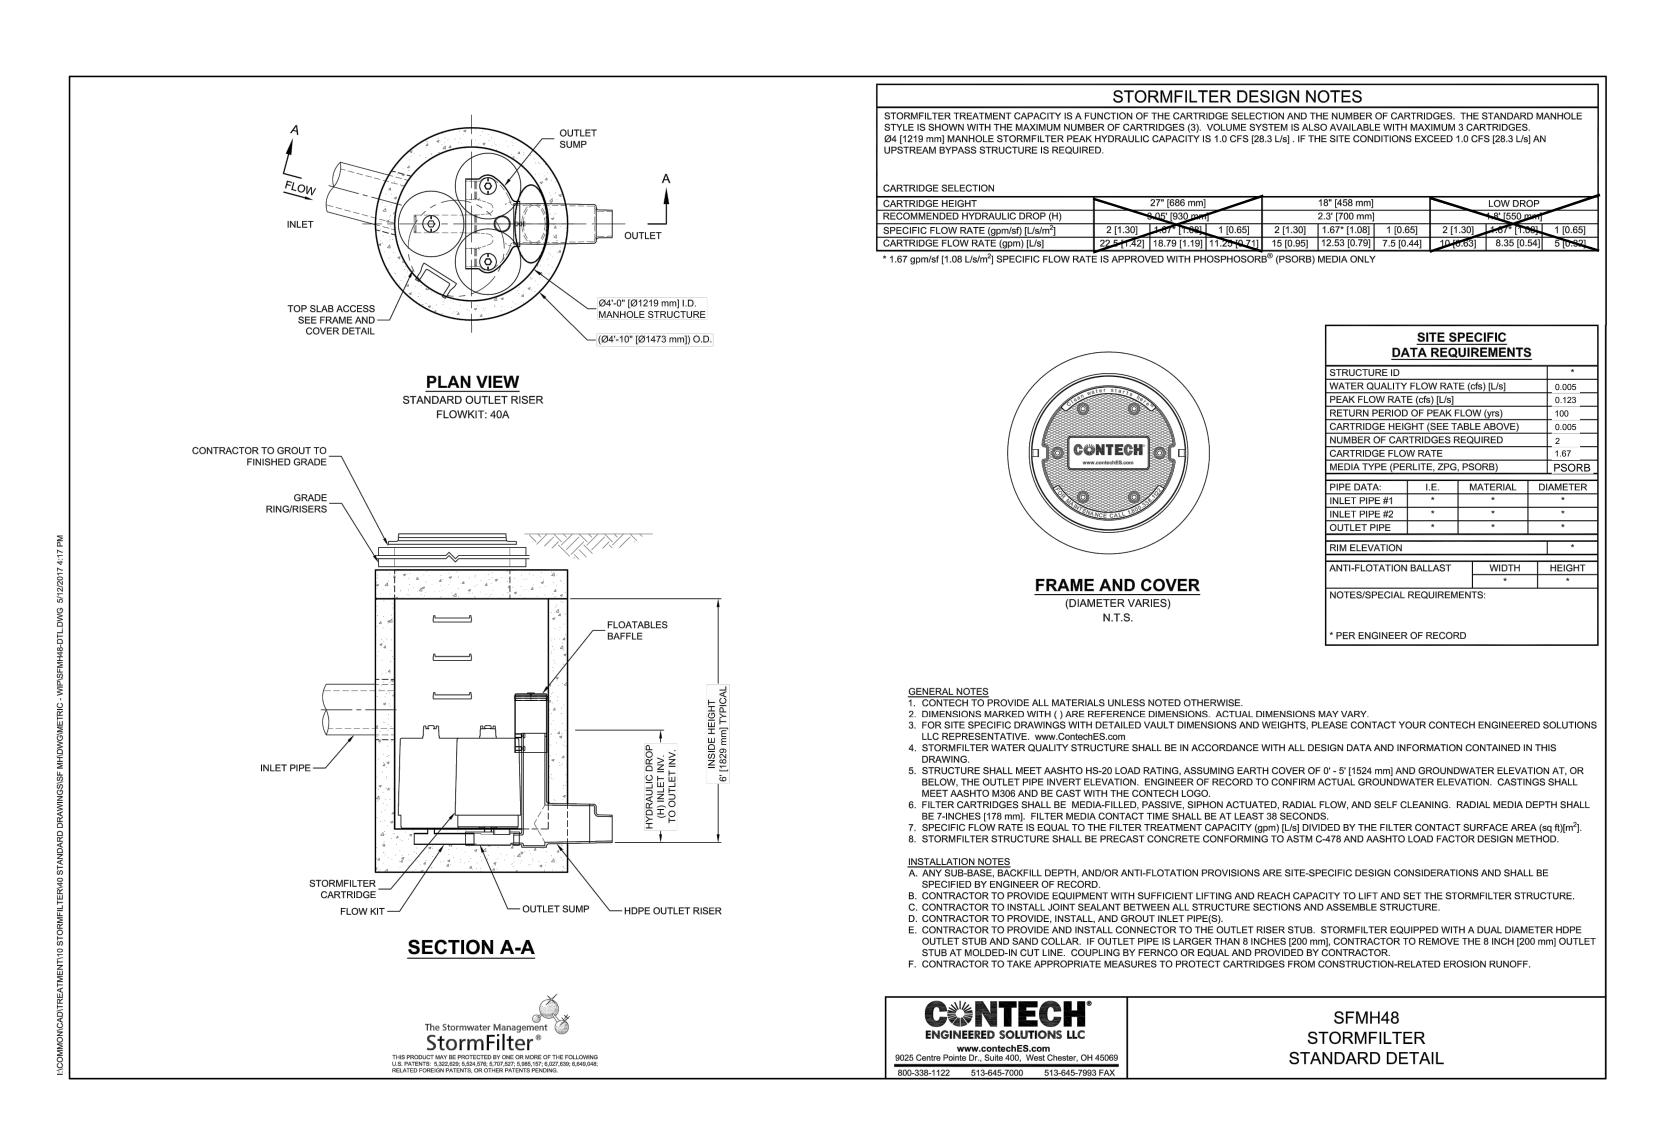

STORMWATER STORMFILTER DETAIL

LANDSCAPE ARCHITECTURE 88685 Faulhaber Rd Elmira, OR 97437 541-654-1513 bugbeyla@gmail.com

BUGBEY & ASSOCIATES





CONSTRUCTION DRAWINGS

Р	PERMIT AND BIDDING SET								
ISS	ISSUE								
	#	DESCRIPTI	DATE						
	1	BSD COM	MENTS	03/10/2020					
DA	ΛΤΕ		2/18/20						
PF	ROJE	ECT NO.							
CA	AD D	WG FILE							
DF	RAW	N BY	AWS						

CIVIL DETAILS

JLT

SCALE:

CHECKED BY

1	2	3	4	5	l 6	7	l	8	9	10 I	11 12 13	14 15	
											SYMBOL LEGEND	GENERAL NOTES	BUGBEY
۸											3 TWIDOL LLGLIND	A. CONTRACTOR'S USE OF THESE DRAWINGS FOR CONSTRUCTION	& ASSOCIATES
^											COMMON	COMMUNICATES THAT THEY FULLY UNDERSTAND THE INTENT	LANDSCAPE ARCHITECTURE
											(26 05 00)	CONVEYED WITHIN (IMPLICITLY OR	88685 Faulhaber Rd
_												EXPLICITLY IMPLIED), THAT THEY HAVE A CONSTRUCTION PLAN TO	Elmira, OR 97437 541-654-1513
											1 DRAWING REFERENCE	MEET THAT INTENT, AND TAKE FULL RESPONSIBILITY TO	bugbeyla@gmail.com
											E4.01 (SHEET E4.01, DRAWING 1)	PROVIDE THE OWNER WITH A COMPLETE AND FUNCTIONAL	
В											(1) HEX NOTE	SYSTEM THAT MEETS THE INTENT.	
												B. CONTRACTOR IS RESPONSIBLE	
_											(A) CIRCLE NOTE	FOR KNOWING AND ADHEREING TO THE SPECIFICATIONS, _	
											EF EQUIPMENT REFERENCE (EF-1 - EXHAUST FAN 1)	DRAWINGS, MANUFACTURER'S RECOMMENDATIONS, CODE	EVANS ENGINEERING AND CONSULTING, LLC
											(######) CIRCUIT / FEEDER REFERENCE	REQUIREMENTS, AND/OR REFERENCES FOR A COMPLETE	17675 FARMINGTON ROAD #136 ALOHA, OREGON 97007
С												AND FUNCTIONAL SYSTEM.	971-245-4012
											REVISION SYMBOL AND CHANGE CLOUD	C. DRAWINGS ARE SCHEMATIC IN	OED PROFES
_												NATURE AND INTENDED ONLY TO COMMUNICATE INTENT OF WORK.	SERCI NEESOL
												CONTRACTOR IS RESPONSIBLE FOR PROVIDING ALL MATERIALS,	83084PE
											RACEWAY	LABOR, AND/OR SERVICES REQUIRED FOR ENSURING THE	OREGON OS S
D											(26 05 33)	WORK IS COMPLETE AND MEETS THE INTENT OF WORK.	PLES T. EL
												CONTRACTOR IS RESPONSIBLE FOR ACTUAL EQUIPMENT,	EXPIRES: 12/31/2021 SIGNED: 03/02/2020 P#: 2019031
											UNDERGROUND RACEWAY	DIMENSIONS, AND/OR CODE	F#. 2019031
_											J J JUNCTION BOX	REQUIRED CLEARANCES _	
											→ CONTINUATION	D. CONTRACTOR IS RESPONSIBLE FOR COORDINATING WITH ALL	
E											φ φ conduit down, conduit up	DISCIPLINES TO ENSURE NO CONFLICTS WITH THE WORK.	
												E. CONTRACTOR IS RESPONSIBLE	S W C
											WIRING DEVICES	FOR PROVIDING ELECTRICAL INSTALLATION AND/OR	
_											(26 27 26)	CONNECTION SERVICES -	1 2 8 8 8
											,	NECESSARY TO ENSURE EQUIPMENT REQUIRING	
F											NORMAL POWER SINGLE, DUPLEX, AND QUAD RECEPTACLES	ELECTRICAL POWER, AS PROVIDED AND/OR FURNISHED BY	SC МР МР 972
'												OWNER OR OTHER TRADES, IS IN FULL AND COMPLETE WORKING	$ C \mathbf{r} = Z $
											ABBREVIATIONS	ORDER. COORDINATE WITH OWNER AND/OR TRADE TO	2
_											AFF ABOVE FINISHED FLOOR	CLARIFY EXACT DIVISION OF -	
											CO CARBON MONOXIDE	RESPONSIBILITIES.	L M M M M M M M M M M M M M M M M M M M
_											(D) DEMOLISH		
G											(E) EXISTING TO REMAIN		A Z Z Z
											EMT ELECTRICAL METALLIC TUBING		SUN STA 1384 POR
_											EV ELECTRICAL VEHICLE	_	
											FC FOOT CANDLES		CONSTRUCTION DRAWINGS PERMIT AND BIDDING SET
											ID IDENTIFICATION		ISSUE
Н											J-BOX JUNCTION BOX		# DESCRIPTION DATE
											K.E.C. KITCHEN EQUIPMENT CONTRACTOR		
_											KO KNOCK OUT (N) NEW	_	
											(N) NEW		
											O.C. ON CENTER (R) RELOCATE AND/OR REUSE		
I											RMC RIGID METALLIC CONDUIT		
											SW 'a' SWITCH LEG 'a', LOWER CASE IS SWITCH.	SHEET LIST	DATE 02/18/2020 PROJECT NO. 7839
_												E1.0 LEGEND AND GENERAL NOTES E1.1 DESIGN SHEET	CAD DWG FILE
												SPECIFICATIONS	DRAWN BY MH CHECKED BY EEC
												E2.1 SITE PLAN	<u> </u>
J													LEGEND
													AND
_													GENERAL
_												_	NOTES
													SCALE:
													OUALL.

	ISSUE			
	#	DESCRIPTI	ON	DATE
	DATE		02/18/2020	
	PROJE	ECT NO.	7839	
	CAD D	WG FILE		
1	DRAW	N BY	МН	

E1.0

DESIGN SHEET SPECIFICATIONS

PART 1 - GENERAL

1.1 REQUIREMENTS

- SPECIFICATIONS, DRAWINGS AND/OR OTHER REFERENCED MATERIAL FORM THE BASIS OF THE PROJECT SCOPE AND ARE DEFINED AS THE CONTRACT DOCUMENTS. THE CONTRACT DOCUMENTS PROVIDE DIRECTION AND CONVEY INTENT, THEY ARE NOT ALL INCLUSIVE. IT IS THE RESPONSIBILITY OF THE CONTRACTOR TO VERIFY CONSTRUCTABILITY OF DESIGN AND ENSURE A COMPLETE. WORKING, FINISHED PROJECT THAT IS ACCEPTABLE TO THE OWNER'S REPRESENTATIVE.
- CONTRACTOR IS RESPONSIBLE FOR REVIEW OF ALL DISCIPLINE CONTRACT DOCUMENTS AND CROSS DISCIPLINE COORDINATION AS IT PERTAINS TO THE CONTRACTOR'S DISCIPLINE. CONTRACTOR IS RESPONSIBLE FOR IDENTIFYING ANY DISCREPENCIES OR CONSTRUCTABILITY ISSUES AND REPORTING THOSE TO THE OWNER'S REPRESENTATIVE.
- CONTRACTOR IS RESPONSIBLE FOR ENSURING PROJECT ADHERES TO LOCAL CODES AND FOR REPORTING ANY CODE VIOLATIONS OR ISSUES TO THE OWNER'S REPRESENTATIVE.
- CONTRACTOR IS RESPONSIBLE FOR PROVIDING ALL LABOR, TOOLS, MATERIALS, TEMPORARY SERVICES. AND/OR INSTRUMENTS REQUIRED EXPLICITLY OR IMPLICITLY BY THE CONTRACT DOCUMENTS.

1.2 SUBMITTALS

- CONTRACTOR IS REQUIRED AT MINIMUM TO PROVIDE CLEAR AND LEGIBLE SUBMITTALS FOR THE FOLLOWING. SUBMITTALS ARE TO BE IN PDF FORMAT WITH APPROPRIATE FILE NAME. EACH PAGE OF SUBMITTAL INFORMATION IS TO INCLUDE PAGE NUMBER AND NUMBER OF PAGES IN SUBMITTAL PROJECT NAME AND NUMBER AS INDICATED ON DRAWINGS. AND SPECIFICATION DIVISION OR DRAWING SUBMITTAL IS IN REFERENCE TO.
 - PRODUCT DATA: CLEARLY IDENTIFY SPECIFIC PRODUCTS USED, DIMENSIONS, WEIGHTS, VOLTAGE, AMPERAGE, HORSEPOWER, MANUFACTURER PRODUCT LITERATURE, INSTALLATION INSTRUCTIONS, AND WARRANTY.
 - 2. SHOP DRAWINGS, COORDINATION DRAWINGS, AS-BUILT DRAWINGS, AND SEISMIC QUALIFICATIONS.
 - STUDIES, TEST REPORTS, AND/OR CALCULATIONS REQUIRED BY CODE, CONTRACT DOCUMENTS AND/OR AT REQUEST OF OWNER'S REPRESENTATIVE
- CONTRACTOR IS REQUIRED TO PROVIDE CLEAR AND LEGIBLE O&M MANUAL IN PDF FORMAT THAT INCLUDES ALL SUBMITTAL INFORMATION REQUIRED ABOVE. CLEANLY ORGANIZE O&M MANUAL AND PROVIDE TABLE OF CONTENTS.

1.3 QUALITY ASSURANCE, REFERENCES, AND REGULATORY REQUIREMENTS

- A. EQUIPMENT, COMPONENTS AND/OR SYSTEMS SHALL BE LISTED AND LABELED BY A NATIONALLY RECOGNIZED TESTING LABORATORY ACCEPTABLE TO THE AHJ.
- ENSURE INSTALLER IS EXPERIENCED AND SPECIALIZED TO PERFORM THE WORK AS INDICATED IN THE CONTRACT DOCUMENTS

1.4 DELIVERY, STORAGE, AND HANDLING

- A. STORE IN A CLEAN, DRY SPACE, MAINTAIN FACTORY WRAPPING AND/OR PROVIDE ADDITIONAL PROTECTION TO MAINTAIN IN LIKE NEW CONDITION.
- B. HANDLE IN ACCORDANCE WITH MANUFACTURER'S WRITTEN INSTRUCTIONS AND PROPERLY TRANSPORT TO MAINTAIN IN LIKE NEW CONDITION.

1.5 WARRANTY

- A. PROVIDE A WRITTEN GUARANTEE (WARRANTY) TO THE OWNER CERTIFYING THAT ALL MATERIALS, EQUIPMENT, INSTALLATION, AND/OR SYSTEMS FURNISHED UNDER THIS CONTRACT WILL REMAIN IN SATISFACTORY OPERATING CONDITION AND BE FREE OF DEFECTS IN MATERIALS OR WORKMANSHIP FOR ONE (1) YEAR FROM THE DATE OF FINAL ACCEPTANCE BY THE OWNER'S REPRESENTATIVE.
- PROVIDE MANUFACTURER'S WARRANTY.

PART 2 - PRODUCTS

2.1 MANUFACTURERS

PROVIDE PRODUCTS FROM REPUTABLE MANUFACTURERS WITH QUALIFIED AND PROVEN EXPERIENCE IN MANUFACTURING THE MATERIAL/EQUIPMENT SPECIFIED AND/OR SHOWN ON DRAWINGS. ENSURE MANUFACTURER'S HAVE AT LEAST 10 YEARS OF EXPERIENCE AND PROVEN TRACK RECORD MANUFACTURING THE MATERIALS. UNLESS OTHERWISE NOTED.

2.2 MATERIALS

- A. PROVIDE ALL WIRE, CONDUIT, CONNECTORS, ENCLOSURES, CONTROLS, COMPONENTS AND/OR OTHER MATERIALS AS IT RELATES TO THE SCOPE OF WORK WHETHER INDICATED EXPLICITLY OR IMPLICITLY IN THE CONTRACT DOCUMENTS. COORDINATE WITH OTHER DISCIPLINES TO ENSURE ALL REQUIREMENTS ARE MET.
- PROVIDE NEW MATERIALS OF THE BEST QUALITY LISTED BY A RECOGNIZED TESTING LABORATORY OR AS APPROVED IN WRITING BY THE AHJ.
- C. FOR USE OF MATERIAL ALTERNATE TO THAT IN THE CONTRACT DOCUMENTS, PROVIDE A WRITTEN REQUEST AND MATERIAL DOCUMENTATION TO THE ENGINEER CLEARLY INDICATING HOW THE ALTERNATE MATERIAL MEETS AND/OR EXCEEDS THE CONTRACT **MATERIAL**
- D. CONDUCTORS AND CABLES: UNLESS OTHERWISE NOTED PROVIDE #12 FOR GENERAL BRANCH CIRCUITS, #10 FOR EQUIPMENT, OR AS SIZED FOR VOLTAGE DROP. UNLESS OTHERWISE NOTED: DESIGN IS BASED ON USE OF THHN/THWN FOR BUILDING INTERIOR WIRING AND XHHW FOR EXTERIOR/UNDERGROUND WIRING. TYPE NM IS PERMITTED FOR INTERIOR US IN RESIDENTIAL TYPE CONSTRUCTION
- GROUNDING AND BONDING: UNLESS OTHERWISE NOTED CONDUCTOR IS COPPER SIZED PER NEC AND CONNECTED TO GROUNDING ELECTRODE SYSTEM.
- RACEWAY AND BOXES: PROVIDE BOXES AND RACEWAY IN ACCORDANCE WITH CONSTRUCTION TYPE.
- G. IDENTIFICATION: UNLESS OTHERWISE NOTED USE PREPRINTED PERMANENT MATERIAL WITH ADHESIVE BACKING FOR PREPRINTED SELF ADHESIVE 3-PLY LAMINATED PLASTIC FOR PANELS AND DISTRIBUTION EQUIPMENT, DYMO TYPE FIELD PRINTED LABELING FOR RECEPTACLES AND OTHER EQUIPMENT, BLACK INDELIBLE MARKER FOR CONDUIT AND JUNCTION BOXES, AND YELLOW PLASTIC BURIAL TAPE PRINTED WITH "ELECTRICAL" FOR UNDERGROUND INSTALLATIONS.
- OVERCURRENT DEVICES: UNLESS OTHERWISE NOTED BREAKERS ARE MOLDED CASE THERMAL MAGNETIC TYPE, AND FUSES ARE DUAL ELEMENT TIME DELAY.
- WIRING DEVICES: UNLESS OTHERWISE NOTED WIRING DEVICES ARE: DUPLEX RECEPTACLES ARE 20 AMP, 3-WIRE, 2-POLE GROUNDING, NEMA 5-20R, AND GFI IN WET AREAS - MOUNTING HEIGHT IS 18" AFF. SWITCHES ARE LINE VOLTAGE, 20 AMP, QUIET TYPE - MOUNTING HEIGHT IS 42" AFF. UNFINISHED AREAS PLATES ARE METAL, FINISHED AREAS PLATES ARE MATCHING PLASTIC, AND EXTERIOR PLATES ARE WEATHERPROOF.
- DISCONNECTS: UNLESS OTHERWISE NOTED DISCONNECTS ARE LOCKABLE AND NON-FUSED WITH A NEMA 1 ENCLOSURE FOR INTERIOR AND NEMA 3R FOR EXTERIOR.
- LIGHTING: UNLESS OTHERWISE NOTED OCCUPANCY CONTROLS ARE MICROPROCESSER BASED, DUAL TECHNOLOGY, WITH AUTO-ADAPTING TECHNOLOGY. PROVIDE MEANS OF DISCONNECT FOR EACH LIGHTING FIXTURE. PROVIDE TRIMS, MOUNTING HARDWARE, AND/OR ACCESSORIES AS REQUIRED FOR CEILING TYPE.
- PROVIDE ARC-FAULT INTERRUPTERS AS REQUIRED PER CODE

PART 3 - EXECUTION

3.1 PREPARATION

- COORDINATE ACTIVITIES WITH OTHER TRADES TO ENSURE COMPLETE AND COHESIVE INSTALLATION.
- INSTALL EQUIPMENT/DEVICES IN A NEAT APPROPRIATE MANNER THAT IS LEVEL AND PLUMB UNLESS OTHERWISE NOTED.
- PROVIDE FIRE-STOPPING FOR ALL PENETRATIONS THROUGH RATED PARTITIONS.
- INCLUDE CUTTING, PATCHING AND RESTORATION OF FINISHES AS REQUIRED TO MEET THE SATISFACTION OF THE OWNER'S REPRESENTATIVE.
- CONTRACTOR IS RESPONSIBLE FOR INSTALLATION, SUPPORT, AND SEISMIC RESTRAINT OF EQUIPMENT AND SYSTEMS COVERED UNDER THE CONTRACT DOCUMENTS. PROVIDE STRUCTURAL CALCULATIONS FROM A STRUCTURAL ENGINEER REGISTERED IN THE STATE OF CONSTRUCTION CLEARLY INDICATING MEANS AND METHOD OF ANCHORING/SUPPORT.

3.2 INSTALLATION

- A. INSTALL EQUIPMENT, MATERIALS, AND SYSTEMS IN A NEAT, FINISHED AND SAFE MANNER. ENSURE INSTALLATION DONE UNDER COMPETENT SUPERVISION IN ACCORDANCE WITH THE LATEST PUBLISHED NECA STANDARD.
- B. PROVIDE COMPLETE ELECTRICAL CONNECTIONS FOR ALL ITEMS IMPLICITLY AND/OR EXPLICITLY IDENTIFIED IN THE CONTRACT DOCUMENTS.
- PROVIDE ALL CODE REQUIRED DISCONNECTS AND CONTROLS, IMPLICITLY OR EXPLICITLY IDENTIFIED IN THE CONTRACT DOCUMENTS
- CONDUCTORS: UTILIZE STANDARD PHASE COLOR CODES, REMOVE EXCESS PULLING COMPOUND, AND LABEL WIRES WITH PANEL-CIRCUIT.
- GROUNDING/BONDING: BOND ELECTRICAL SYSTEM. RACEWAYS. EQUIPMENT. COLD WATER SERVICE, STRUCTURAL STEEL, GAS PIPING, TRANSFORMERS, BUILDING GROUND GRID, AND ANY OTHER MATERIAL OR EQUIPMENT THAT HAS THE POTENTIAL TO BECOME ELECTRIFIED.
- F. HANGERS AND SUPPORTS: COMPLY WITH NECA 1 AND NECA 101.
- RACEWAY AND BOXES: UNLESS OTHERWISE NOTED, CONCEAL CONDUITS AND FLUSH MOUNT BOXES IN FINISHED SPACES AND SURFACE MOUNT IN UNFINISHED. PROVIDE FLEXIBLE CONNECTION TO EQUIPMENT.
- IDENTIFICATION: LABEL WITH PANEL-CIRCUIT ALL HVAC, PUMPS AND OTHER EQUIPMENT CONNECTED TO THE ELECTRICAL SYSTEM. LABEL WITH EQUIPMENT NAME ALL PANELS, SWITCHGEAR, SWITCHES, TRANSFORMERS, AND OTHER ELECTRICAL DISTRIBUTION EQUIPMENT. PROVIDE MARKER TAPE 12" ABOVE CONDUIT/WIRE FOR ALL UNDERGROUND INSTALLATIONS INCLUDING ABANDONED AND TEMPORARY.
- OVERCURRENT DEVICES: INSTALL PER MANUFACTURER'S INSTRUCTIONS. PROVIDE 10% SPARE MINIMUM.
- WIRING DEVICES: UNLESS OTHERWISE NOTED MOUNT SWITCHES AT 42" OC AFF, AND POWER/DATA RECEPTACLES AT 18" OC AFF.
- K. DISCONNECTS: UNLESS OTHERWISE NOTED MOUNT SWITCHES AT 5'-0" TO OPERATING HANDLE.
- LIGHTING: INSTALL LIGHT FIXTURES IN ACCORDANCE WITH MOUNTING SURFACE. ENSURE FIXTURES ARE CLEAN AT FINAL COMPLETION. INSTALL REQUIRED SEISMIC BRACING, CLEAN, RELAMP AND REBALLAST EXISTING FIXTURES.

3.3 TESTS

- CONDUCTORS: MEGER TEST CONDUCTORS WITH OVER 50A RATED CAPACITY.
- OVERCURRENT DEVICES: PROVIDE FAULT CURRENT AND COORDINATION STUDIES.

& ASSOCIATES LANDSCAPE ARCHITECTURE

Elmira, OR 97437 bugbeyla@gmail.com



17675 FARMINGTON ROAD #136 ALOHA, OREGON 97007 971-245-4012



CONSTRUCTION DRAWINGS PERMIT AND BIDDING SET

ISSUE


SO X T

#	DESCRIPTION		DATE
DATE		02/18/2020	
PROJECT NO.		7839	
CAD DWG FILE			
DRAWN BY		MH	

DESIGN SHEET **SPECIFICATIONS**


EEC

CHECKED BY

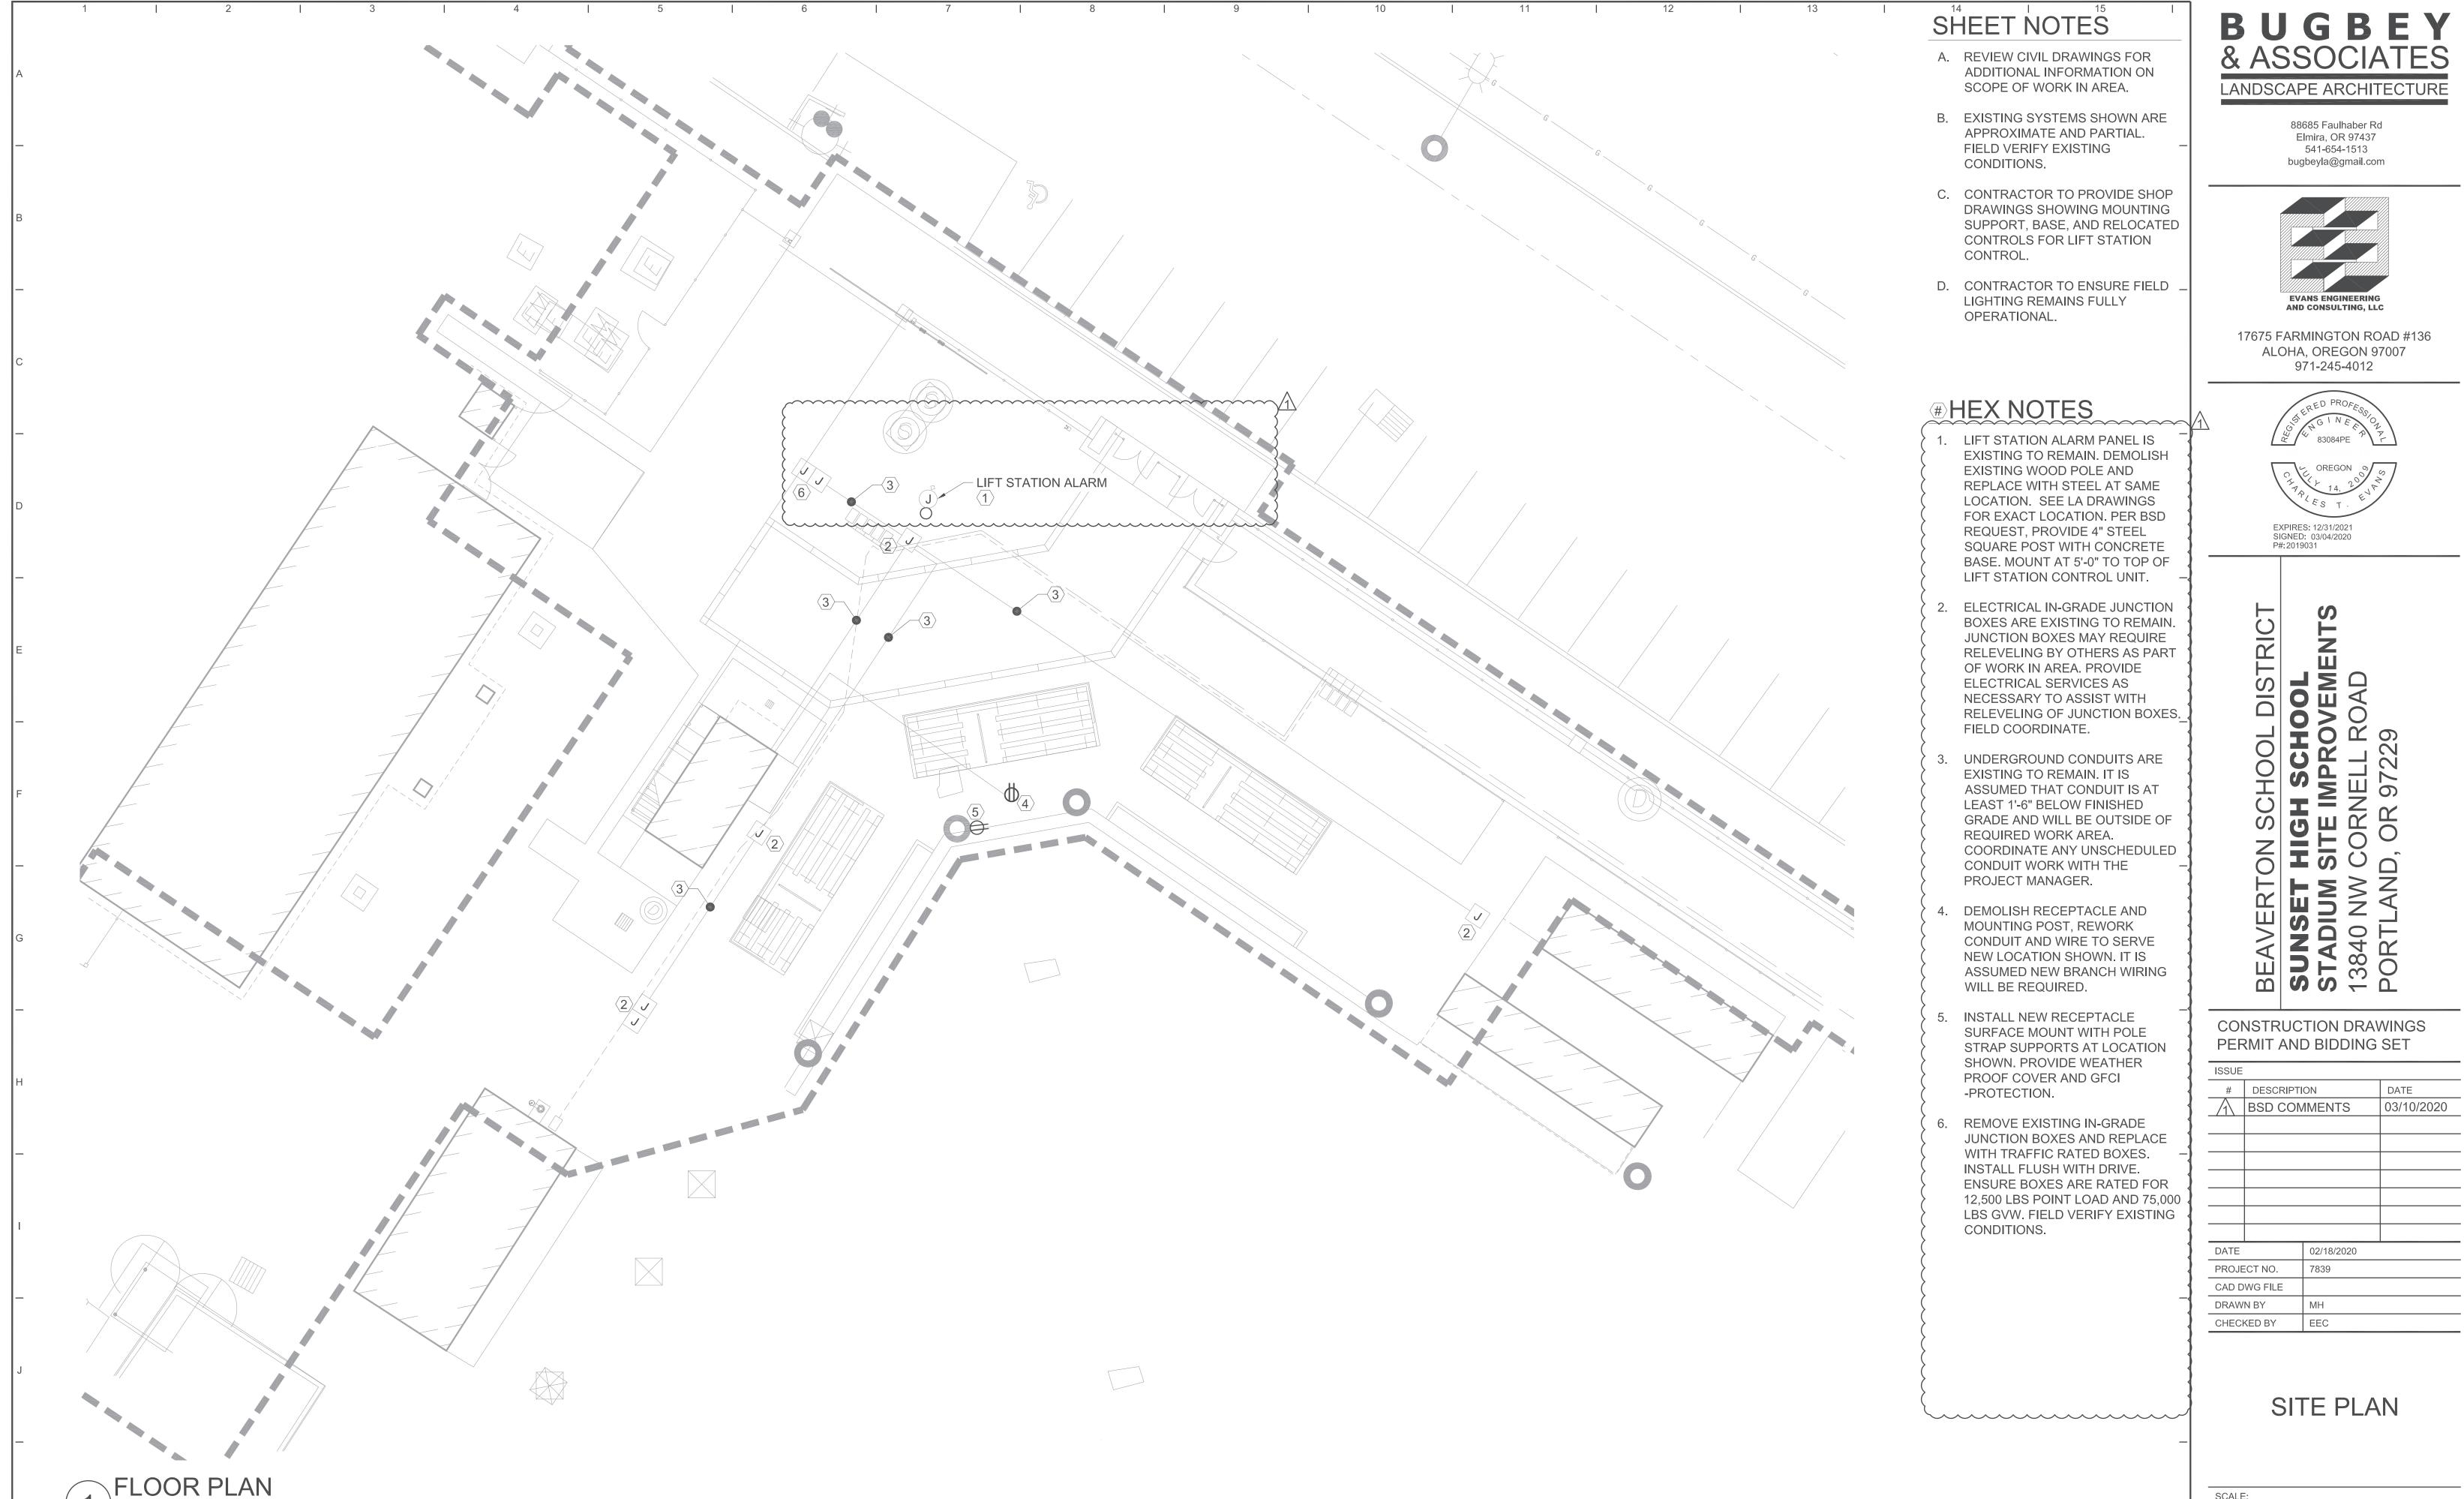

SC


E2.1

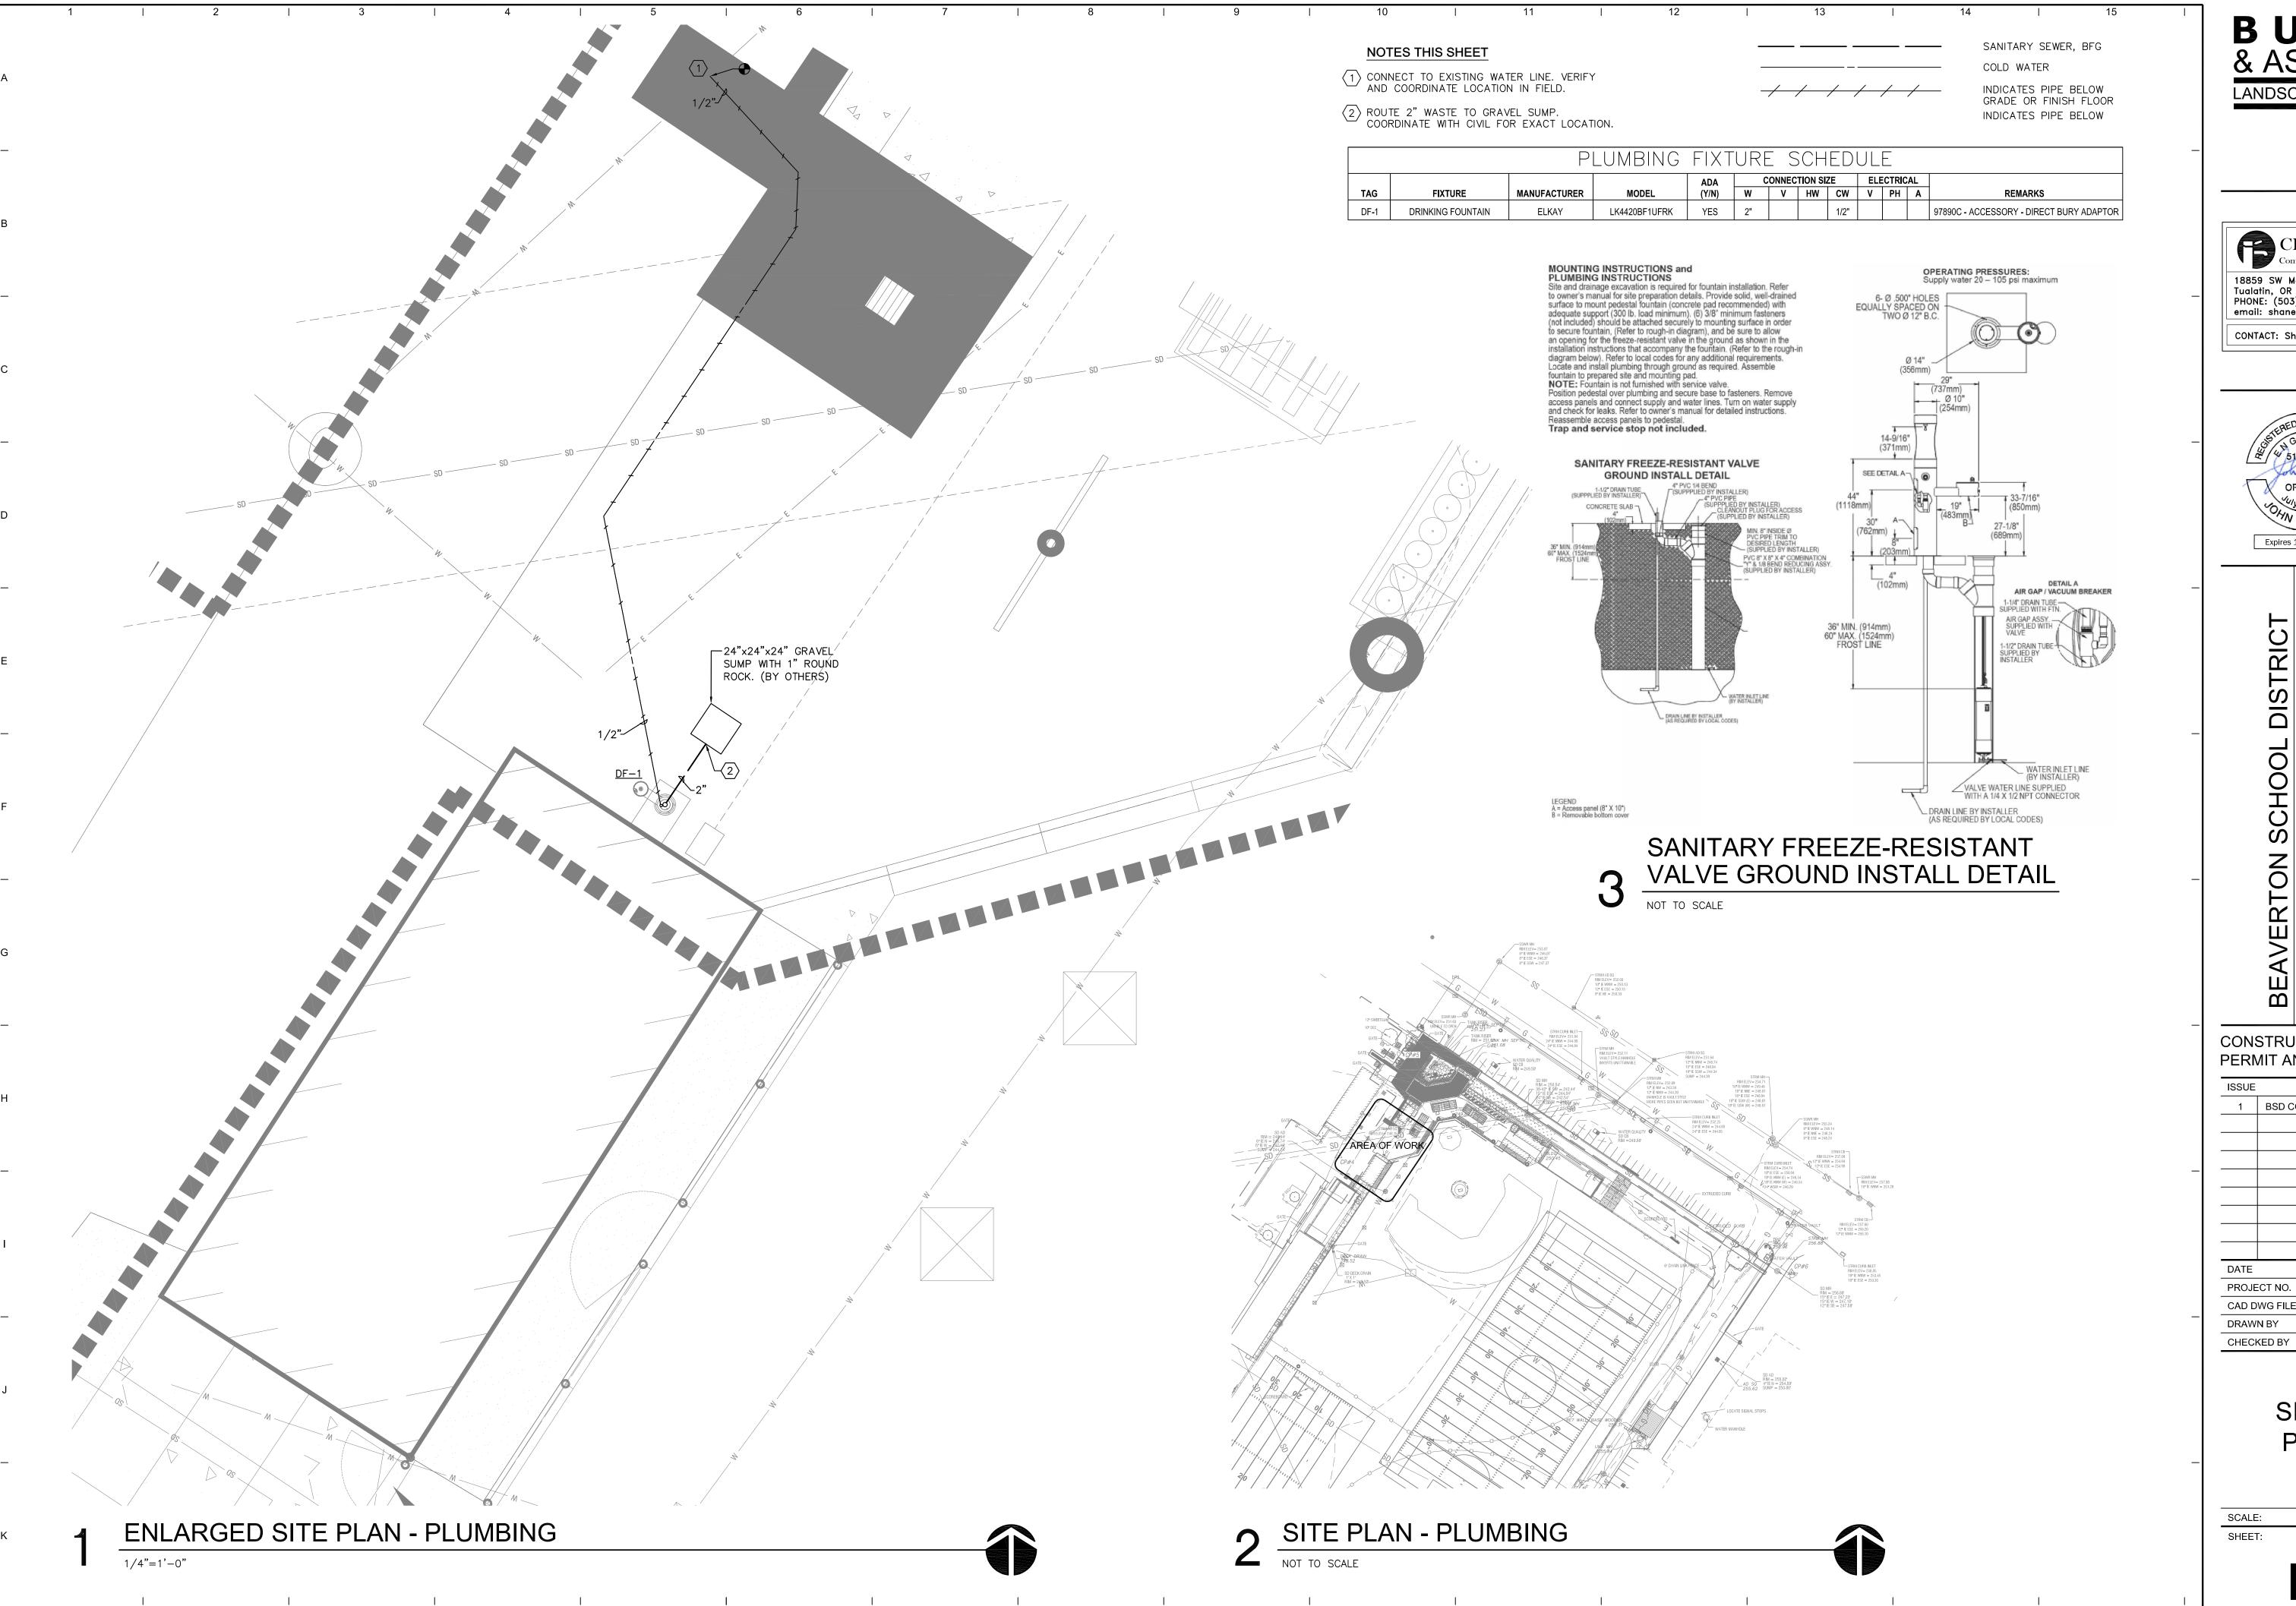



88685 Faulhaber Rd Elmira, OR 97437 541-654-1513 bugbeyla@gmail.com

CPCD, LLC Commercial Plumbing Consulting 8	k Design LLC
18859 SW Martinazzi Ave. Tualatin, OR 97062 PHONE: (503) 843—8233; email: shanef@cpcdllc.com	JOB NO. 19-032
CONTACT: Shane Fitzpatrick, CPD	

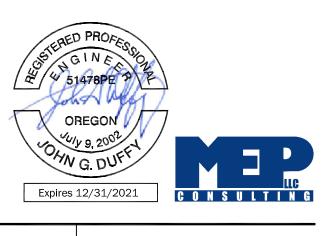


CONSTRUCTION DRAWINGS PERMIT AND BIDDING SET

ISSUE			
1	BSD COMM	IENTS	03/10/2020
DATE		02/18/2020	
PROJECT NO.		7839	
CAD DWG FILE			
DRAWN BY			


SITE PLAN -**PLUMBING**

P1.2

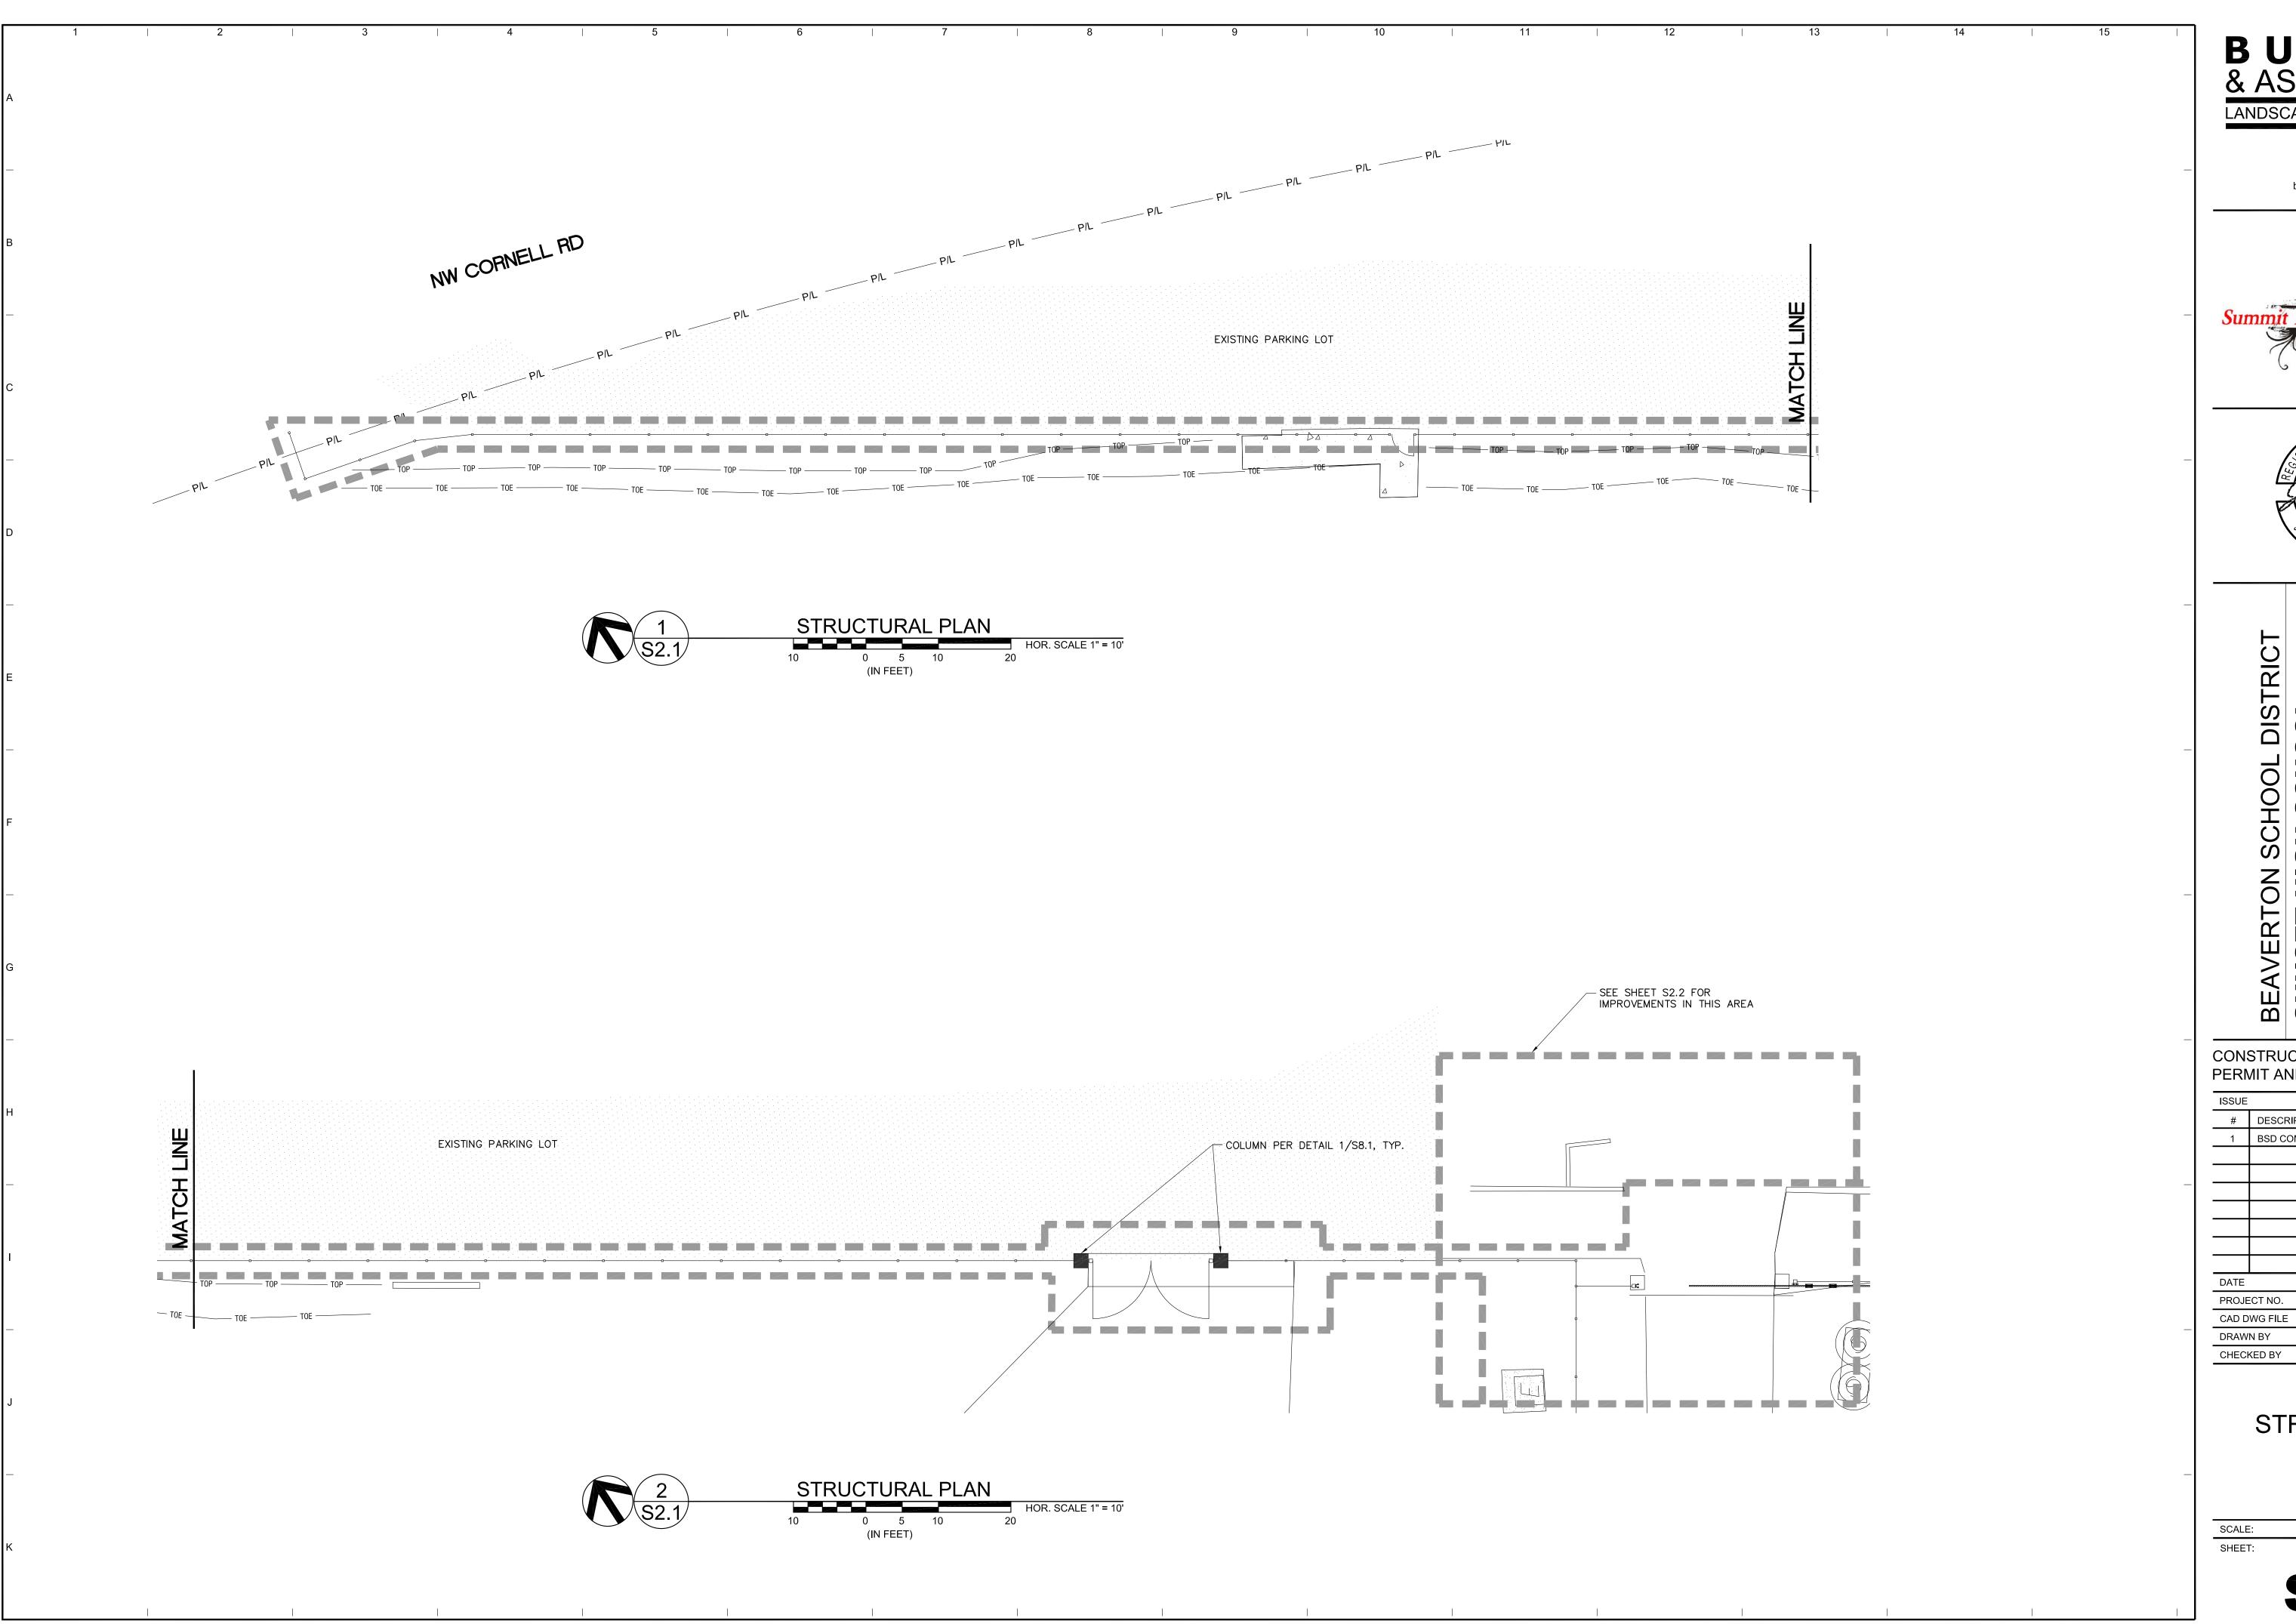

BUGBEY & ASSOCIATES LANDSCAPE ARCHITECTURE

> 88685 Faulhaber Rd Elmira, OR 97437 541-654-1513 bugbeyla@gmail.com

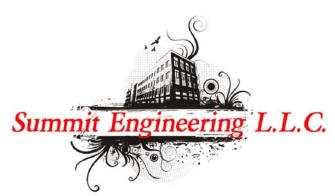



VERTON SCHOOL DISTRIC

ISET HIGH SCHOOL

DIUM SITE IMPROVEMENT

RE BOX BUILDING STAIRS


O NW CORNELL ROAD

CONSTRUCTION DRAWINGS PERMIT AND BIDDING SET


I LIXIV		יווטטווט	OLI
ISSUE			
#	DESCRIPTI	ON	DATE
1	BSD COMM	IENTS	03/10/2020
DATE		03/10/2020	
PROJECT NO.		7839	
CAD DWG FILE			
DRAWN BY		JMH	

STRUCTURAL PLAN

S2.1

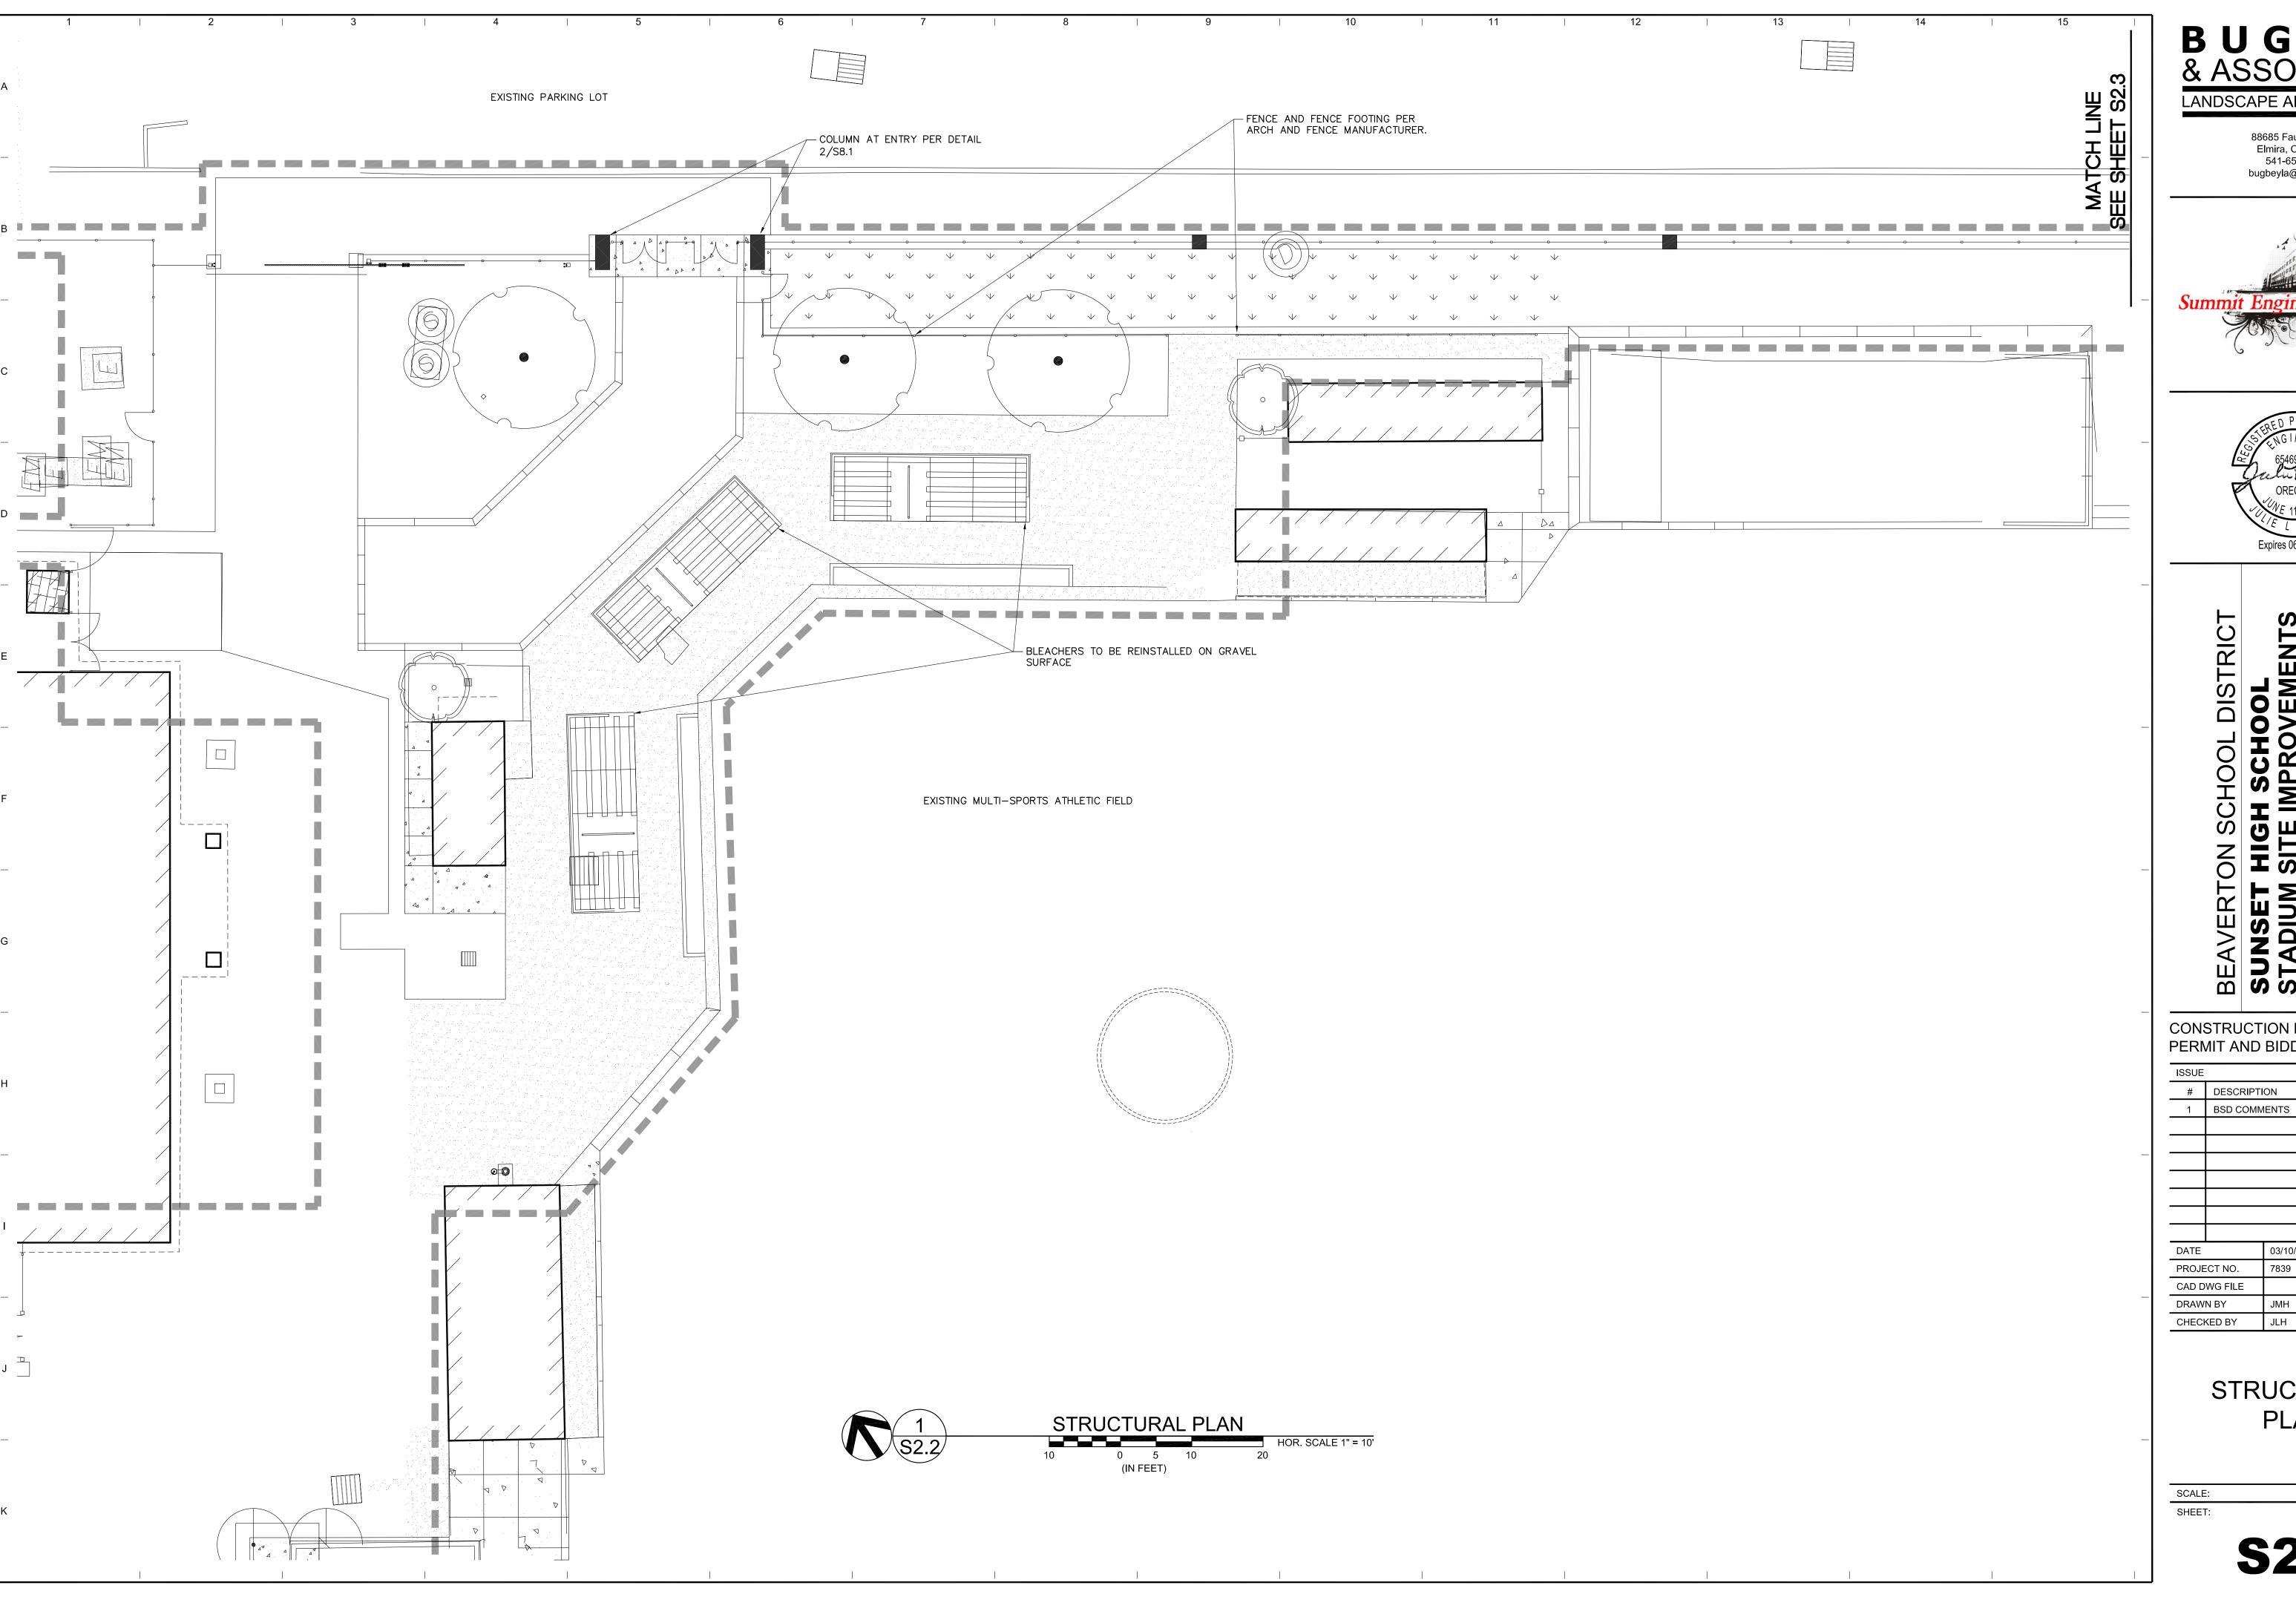

BUGBEY & ASSOCIATES LANDSCAPE ARCHITECTURE 88685 Faulhaber Rd Elmira, OR 97437 541-654-1513 bugbeyla@gmail.com

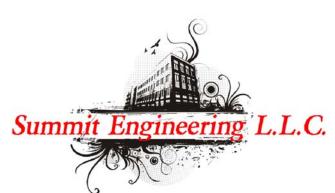




CONSTRUCTION DRAWINGS
PERMIT AND BIDDING SET

PERMIT AND BIDDING SET					
ISSUE					
#	DESCRIPTI	ON	DATE		
1	BSD COMM	IENTS	03/10/2020		
DATE		03/10/2020			
PROJE	CT NO.	7839			
CAD D	WG FILE				
DRAWN BY		JMH			


STRUCTURAL PLAN

S2.2

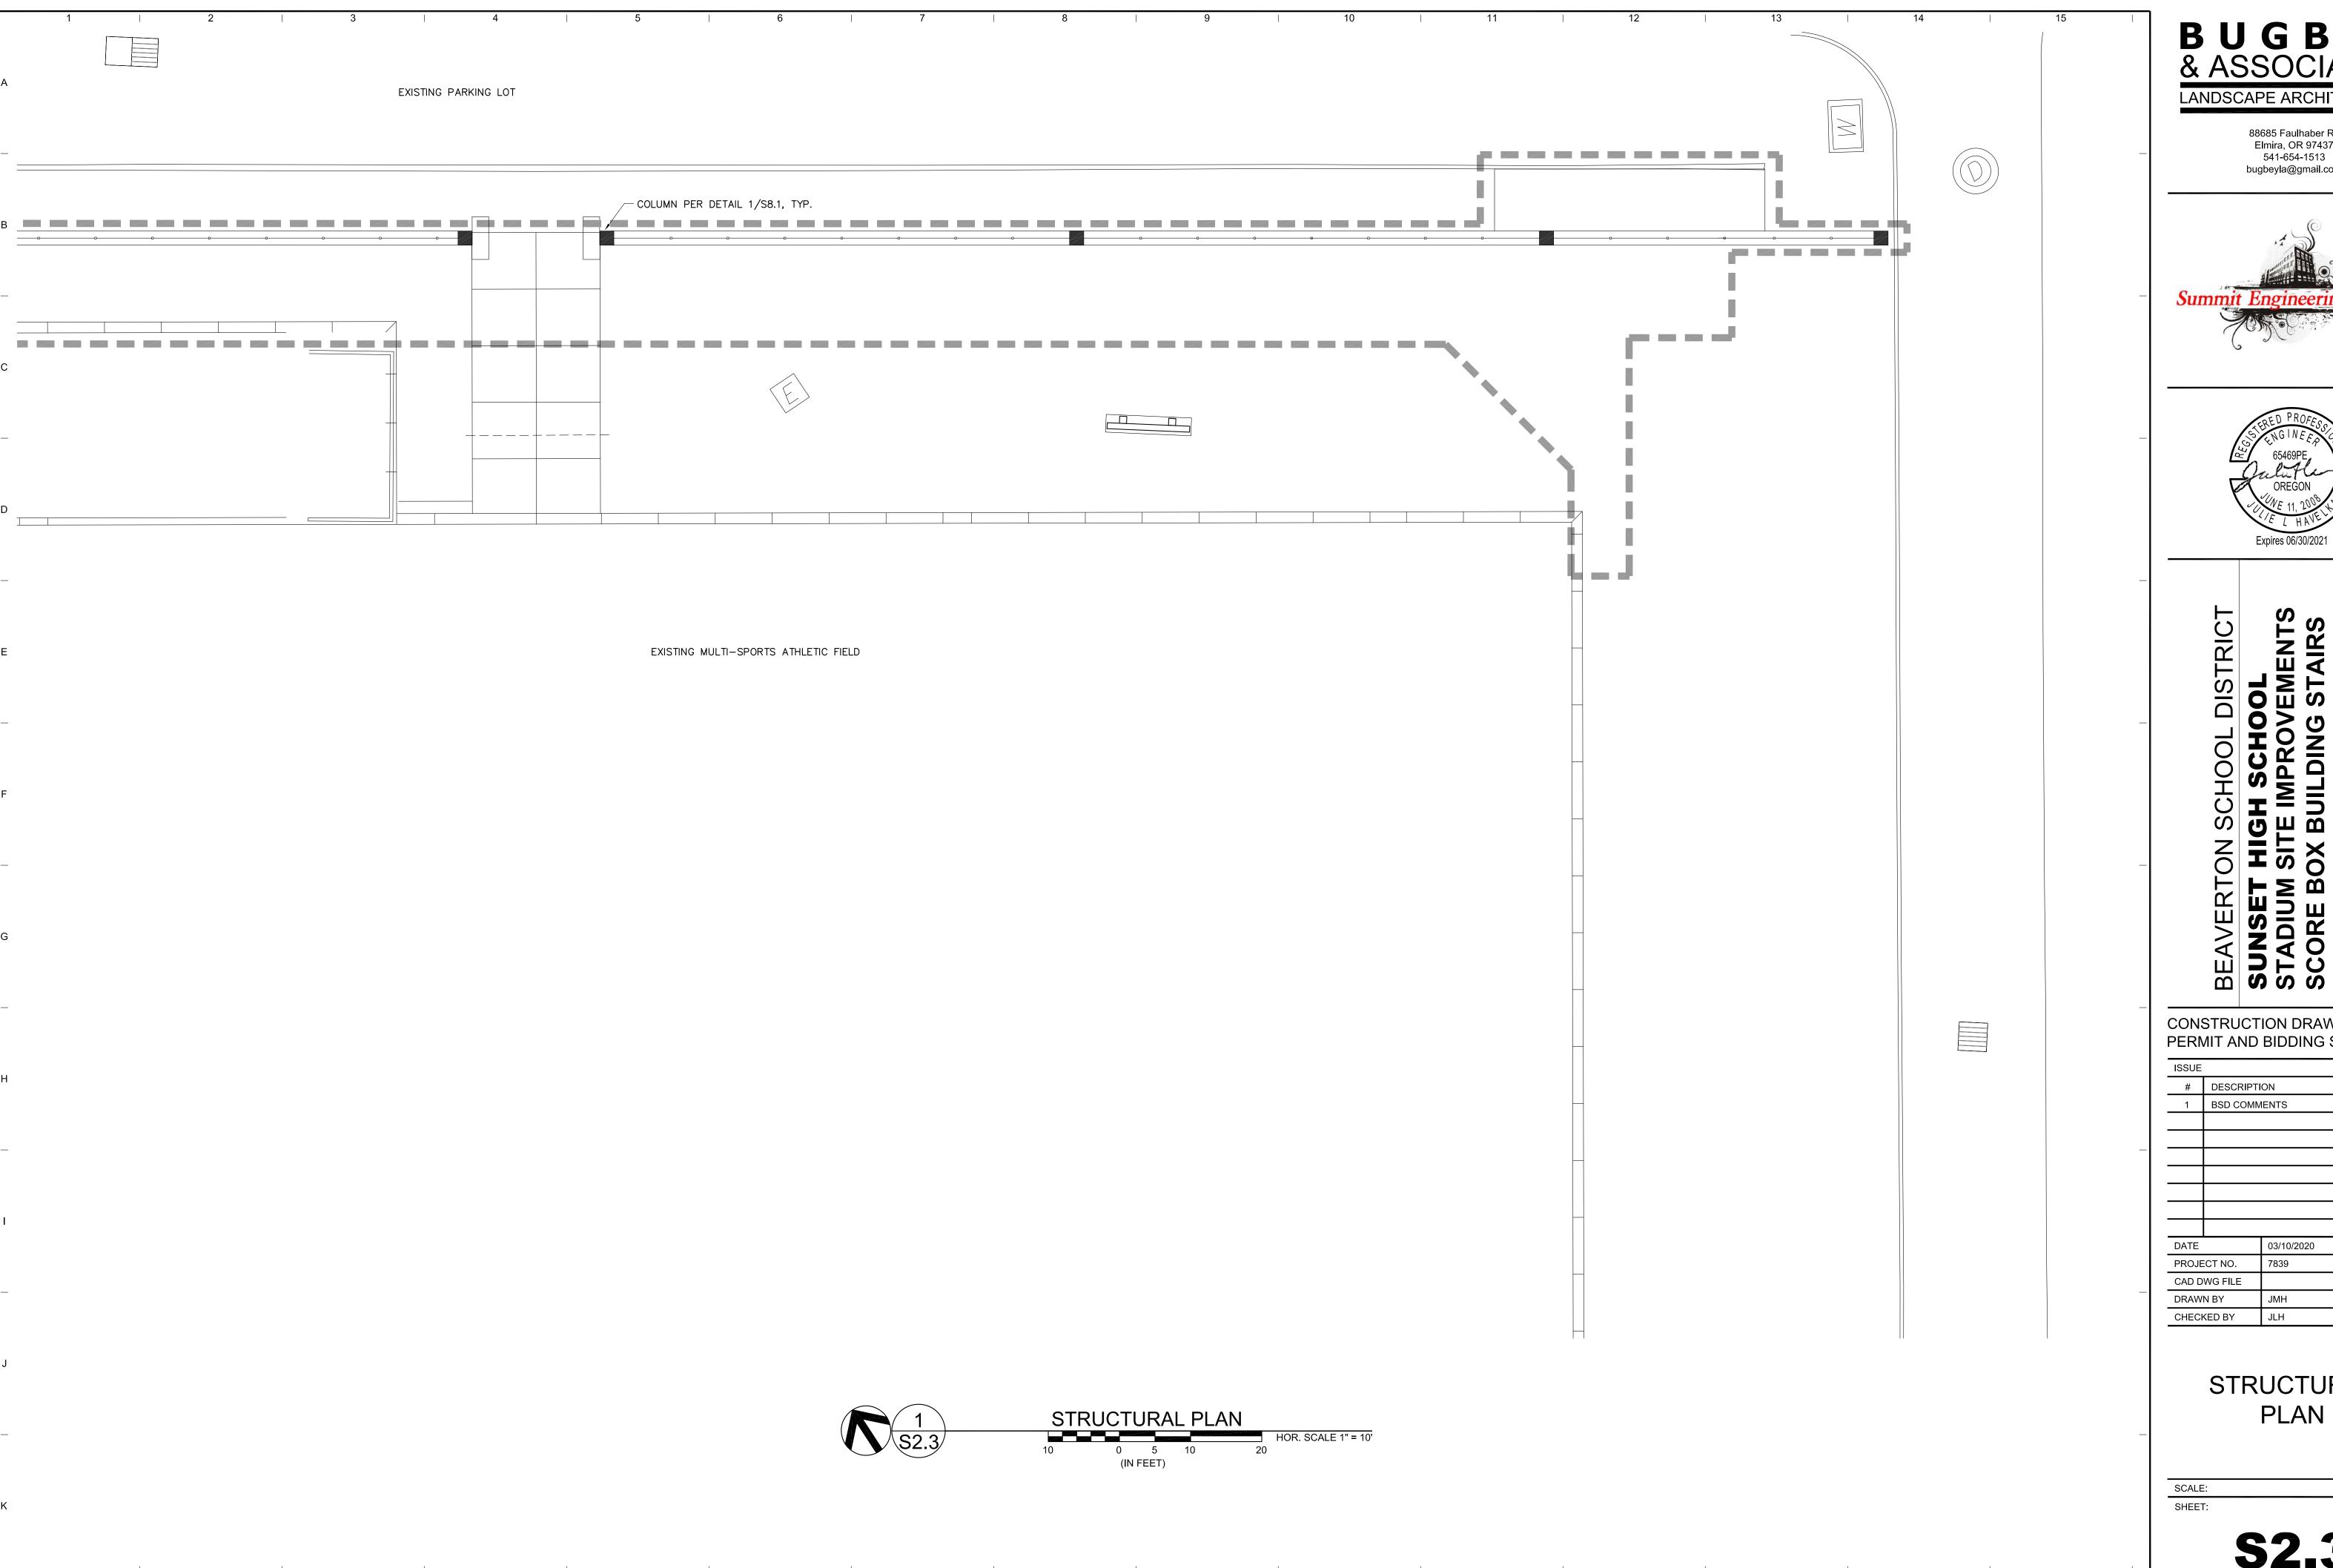

BUGBEY & ASSOCIATES LANDSCAPE ARCHITECTURE

88685 Faulhaber Rd Elmira, OR 97437 541-654-1513 bugbeyla@gmail.com

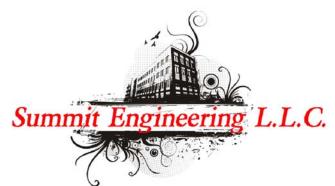




CONSTRUCTION DRAWINGS PERMIT AND BIDDING SET

	PERIVIT AND BIDDING SET			
ISSUE				
#	DESCRIPTI	ON	DATE	
1	BSD COMM	IENTS	03/10/2020	
DATE		03/10/2020		
PROJE	ECT NO.	7839		
CAD D	WG FILE			
DRAW	N BY	JMH		

STRUCTURAL

S2.3

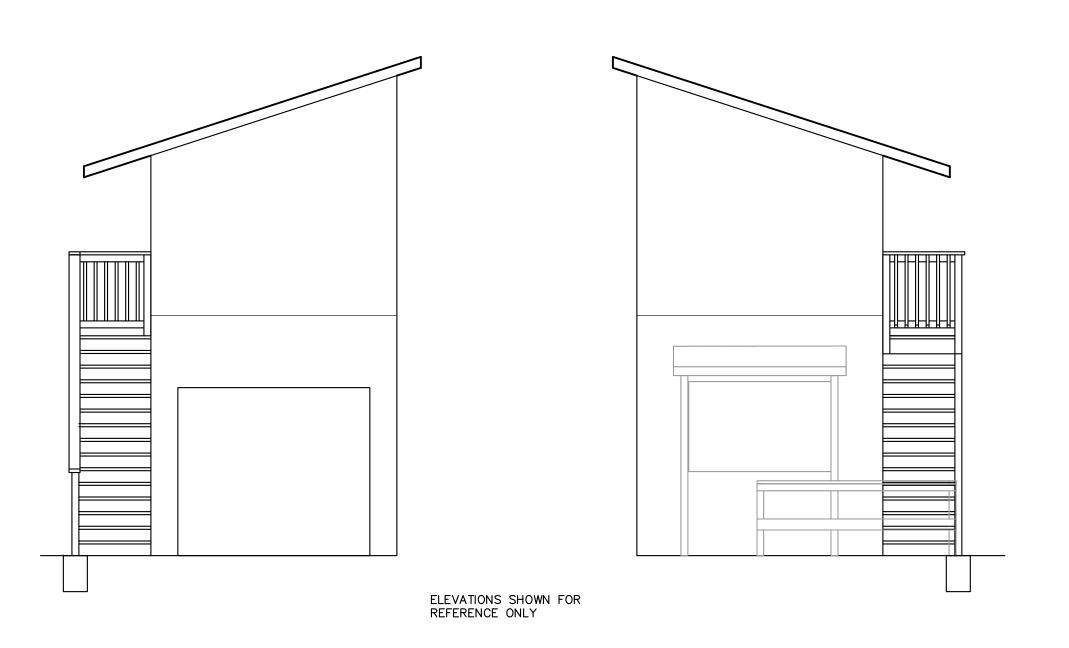


GENERAL STRUCTURAL NOTES


- ALL 2X AND 4X FRAMING SHALL BE DF-L NO. 2 MINIMUM, U.N.O. PER PLAN.
- ALL TIMBER EXPOSED TO WEATHER SHALL BE PRESSURE TREATED.
- ALL CONNECTORS AND FASTENERS AT PRESSURE TREATED WOOD SHALL BE HDG OR Z-MAX.

- CONCRETE SHALL ATTAIN 28 DAY STRENGTH OF 2500 PSI MINIMUM.
- REBAR SHALL BE 60KSI STEEL.


- REBAR SHALL BE 60KSI STEEL.
- FOOTINGS SHALL HAVE 3" CLEAR BOTTOM AND 2" CLEAR TOP AND SIDES FOR REBAR.

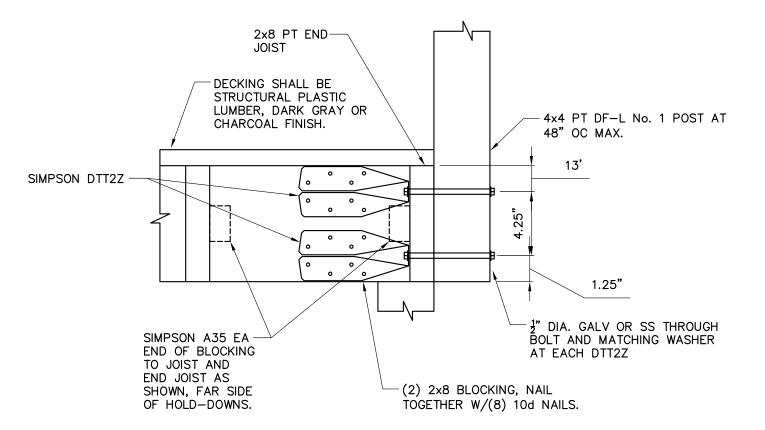

4 POST CONNECTION AT PERPENDICULAR JOIST

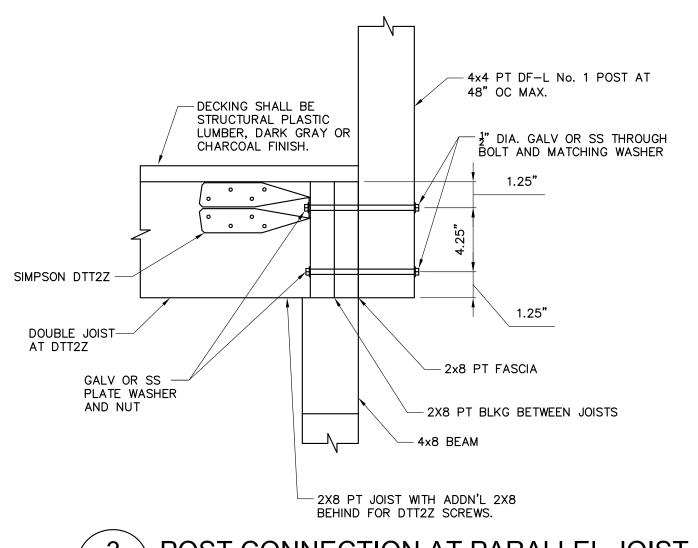


3 POST CONNECTION AT PARALLEL JOIST NTS

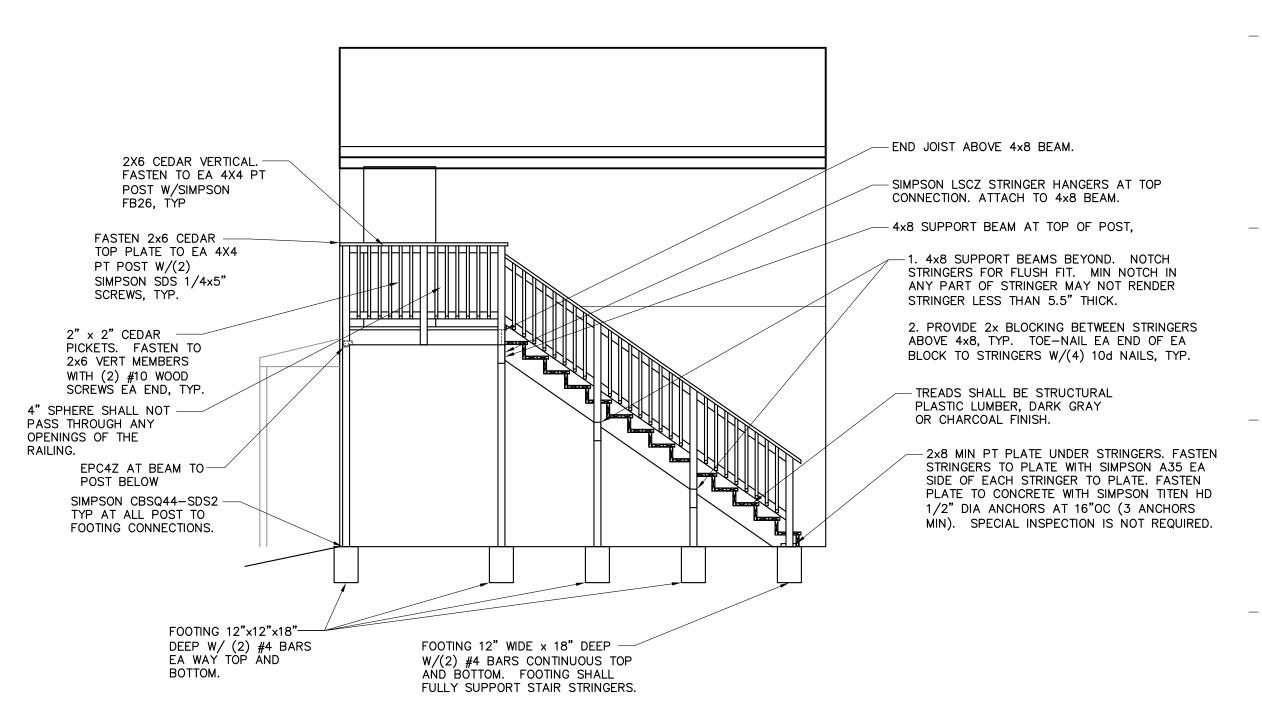

STAIR PLAN AND ELEVATIONS


(IN FEET)

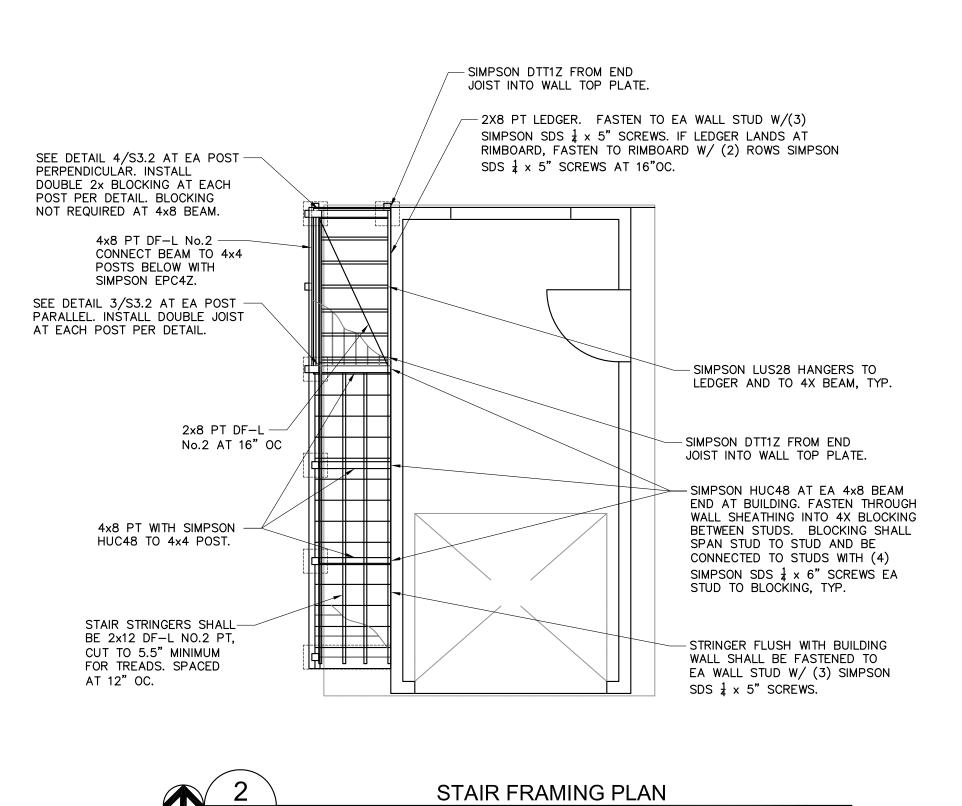

(IN FEET)



88685 Faulhaber Rd Elmira, OR 97437 541-654-1513 bugbeyla@gmail.com

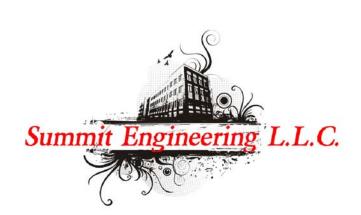



SCHOOL DISTRICT
SCHOOL
APROVEMENTS
LDING STAIRS
ELL ROAD

SUNSET HIGH SOSTADIUM SITE IMPSCORE BOX BUILD 13840 NW CORNEL PORTLAND, OR 972

CONSTRUCTION DRAWINGS
PERMIT AND BIDDING SET


PERI	PERMIT AND BIDDING SET					
ISSUE	ISSUE					
#	DESCRIPTI	ON	DATE			
1	BSD COMM	IENTS	03/10/2020			
DATE		03/10/2020				
PROJI	ECT NO.	7839				
CAD	WG FILE					
DRAW	/N BY	JMH				

STAIR PLAN AND ELEVATIONS

SCALE: SHEET:


CHECKED BY

S3.2

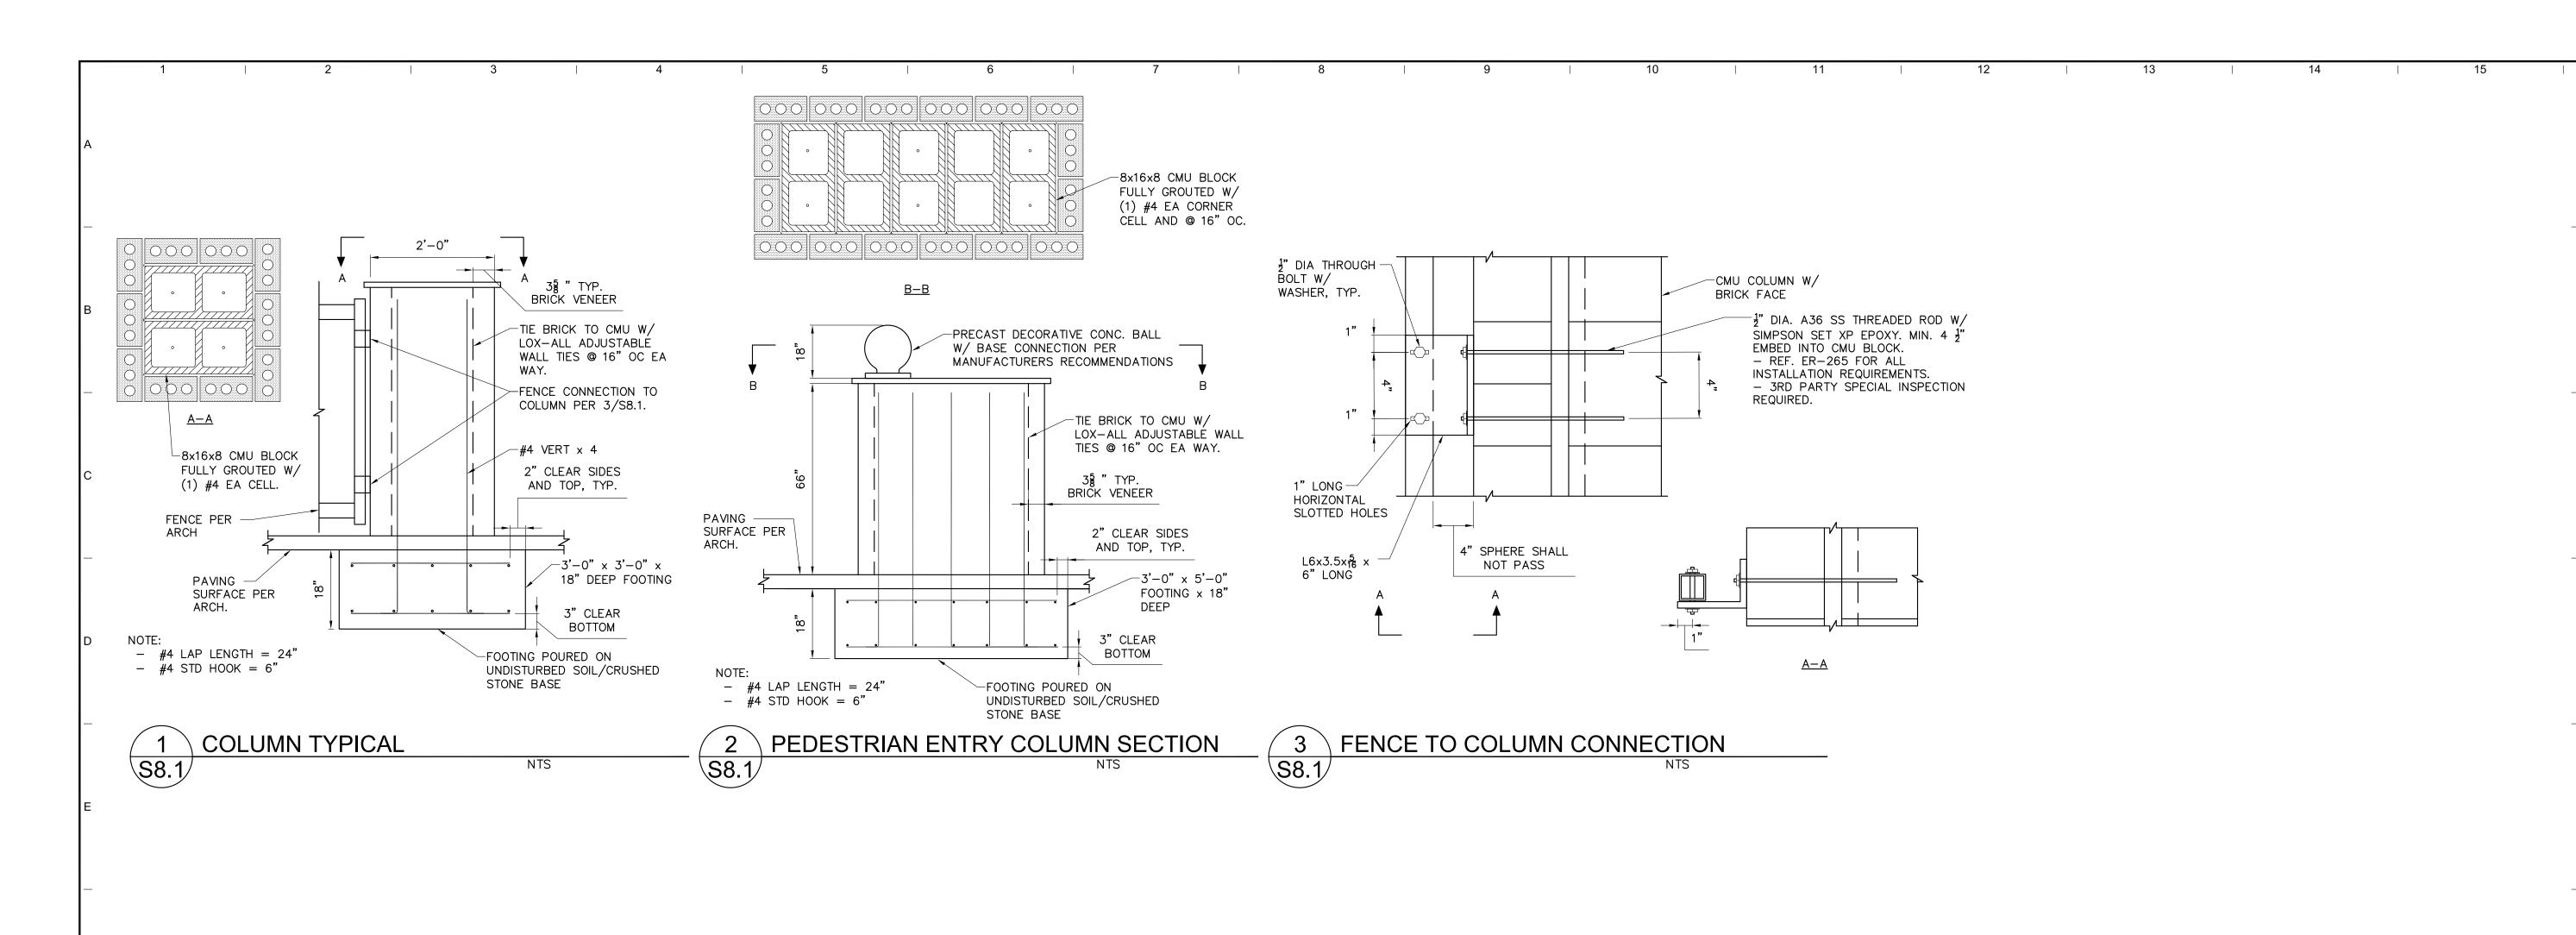



88685 Faulhaber Rd Elmira, OR 97437 541-654-1513 bugbeyla@gmail.com

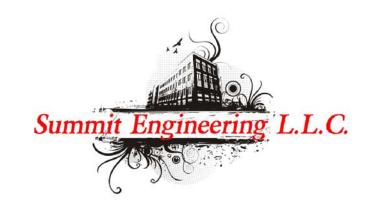



ET HIGH SCHOOL DISTRIC

ET HIGH SCHOOL

UM SITE IMPROVEMENTS

E BOX BUILDING STAIRS

NW CORNELL ROAD

CONSTRUCTION DRAWINGS
PERMIT AND BIDDING SET

ISSUE				
#	DESCRIPTI	DATE		
1	BSD COMM	IENTS	03/10/2020	
DATE		03/10/2020		
PROJECT NO.		7839		
CAD DWG FILE				
DRAWN BY		JMH		

STRUCTURAL DETAILS

SCALI

CHECKED BY

S8.1