SOUTHRIDGE HIGH SCHOOL FREEZER REPLACEMENT

Beaverton School District 16550 SW Merlo Road Beaverton, Oregon 97003

CONTENTS

architectural

food service

A1201 OVERALL FLOOR PLAN

A1401 ENLARGED FLOOR PLAN AND DETAILS

FS-100 FOOD SERVICE SYMBOLS, NOTES & INDEX

DEMO FLOOR PLAN - PLUMBING

DEMO FLOOR PLAN - ELECTRICAL

FLOOR PLAN - ELECTRICAL

SCHEDULES - ELECTRICAL

FLOOR PLAN - PLUMBING

SYMBOL LIST AND GENERAL NOTES - PLUMBING

SYMBOL LIST AND GENERAL NOTES - ELECTRICAL

FS-101 FOOD SERVICE EQUIPMENT PLAN

FS-501 FOOD SERVICE CONDUIT PLAN

FS-502 REFRIGERATION DETAILS

FS-504 BUILDING WORKS PLAN

FS-503 WALK-IN DETAILS

BEAVERTON SCHOOL DISTRICT

Beaverton School District

16550 SW Merlo Road Beaverton, OR 97003 t: (503) 591 8000

architect

IBI Group Architects (USA) Inc. 907 SW Harvey Milk Street Portland, Oregon 97205 t: (503) 226 6950

food service

Webb Food Service Design 3700 SE Lafayette Court Portland, OR 97202 t: (503) 236 8566


plumbing / electrical Interface Engineering

100 SW Main Street Suite 1600 Portland, OR 97204 t: (503) 382 2266

cost consultant

Architectural Cost Consultants 8060 SW Pfaffle Street Portland, OR 97223 t: (503) 718 0075

ARCHITECTURAL SYMBOLS

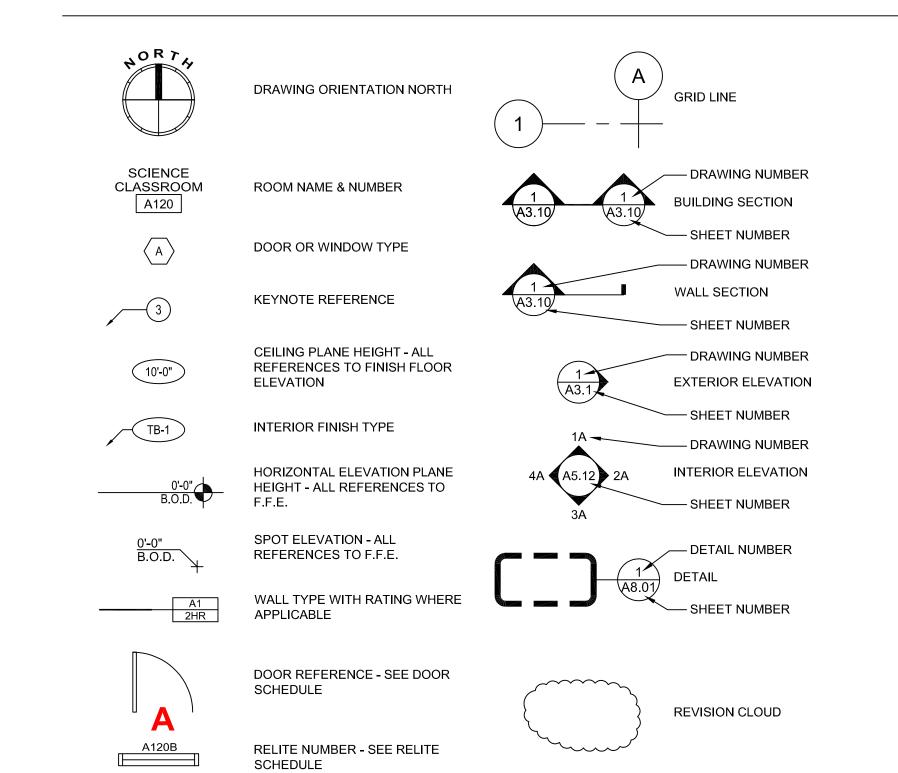

SW Brockman St Custom Painting Krystal Davis CPA Forest Green Apartments Greenway Square Southridge High School 🗟 Construction, LL Magic Hands Cleaning conestoga Recreation and Aquatic Center

ARCHITECTURAL ABBREVIATIONS

L	ANGLE	FDN	FOUNDATION	O.D.	OVERFLOW DRAIN
&	AND	FE	FIRE EXTINGUISHER	OD	OUTSIDE DIAMETER
AB	ANCHOR BOLT	FEC	FIRE EXTINGUISHER CABINET	ОН	OVERHEAD
ACT	ACOUSTICAL CEILING TILE	FF	FINISH FLOOR	OPNG	OPENING
ADD	ADDENDUM	FFE	FINISH FLOOR ELEVATION	OPP	OPPOSITE
A.F.F.	ABOVE FINISH FLOOR	FIN	FINISH	OS	OUTSIDE
AHJ	AUTHORITY HAVING JURISDICTION	FL	FLOOR	PIP	POURED IN PLACE
ALS	AREA LIGHT STANDARD	FO	FACE OF	PL	PROPERTY LINE
ALUM	ALUMINUM	FOC	FACE OF CONCRETE	PLAS	PLASTER
ANOD	ANODIZED	FOF	FACE OF FINISH	PLYWD	PLYWOOD
BC	BOTTOM OF CURB	FOM	FACE OF MASONRY	PSF	PER SQUARE FOOT
BD	BOARD	FOS	FACE OF STUD	P.T.	PRESSURE TREATED
BLDG	BUILDING	FOIC	FURNISHED BY OWNER INSTALLED	PVMT	PAVEMENT
BLKG	BLOCKING		BY CONTRACTOR		RADIUS
B.M.	BENCH MARK	FOIO	FURNISHED BY OWNER INSTALLED	R.D.	ROOF DRAIN
BM	BEAM		BY OWNER	REF	REFERENCE
BOT	BOTTOM	FRT	FIRE RETARDANT TREATED	REFR	REFRIGERATOR
BTU	BRITISH THERMAL UNIT	FTG	FOOTING	REQ'D	REQUIRED
BTWN	BETWEEN	FURR	FURRING	REV	REVISE OR REVISION
EOR C	CHANNEL	GA	GAUGE	RM	ROOM
СВ	CATCH BASIN	GALV	GALVANIZED	R.O.	ROUGH OPENING
CCTV	CLOSED CIRCUIT TV	GB	GRAB BAR	RCP	REFLECTED CEILING PLAN
CG	CORNER GUARD	GC	GENERAL CONTRACTOR	SC	SOLID CORE
CLG	CEILING	GL	GLASS	SECT	SECTION
CLR	CLEAR	GND	GROUND	SF	SQUARE FOOT
CJ	CONTROL JOINT	GVP	GYPSUM VENEER PLASTER	SHTG	SHEATHING
CMU	CONCRETE MASONRY UNIT	GWB	GYPSUM WALL BOARD	SHWR	SHOWER
CONT	CONTINUOUS	HB	HOSE BIB	SHT	SHEET
CORR	CORRIDOR	HC	HANDICAP	SIM	SIMILAR
CS.J	CONSTRUCTION JOINT	HDWR	HARDWARE	SJ	SEISMIC JOINT
CSMT	CASEMENT	HM	HOLLOW METAL	SM	SHEET METAL
CT	CERAMIC TILE	HW	HOT WATER	SPEC	SPECIFICATION
CTR	CENTER	HVAC	HEATING, VENTILATION AND	SQ	SQUARE
Ę	CENTERLINE	TIVAO	AIR CONDITIONING	SS	STAINLESS STEEL
DBL	DOUBLE	INSUL	INSULATION	STD	STANDARD
DTL	DETAIL	INT	INTERIOR	STL	STEEL
DF	DRINKING FOUNTAIN	JAN	JANITOR	STOR	STORAGE
DIA	DIAMETER	JT	JOINT		STRUCTURAL
DIAG	DIAGONAL	JST	JOIST	SUSP	SUSPENDED
DIM	DIMENSION	L.	LENGTH	T	TEMPERED GLAZING
DISP	DISPENSER	LAV	LAVATORY	TC	TOP OF CURB
DN	DOWN	LB	LAG BOLT	TEL	TELEPHONE
DP	DAMPROOFING	LKR	LOCKER	T&G	TONGUE AND GROOVE
DR	DOOR	LS	LANDSCAPING	THK	THICK
DS	DOWN SPOUT	LVR	LOUVER	TJ	TOOL JOINT
DWG	DRAWING	MAT'L	MATERIAL	TP	TOP OF PAVEMENT
EA	EACH	MAX	MAXIMUM	TS	TUBE STEEL
EF	EXHAUST FAN	MECH	MECHANICAL	TYP	TYPICAL
EJ	EXPANSION JOINT	MED	MEDIUM	TOD	TOP OF (MATERIAL)
EL	ELEVATION	MEZZ	MEZZANINE	UNFIN	UNFINISHED
ELEC	ELECTRICAL	MFR	MANUFACTURER	UNO	UNLESS NOTED OTHERWISE
E.O.S.	EDGE OF SLAB	MH	MANHOLE	VB	VAPOR BARRIER
E.O.S. ENGR	ENGINEER	MIN	MINIMUM	VERT	VERTICAL
EP	ELECTRICAL PANEL	MIR	MIRROR	VEST	VESTIBULE
				VEST	
EQ EQUIP	EQUAL	MISC	MISCELLANEOUS	W/	VERIFY WITH
	EQUIPMENT	MTD	MOUNTED		
ES EW	EACH WAY	MTL	METAL NOT ARRIVEARIE	WC	WATER CLOSET
EW	EACH WAY	NA NIC	NOT APPLICABLE	WD	WOOD
EXST	EXISTING	NIC	NOT IN CONTRACT	WF	WIDE CLASS
(E)	EXISTING	NOM	NOMINAL NELCON STUD	WG	WIRE GLASS
EXP	EXPANSION	NS	NELSON STUD	WH	WATER HEATER
EXT	EXTERIOR	NTS	NOT TO SCALE	W/O	WITHOUT
FA	FIRE ALARM	OA	OVERALL	WP	WATER PROJECTIVE BARRIER
FBO FD	FURNISHED BY OTHERS	ОС	ON CENTER	WRB WT	WATER RESISTIVE BARRIER WEIGHT

SCHOOL ADDRESS

VICINITY MAP

Southridge High School 9625 SW 125th Ave., Beaverton, OR 97008 Phone: (503) 356-2890 AHJ: City of Beaverton Tax Lot #: 1S128DD00300

DEFERRED SUBMITTALS


FREEZER/COOLER SHOP DRAWINGS

ALTERNATES

ALTERNATE #1 - RELOCATED POWER FOR HEATED CABINET

B

BID DOCUMENTS

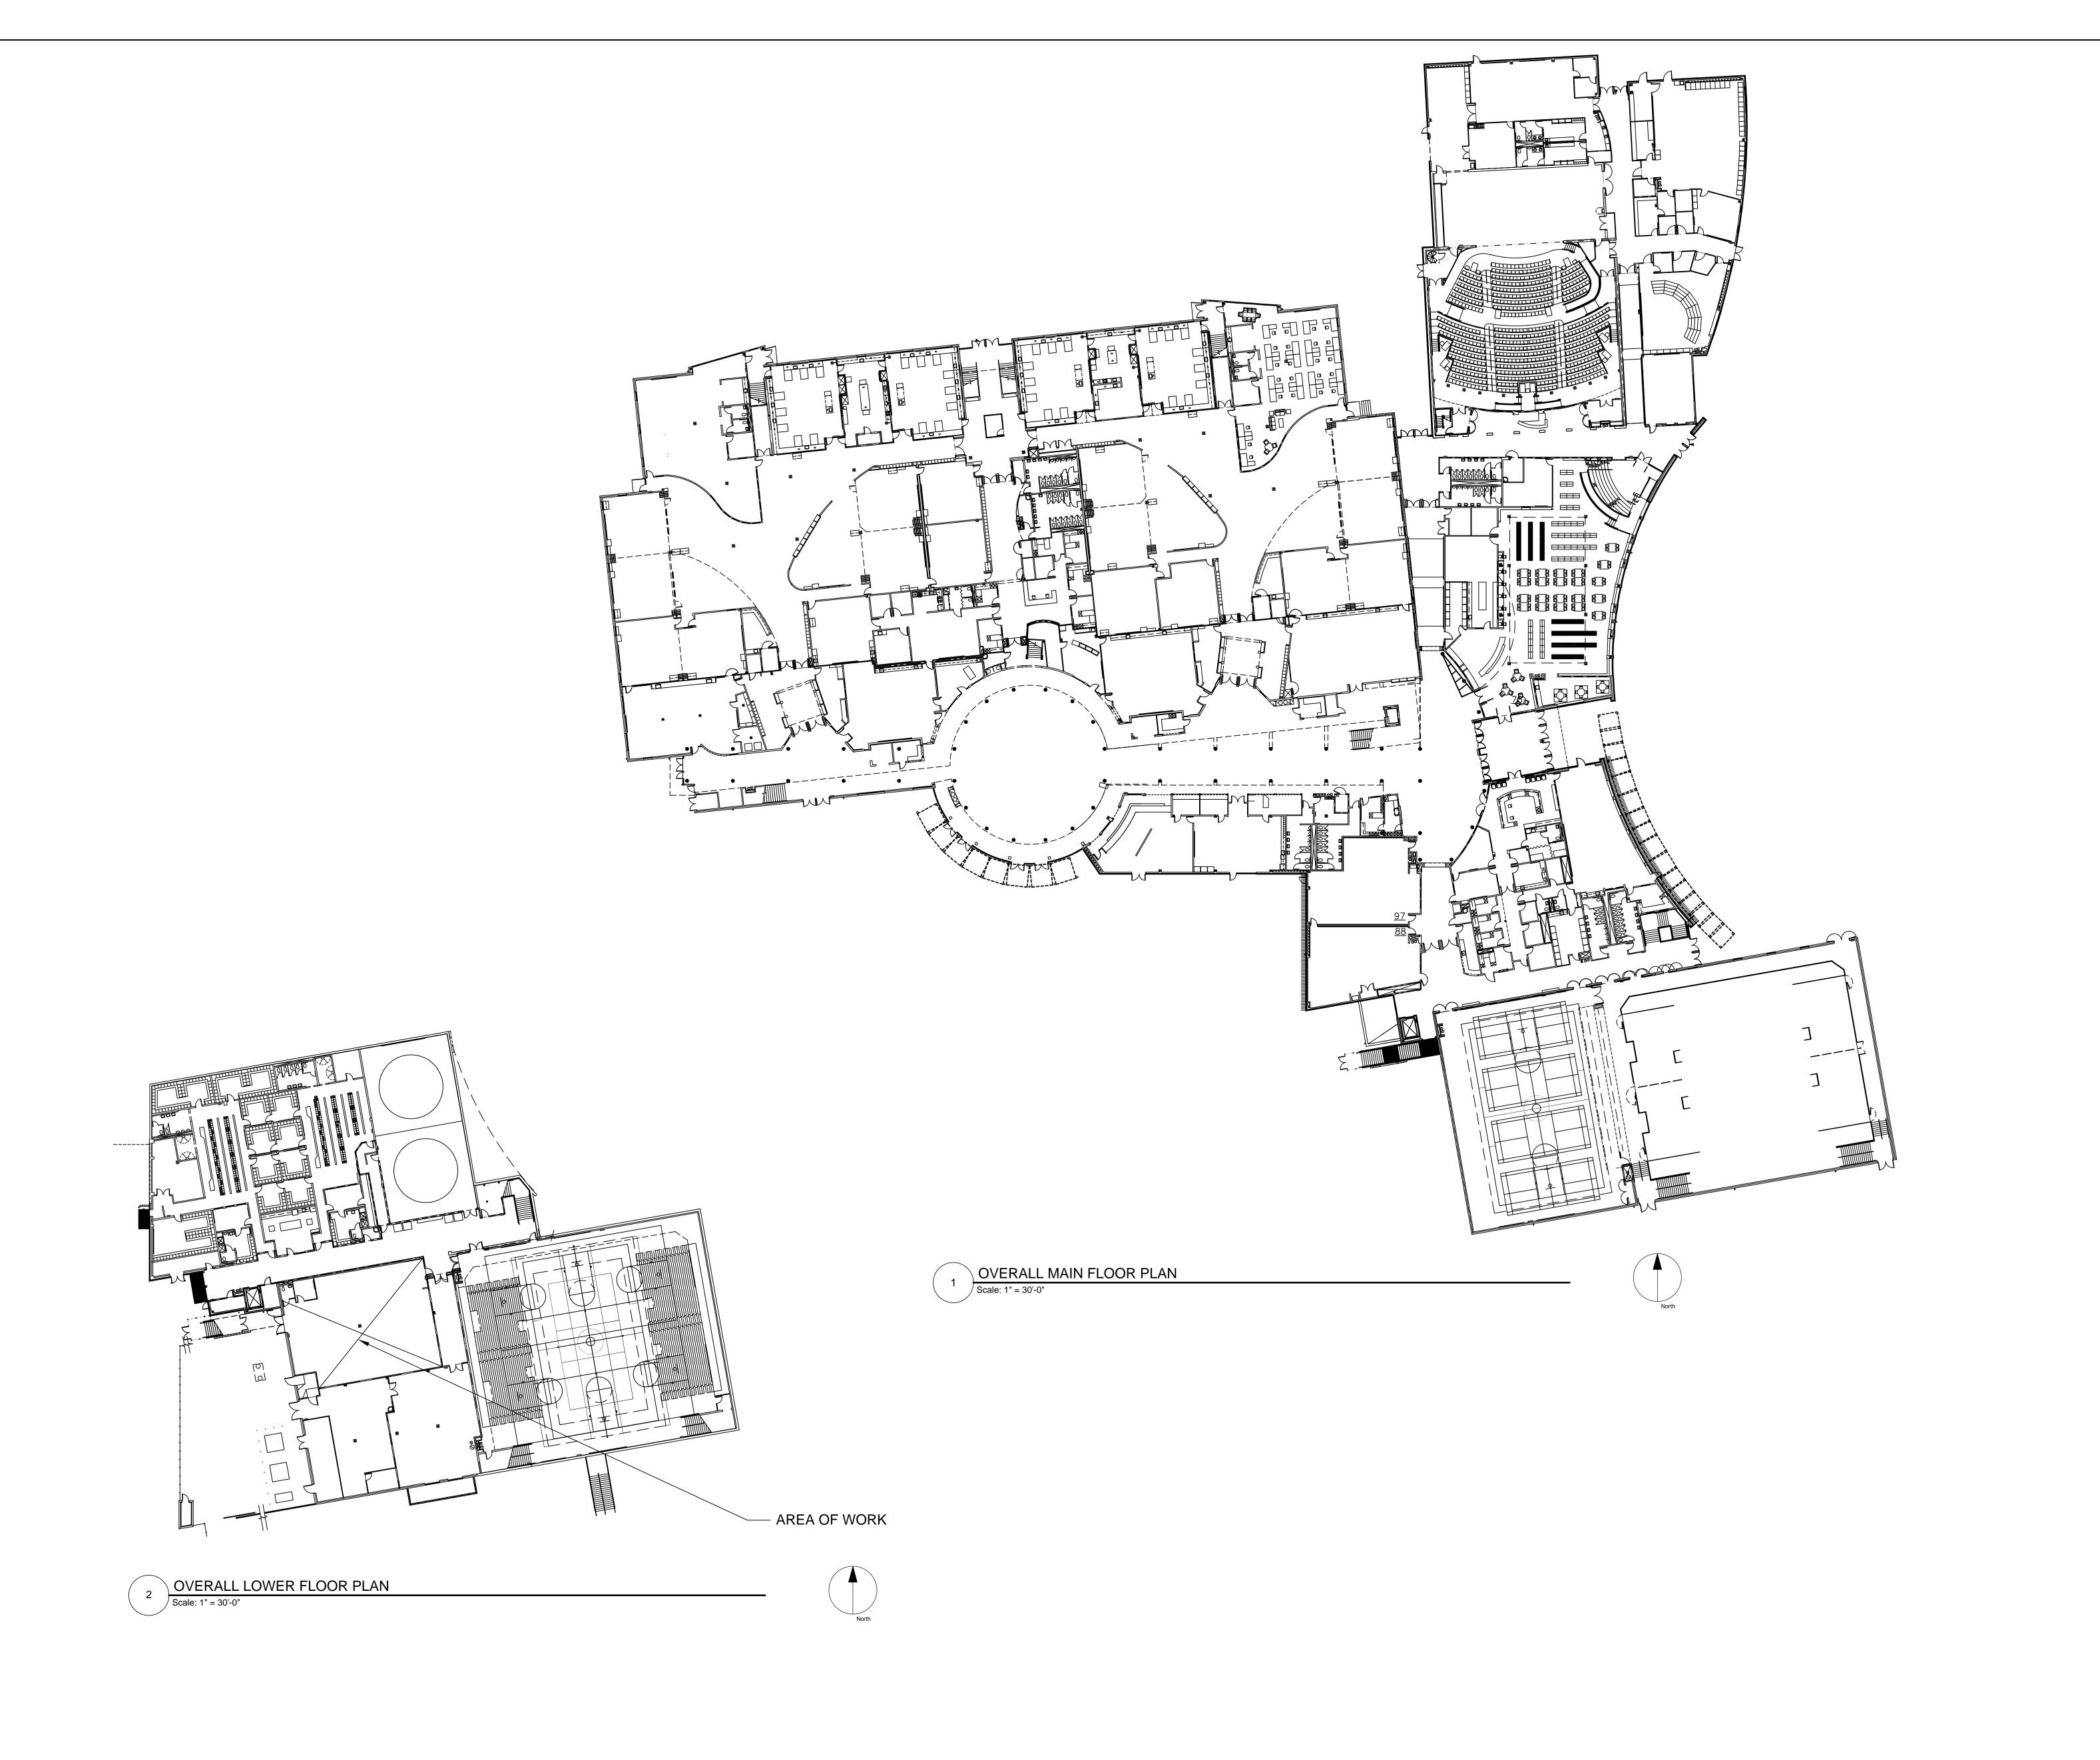

Beaverton School District BEAVERTON SCHOOL DISTRICT 16550 SW Merlo Rd. OR 97003

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CONSULTANTS




IBI GROUP
907 SW Harvey Milk Street
Portland, OR 97205, USA
tel 503 226 6950 fax 503 273 9192
ibigroup-edpnw.com

SOUTHRIDGE HS FREEZER REPLACEMENT 9625 SW 125TH AVENUE BEAVERTON, OR 97008

PROJECT NO: 139249 DRAWN BY: CHECKED BY: JF PROJECT MGR: APPROVED BY:


SHEET TITLE
OVERALL FLOOR PLANS

SHEET NUMBER
A1201

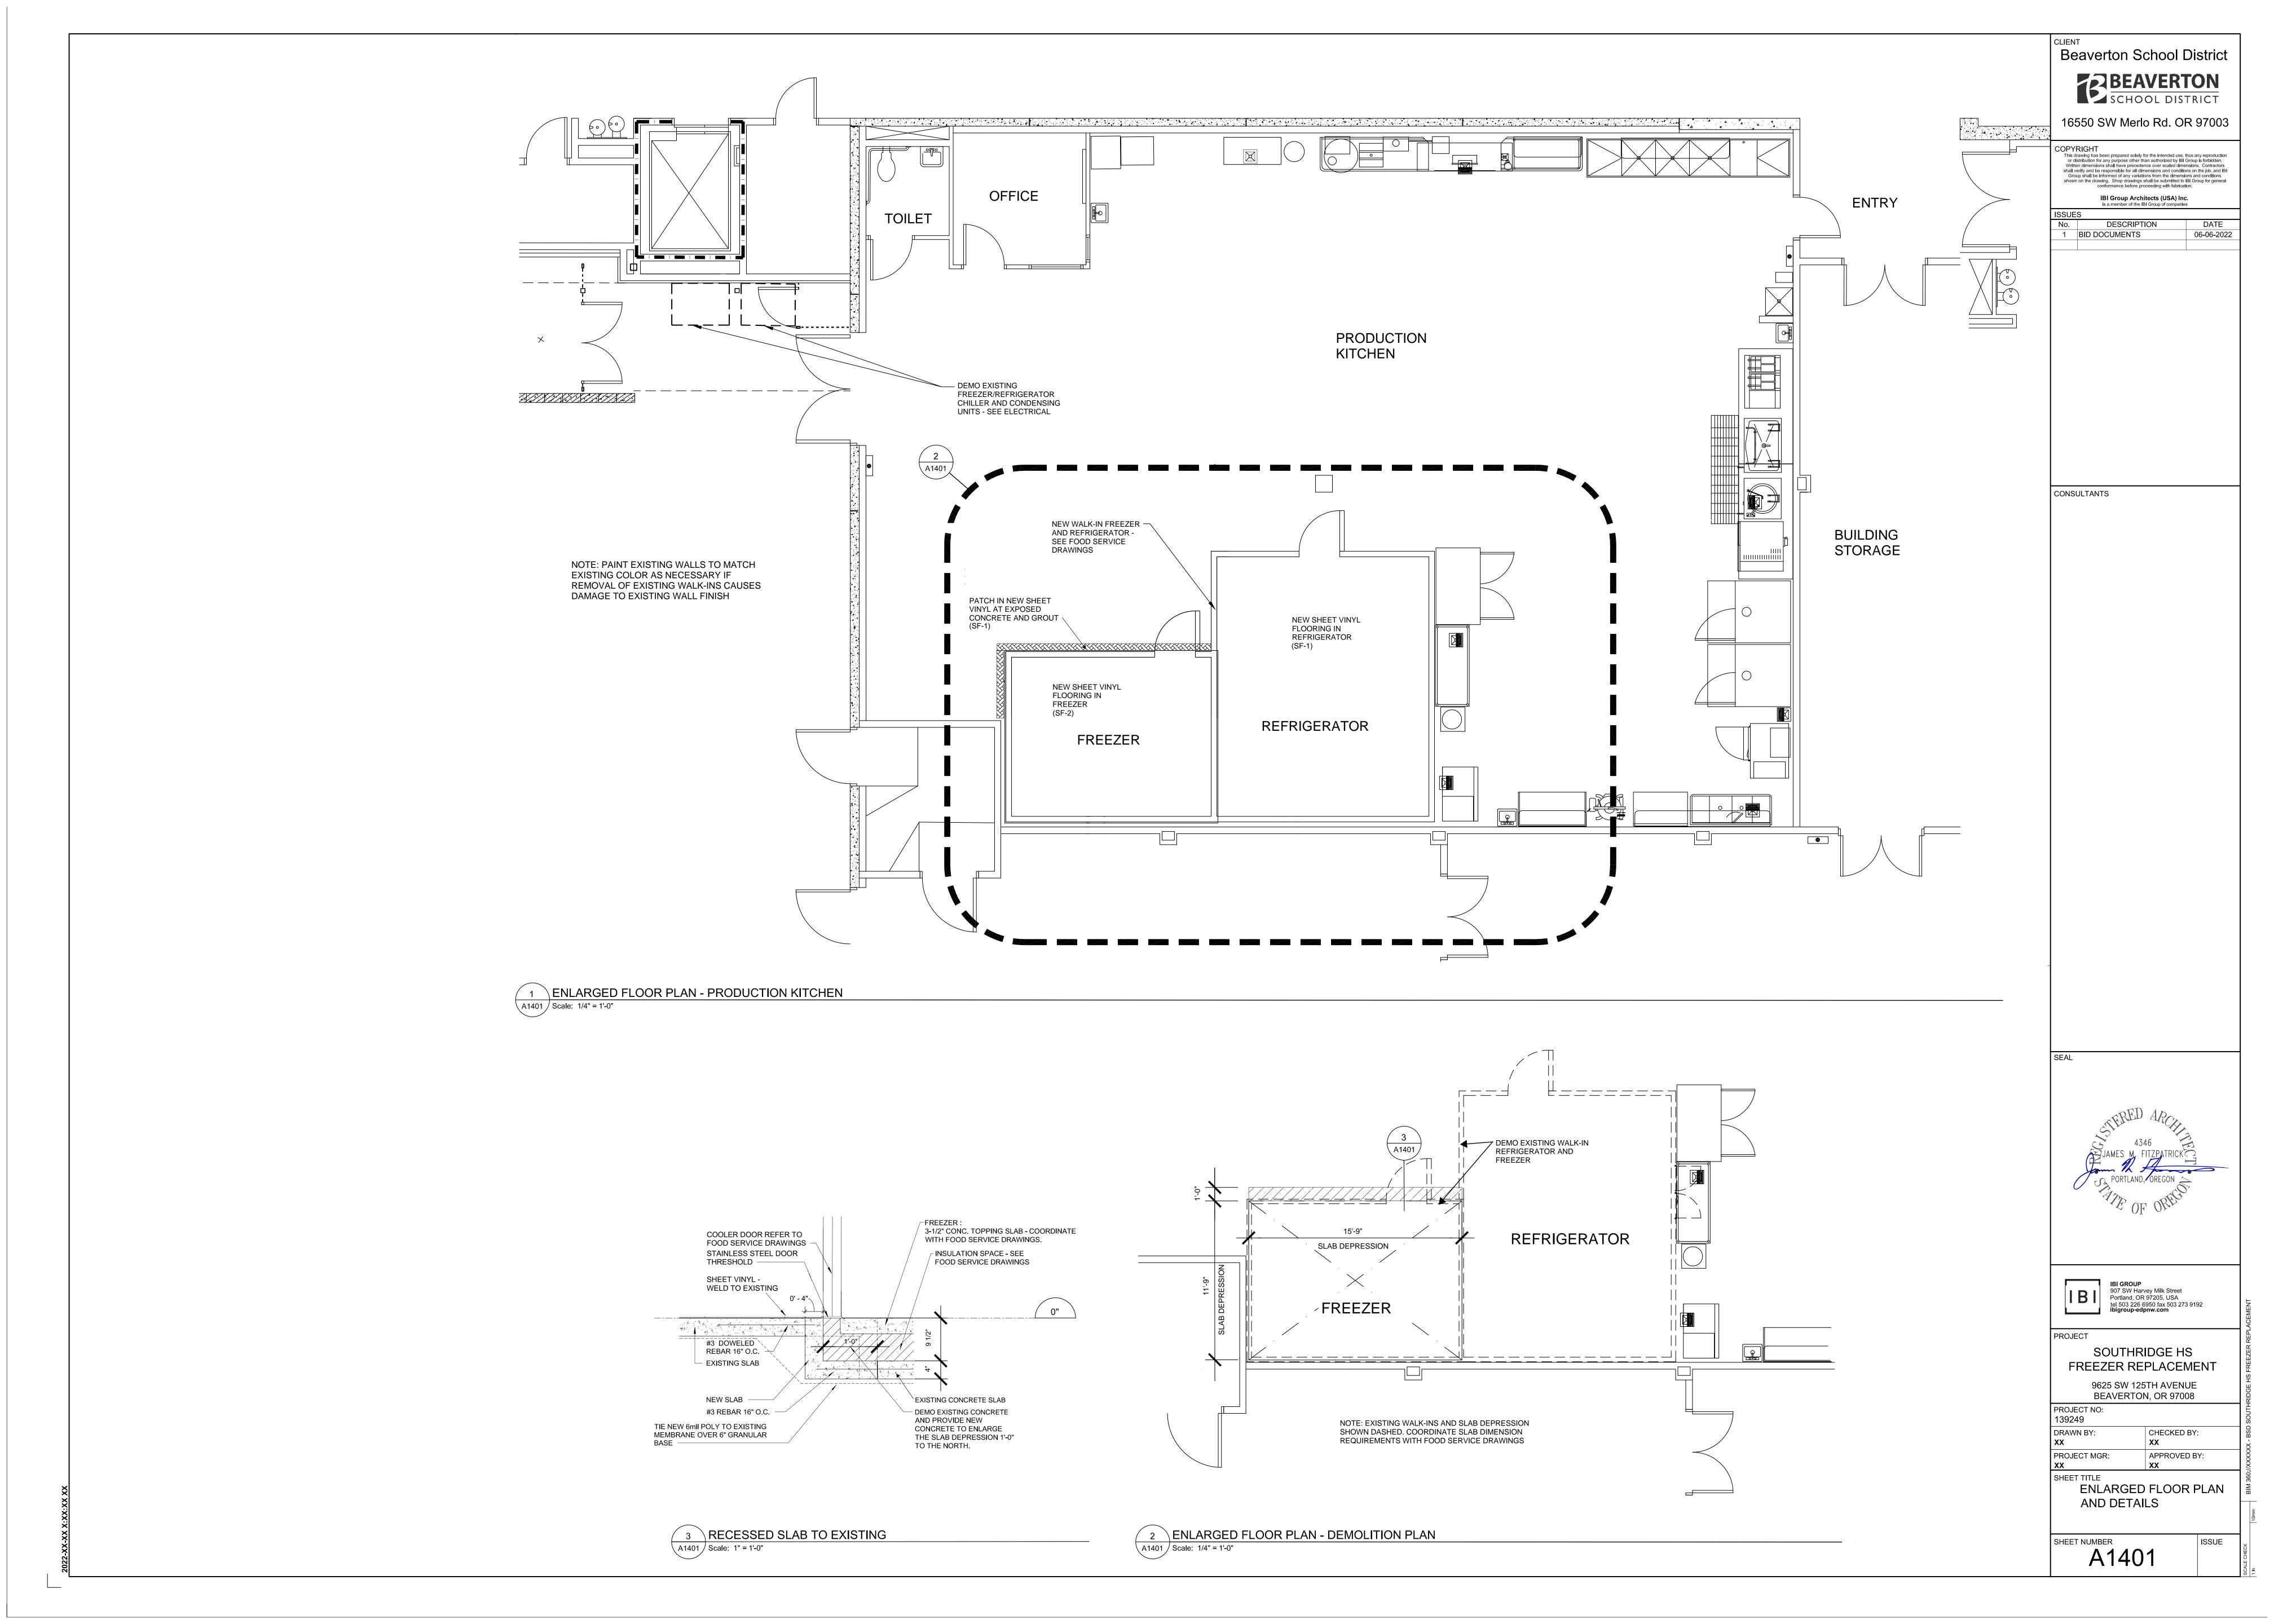

GENERAL NOTES	ENVIRONMENTAL NOTES		ABBREVIATIONS		SYMBOLS	SHEET INDEX	Beaverton School District
1 THESE PLANS ARE A GENERAL ARRANGEMENT OF EQUIPMENT FOR THE CONVENIENCE OF CONTRACTORS AND IS MADE FROM AVAILABLE INFORMATION. WEBB FOODSERVICE DESIGN ASSUMES NO RESPONSIBILITY FOR THE ACCURACY OF THE MEASUREMENTS.	1 ALL FOOD-RELATED AND UTENSIL RELATED EQUIPMENT SHALL BEAR THE ANSI/NSF EMBLEM AND/OR BE MANUFACTURED OR FABRICATED IN ACCORDANCE WITH APPROPRIATE ANSI/NSF STANDARD. SPECIFICALLY STANDARD 2 AND FOR ALL REFRIGERATED EQUIPMENT STANDARD 7.	"T" (N) * A	TEE NEW SEE REMARKS COLUMN AMPS	FS-701	ELEVATION REFERENCE	FS-100 FOODSERVICE SYMBOLS, NOTES, & INDEX FS-101 FOODSERVICE EQUIPMENT PLAN & SCHEDULE FS-501 FOODSERVICE REFRIGERATION & CONDUIT PLAN FS-502 REFRIGERATION DETAILS FS-503 WALK-IN DETAILS	BEAVERTON SCHOOL DISTRICT 16550 SW Merlo Rd. OR 97003
FABRICATORS, CONTRACTORS, AND OTHERS UTILIZING THESE PLANS IN CONNECTION WITH THIS JOB ARE RESPONSIBLE FOR SECURING THEIR OWN MEASUREMENTS FOR PREPARATION OF SUBMITTALS AND	2 FLOORS IN FOOD PREPARATION, FOOD STORAGE, WAREWASHING, JANITORIAL, HANDWASHING AND TOILET AREAS SHALL BE SMOOTH	A.F.F. A.G.A.	ABOVE FINISH FLOOR AMERICAN GAS ASSOCIATION	1		FS-503 WALK-IN DETAILS FS-504 BUILDING WORKS PLAN	COPYRIGHT This drawing has been prepared solely for the intended use, thus any reproduction or distribution for any purpose other than authorized by IBI Group is forbidden. Written dimensions shall have precedence over scaled dimensions. Contractors
CONSTRUCTION. PLUMBING AND ELECTRICAL INFORMATION INDICATED ON THESE PLANS ARE GENERALLY FOR FOOD SERVICE	AND IMPERVIOUS TO WATER, GREASE, AND ACID AND OF EASILY CLEANABLE CONSTRUCTION WITH 6" CONTINUOUS SELF-COVED	AL ALT	ALUMINUM ALTERNATE	FS-701 2	MULTIPLE ELEVATION REFERENCE		written dimensions shall have precedence over scaled dimensions. Contractors shall verify and be responsible for all dimensions and conditions on the job, and IBI Group shall be informed of any variations from the dimensions and conditions shown on the drawing. Shop drawings shall be submitted to IBI Group for general conformance before proceeding with fabrication.
EQUIPMENT AND ARE INTENDED AS REFERENCE ONLY. WEBB FOODSERVICE DESIGN IS NOT RESPONSIBLE FOR THE ENGINEERING THEREOF OR FOR ANY PLUMBING OR ELECTRICAL FITTINGS, WORK,	BASE WITH 3/8" RADIUS. WHERE EQUIPMENT IS INSTALLED ON A CURB, SELF-COVED BASE IS TO EXTEND 4". 3 AT EXTERIOR TRASH HOLDING AREAS. A CONCRETE SLAB MUST BE	APPROX ARCH	APPROXIMATE ARCHITECT	3	DETAIL DEFEDENCE		IBI Group Architects (USA) Inc. is a member of the IBI Group of companies ISSUES
AND/OR CONNECTIONS UNLESS SPECIFICALLY PROVIDED FOR IN THE SPECIFICATIONS. WEBB FOODSERVICE DESIGN ASSUMES NO RESPONSIBILITY FOR THE WORK DONE BY THE CONTRACTORS NOR	PROVIDED FOR TRASH, GARBAGE AND GREASE CONTAINERS. IF WALLS ENCLOSE THE AREA, THE INTERIOR WALL SURFACES ARE TO	BLDG BTU	BUILDING BRITISH THERMAL UNIT	FS-801	DETAIL REFERENCE		No.DESCRIPTIONDATE1BID DOCUMENTS06-06-202
FOR ANY CHANGES MADE NECESSARY BY THE LOCAL BUILDING CODES, ORDINANCES, STRUCTURAL CONDITIONS, OR BY THE	BE SMOOTH, SEALED AND WASHABLE (E.G. PLASTERED SMOOTH AND PAINTED, ETC.)	C C.M.U.	CONVENIENCE OUTLET CONCRETE MASONRY UNITS	1 FS-801	SECTION REFERENCE		
SUBSTITUTION OR CHANGES MADE NECESSARY IN EQUIPMENT SHOWN ON THIS PLAN. THE PLANS AND DESIGNS CONTAINED HEREIN ARE THE PROPERTY OF WEBB FOODSERVICE DESIGN AND MAY NOT	4 ALL FLOOR MOUNTED EQUIPMENT WILL BE INSTALLED ON MINIMUM 6" SANITARY LEGS, CASTERS OR COMPLETELY SEALED IN POSITION ON A 4" HIGH CURB WITH CONTINUOUSLY COVED BASE. COUNTER	CFCI CLG.	CONTRACTOR FURNISHED CONTRACTOR INSTALLED CEILING CLEAR				
BE REPORDUCED OR USED BY ANYONE, EITHER ALL OR IN PART, WITHOUT FIRST SECURING THE WRITTEN PERMISSION OF WEBB	TOP EQUIPMENT SHALL BE MOUNTED ON 4" SANITARY LEGS OR SEALED TO THE COUNTER UNLESS READILY MOVEABLE.	CLR CO COL	CONVENIENCE OUTLET COLUMN	# FS-801/	ENLARGED PLAN/ DETAIL REFERENCE		
FOODSERVICE DESIGN. 2 CONTRACTORS ARE TO MAKE ALLOWANCE FOR ELBOWS, TRAPS,	5 ALL REFRIGERATION EQUIPMENT SHALL HAVE A THERMOMETER WHICH IS EASILY READABLE AND IN PROPER WORKING CONDITION. 6 WALLS IN FOOD PREPARATION AREAS AND DISHWASHING AREAS	CONC CONN	CONCRETE CONNECTION				
ETC. AND ARE TO MAKE FINAL CONNECTIONS ON THE JOB, SUPPLYING ALL NECESSARY VALVES, TRAPS, STEAM TRAPS, FAUCETS, STARTING SWITCHES FOR MOTORS, ETC. EXCEPT WHERE	SHALL BE SMOOTH AND NON-ABSORBENT WITH A LIGHT COLORED, EASILY CLEANABLE FINISH. ALL PAINTED SURFACES SHALL BE	CONST CONT	CONSTRUCTION CONTINUOUS	P-1	SPECIFICATION REFERENCE SEE TYPICAL SPECIFICATION SYMBOL (ON INTERIOR DRAWINGS)		
SPECIFICALLY NOTED OTHERWISE IN THE WRITTEN SPECIFICATIONS. 3 ANY DISCREPANCIES BETWEEN PLANS, BUILDING, AND LOCAL CODE	SEALED WITH A GLOSS OR SEMI-GLOSS ENAMEL. 7 CEILINGS IN KITCHEN PREPARATION AREAS SHALL BE SMOOTH AND NON AREADERS TO SHALL BE SMOOTH AND NON AREADERS TO SHALL BE SMOOTH AND NON AREADERS.	CONTR CW	CONTRACTOR COLD WATER		(ON INTERIOR DRAWINGS)		
REQUIREMENTS THAT MAY AFFECT THE INSTALLATION, FABRICATION, OR OVERALL WORK IN ANY WAY SHALL BE BROUGHT TO THE ATTENTION OF THE FOOD SERVICE EQUIPMENT CONTRACTOR	NON-ABSORBENT WITH A LIGHT COLORED, EASILY CLEANABLE FINISH. ALL PAINTED SURFACES SHALL BE SEALED WITH A GLOSS OR SEMI-GLOSS FINISH.	D DCO	DIRECT CONNECTION DUPLEX CONVENIENCE OUTLET	N	ITEM NUMBER		
IMMEDIATELY. 4 IT SHALL BE THE RESPONSIBILITY OF THE OWNER, ARCHITECT,	8 LAVATORY (HANDWASHING) SINKS SHALL BE PROVIDED IN THE FOOD PREPARATION, FOOD SERVING AND WAREWASHING AREAS.	DET DFA	DETAIL DOWN FROM ABOVE		NORTH ARROW		
ENGINEERS, AND/OR GENERAL CONTRACTOR TO INSURE THAT THE FOOD SERVICE EQUIPMENT CONTRACTOR RECEIVES COPIES OF ALL	SOAP AND SANITARY TOWELS SHALL BE PROVIDED IN SINGLE SERVICE, PERMANENTLY INSTALLED DISPENSERS AT THE LAVATORY SINKS. ALL HANDWASHING SINKS SHALL HAVE A	DIA DIM	DIAMETER DIMENSION	#	REVISION DELTA		
ADDENDUMS AND CHANGES TO THE BUILDING PLANS, PRIOR TO, OR DURING CONSTRUCTION WHEREAS, ADDENDUMS AND/OR CHANGES AFFECT ANY AREAS PERTINENT TO THE FOOD AND BEVERAGE	COMBINATION FAUCET OR PREMIXING FAUCET. PRE-MIXING FAUCETS MUST BE CAPABLE OF SUPPLYING WATER TEMPERED TO	DN DW	DOWN DIRECT WASTE	±8'-∩"			CONSULTANTS
PORTION OF THE PROJECT. 5 IF THERE ARE ANY AMBIGUITIES, DISCREPANCIES, OR	100 F TO 108 F AND BE SELF CLOSING OR METERED TO PROVIDE TO PROVIDE AT LEAST 15 SECOND OF WATER WITHOUT REACTIVATION.	DWG EA.	DRAWINGS EACH	+8'-0"	ELEVATION HEIGHT REFERENCE		\\\\\\\\\\\\\\\\\\\\\\\\\\\\\\\\\\\\\\
IRREGULARITIES, VERIFY WITH ARCHITECTURAL TEAM PRIOR TO COMMENCING WORK.	9 TOILET FACILITIES SHALL BE PROVIDED WITHIN EACH FOOD ESTABLISHMENT CONVENIENT FOR THE EMPLOYEES. 10 ALL TOILET ROOMS. JANITOR CLOSETS WITH JANITOR SINKS.	EH ELEC	EXHAUST ELECTRICAL EDEEZED				1530 S. Lewis St. Anaheim, CA 92805
6 ALL WORK IS TO BE COMPLETED IN CRAFTSMAN LIKE MANNER AND CONFORM TO ALL APPLICABLE BUILDING AND SAFETY CODES.	INDOOR TRASH ROOMS AND DRESSING/CHANGE ROOMS SHALL BE PROVIDED WITH MECHANICAL VENTILATION, LIGHTS AND SWITCHES	FD	FREEZER FLOOR DRAIN				P 714.508.1880 www.webbfsd.com
7 REFER TO ARCHITECTURAL PLANS FOR ADA CLEARANCE REQUIREMENTS FOR ALL SPACES, DOOR STRIKES, EXITS, AND AISLE WAYS AS THEY PERTAIN TO CODE ENFORCEMENT AND	CONSISTENT WITH MECHANICAL CODE REQUIREMENTS. 11 ALL DELIVERY DOORS LEADING TO THE OUTSIDE SHALL OPEN	FIN FLR FS	FINISH FLOOR FLOOR SINK				
INTERPRETATION. 8 CONTRACTORS SHALL SUBMIT ALL SHOP DRAWINGS, FINISHES,	OUTWARD, BE SELF-CLOSING, AND SHALL BE PROVIDED WITH AN OVERHEAD AIR CURTAIN. AIR CURTAIN SHALL BE TYPE NH2 NSF CERTIFIED RECEIVING DOOR MODELS.	FSEC FT	FOOD SERVICE EQUIPMENT CONTRACTOR FOOT				
STAINS, AND COLORS TO THE ARCHITECTURAL TEAM FOR APPROVAL PRIOR TO FABRICATION.	12 ALL EXTERIOR DOORS SHALL OPEN OUTWARD AND BE SELF-CLOSING AND TIGHT-FITTING. BI-FOLD, FRENCH, ACCORDIAON	GA GALV	GAUGE GALVANIZED				
9 SEE ENGINEERING DOCUMENTS FOR TITLE 24 ENGINEERING CALCULATIONS FOR BUILDING PERMIT REQUIREMENTS. 10 CONTRACTOR TO VERIFY ALL EQUIPMENT CLEARANCES THRU	STYLE AND ROLL-UP DOORS CANNOT OPEN INTO FOOD PREPARATION, UNPACKAGED FOOD SERVICE OR WAREWASHING AREA.	GC GL	GENERAL CONTRACTOR GLASS				
BUILDING DOORS, HALLWAYS, OR ENTRY POINTS. NOT ALL EQUIPMENT WILL FIT THRU STANDARD DOOR OPENINGS.	13 TOILET ROOM DOORS ARE TO BE SELF-CLOSING AND TIGHT-FITTING.	GPH GYP. BD.	GALLONS PER HOURS GYPSUM BOARD				
11 ALL DRAWINGS BY WEBB FOODSERVICE DESIGN ARE FOOD SERVICE EQUIPMENT CONTRACT DOCUMENTS ONLY TO BE USED BY	14 ALL PLUMBING, ELECTRICAL AND GAS LINES SHALL BE CONCEALED WITHIN THE BUILDING STRUCTURE TO AS GREAT AN EXTENT AS	HP HR	HORSEPOWER HOUR				
CONSULTANTS/ARCHITECTS AND FOR BIDDING, NOT FOR CONSTRUCTION. 12 VERIFY ALL DIMENSIONS AND CONDITIONS AT THE JOB SITE PRIOR TO	POSSIBLE. ALL EXPOSED CONDUIT, PLUBMING LINES, ETC. SHALL BE INSTALLED A MINIMUM OF 6" ABOVE THE FLOOR AND 3/4" FROM THE WALLS USING EASILY CLEANABLE STANDOFF BRACKETS.	HTR HW	HEATER HOT WATER				
PROCEEDING WITH WORK. 13 PARTITIONS ARE DIMENSIONED FROM FINISHED SURFACE, UNLESS	15 UTENSIL SINKS TO HAVE 3 COMPARTMENTS THAT ARE A MINIMUM SIZE OF 18" X 18" X 12" DEEP WITH A MINIMUM 18" DRAINBOARD AT	I.D. IN	INSIDE DIAMETER INCH				
OTHERWISE NOTED. 14 ALL HORIZONTAL DIMENSIONS ARE FROM FINISHED FACE OF WALL TO	EACH END AND 10" BACKSPLASH. IF THE END IS AGAINST A WALL, THE END MUST HAVE A 10" INTEGRAL SPLASH TO MATCH	INS INT	INSIDE INSULATION INTERIOR				
FINISHED FACE OF WALL OR CENTERLINE OF COLUMN. 15 ALL VERTICAL DIMENSIONS ARE FROM FINISHED FLOOR TO WALL OR	BACKSPLASH. THE SINK TUB MUST BE CAPABLE OF ACCOMMODATING THE LARGEST UTENSIL TO BE WASHED AND THE DRAINBOARD MUST BE EQUAL OR GREATER IN LENGTH THAN THE	IW JAN	INDIRECT WASTE JANITOR				
WALL OPENING. 16 PROVIDE SMOOTH AND LEVEL FLOORS BELOW ALL KITCHEN EQUIPMENT UNLESS THESE DRAWINGS SHOW OTHERWISE.	SINK TUB. 16 PREP SINK COMPARTMENTS MUST BE AT LEAST 18" X 18" X 12" DEEP	KIT KW	KITCHEN KILOWATT				
17 GENERAL CONTRACTOR TO PROVIDE AND INSTALL BLOCKING IN WALLS FOR MOUNTING WALL SHELVES, POT RACKS, DISPLAY CASES,	WITH A MINIMUM DRAINBOARD OF 18". 17 FAUCETS SHALL HAVE SPOUTS CAPABLE OF REACHING EACH SINK	L LOT	LENGTH LOT				
HOSE REELS, ETC., AS SHOWN ON PLANS. 18 WHERE REQUIRED, SPRINKLER HEADS IN WALK-IN FREEZER WILL BE	COMPARTMENT. 18 APPROVED BACKFLOW PREVENTION DEVICES SHALL BE PROPERLY INSTALLED UPSTREAM OF ANY POTENTIAL HAZARD BETWEEN THE	MAX MECH	MAXIMUM MECHANICAL				
PROVIDED BY AND PROTECTED AGAINST FREEZING BY GENERAL CONTRACTOR. 19 LEVEL PLATFORMS CONSTRUCTED PER CODE AND LOCATED ON	POTABLE WATER SUPPLY AND A SOURCE OF CONTAMINATION. HOSES SHALL NOT BE ATTACHED TO A FAUCET OR HOSE BIBB	MED MET	MEDIUM METAL				
ROOF ARE REQUIRED FOR COMPRESSOR RACKS. REFER TO ARCHITECTURAL AND MECHANICAL PLANS FOR LOCATIONS AND	UNLESS AN APPROVED BACKFLOW PREVENTER IS SUPPLIED. 19 IN EVERY ROOM AND AREA IN WHICH ANY FOOD IS PREPARED,	MFG MIN MISC	MANUFACTURER MINIMUM MISCELLANEOUS				
DETAILS. GENERAL CONTRACTOR TO PROVIDE ACCESS FOR DELIVERY AND INSTALLATION OF EACH COMPRESSOR RACK.	MANUFACTUERED, PROCESSED, OR PREPACKAGED OR IN WHICH EQUIPMENT OR UTENSILS ARE CLEANED, SUFFICIENT NATURAL OR ARTIFICIAL LIGHTING SHALL BE PROVIDED TO PRODUCE LIGHT	MOB MTD	MOBILE MOUNTED				
20 SEE STRUCTURAL ENGINEER AND/OR ARCHITECTURAL PLANS FOR STRUCTURAL SUPPORT REQUIREMENTS OF ROOF SUPPORTING ALL FOOD SERVICE EQUIPMENT SUCH AS COMPRESSOR RACKS.	INTENSITY, WHILE THE AREA IS IN USE:	N.I.C. NIFSEC	NOT IN CONTRACT NOT IN FOOD SERVICE EQUIPMENT CONTRACT				
EXHAUST AND MAKE-UP AIR SYSTEMS, AIR CONDITIONING, ETC., PRIOR TO BEGINNING CONSTRUCTION.	A) AT LEAST 10-FOOT CANDLES FOR THE FOLLOWING: 1) AT A DISTANCE OF 30 INCHES ABOVE THE FLOOR, IN WALK-IN REFRIGERATION UNITS AND DRY FOOD STORAGE	O.C. O.D.	ON CENTER OUTSIDE DIAMETER				
21 ROOF JACKS AND PENETRATIONS THROUGH ROOF ARE REQUIRED FOR REFRIGERATION LINES. SEE ARCHITECTURAL PLANS FOR DETAILS. (VERIFY LOCATION WITH REFRIGERATION CONTRACTOR)	UNITS. 2) AT A WORKING SURFACE ON WHICH ALCOHOLIC	OFCI OFOI	OWNER FURNISHED CONTRACTOR INSTALLED OWNER FURNISHED OWNER INSTALLED				SEAL
22 ARCHITECT AND/OR MECHANICAL ENGINEER TO PROVIDE ADEQUATE VENTILATION AND COOLING FOR SPACES CONTAINING	BEVERAGES ARE PREPARED OR WHERE UTENSILS USED IN THE PREPARATION OR SERVICE OF ALCOHOLIC BEVERAGES ARE CLEANED.	P.S.I. PLY	POUNDS PER SQUARE INCH PLYWOOD				
SELF-CONTAINED REFRIGERATION AND OTHER FOOD SERVICE EQUIPMENT EMITTING HEAT.	3) INSIDE EQUIPMENT SUCH AS REACH-IN OR UNDER THE COUNTER REFRIGERATORS. B) AT LEAST 20-FOOT CANDLES FOR THE FOLLOWING:	POB POF	PART OF BUILDING PART OF FIXTURE				
23 INTENDED ENVIRONMENT FOR REFRIGERATED GLASS FRONT & OPEN FRONT DISPLAY CASE, INCLUDING GLASS DOORS ON WALK-IN REFRIGERTORS AND FREEZERS IS 75°F/55% RELATIVE HUMIDITY.	AT A SURFACE WHERE FOOD IS PROVIDED FOR CONSUMER SELF-SERVICE OR WHERE FRESH PRODUCE OR	POL POT	POLISH, POLISHED PORTABLE				
VERIFY WITH MECHANICAL DRAWINGS. 24 FOOD SERVICE FACILITIES REQUIRE A DESIGNATED HOT WATER	PREPACKAGED FOODS ARE SOLD OR OFFERED FOR CONSUMPTION. 2) IN SERVER STATIONS WHERE FOOD IS PREPARED.	PR PT	PAIR PAINT				
SUPPLY FOR FOODHANDLING AREAS, WAREWASHING AREAS, JANITOR SINKS AND EMPLOYEE RESTROOMS. REFER TO MECHANICAL AND/OR PLUMBING DRAWINGS.	3) AT A DISTANCE OF 30 INCHES ABOVE THE FLOOR IN AREAS USED FOR HANDWASHING, WAREWASHING, EQUIPMENT	QTY R	QUANTITY REFRIGERATOR				
25 HOT WATER SUPPLY TO POT AND PREPARATION SINKS SHALL BE 120 DEGREES MINIMUM. HOT WATER SUPPLY TO ALL DISH MACHINES	AND UTENSIL STORAGE AND IN TOILET ROOMS. 4) IN ALL AREAS AND ROOMS DURING PERIODS OF CLEANING. C) AT LEAST 50-FOOT CANDLES AT A SURFACE WHERE A FOOD	REQ REQ'S RM	REQUIRED REQUIREMENTS ROOM				
SHALL BE 120 DEGREES MINIMUM. 26 ALL MATERIALS FOR FLOORS, WALLS, AND CEILINGS SHALL BE	EMPLOYEE IS WORKING WITH FOOD OR WORKING WITH UTENSILS OR EQUIPMENT SUCH AS KNIVES, SLICERS, GRINDERS	S/S SCH	STAINLESS STEEL SCHEDULE				
INSTALLED PER MANUFACTURER'S INSTRUCTIONS. 27 GENERAL CONTRACTOR SHALL ENSURE THAT ALL HARDWOOD	OR SAWS WHERE EMPLOYEE SAFETY IS A FACTOR. D) LIGHT FIXTURES SHALL BE OF SHATTERPROOF CONSTRUCTION OR SHALL BE PROTECTED WITH SHATTERPROOF SHEILDS AND	SECT SHT	SECTION SHEET			THIS PLAN IS A GENERAL ARRANGEMENT OF EQUIPMENT FOR THE	
PLYWOOD (HWPW), PARTICLE BOARD (PB), AND MEDIUM DENSITY FIBERBOARD (MDF) USED TO MAKE FINISHED GOODS, SUCH AS FURNITURE, CABINETS, COUNTERTOPS, SHELVING, FLOORING.	SHALL BE READILY CLEANABLE	SIM SOV	SIMILAR SHUT-OFF VALVE			CONVENIENCE OF CONTRACTORS AND IS MADE FROM AVAILABLE INFORMATION. WEBB FOODSERVICE DESIGN ASSUMES NO RESPONSIBILITY FOR THE ACCURACY OF SUCH MEASUREMENTS. FABRICATORS, CONTRACTORS, AND	907 SW Harvey Milk Street
MOLDING, ETC., SHALL COMPLY WITH THE CALIFORNIA AIR RESOURCES BOARD (CARB) AIRBORNE TOXIC CONTROL MEASURE	20 COMPLY WITH CAMPUS STANDARDS TO LIMIT WASTE AND DIVERT IT FROM LANDFILL. MAXIMIZE RECYCLING/RECOVERY OF DEMOLITION OR CONSTRUCTION WASTE.	SQ STD	SQUARE STANDARD			OTHERS UTILIZING THESE PLANS IN CONNECTION WITH THIS JOB ARE RESPONSIBLE FOR SECURING THEIR OWN MEASUREMENTS. PLUMBING AND ELECTRICAL INFORMATION INDICATED ON THESE PLANS ARE GENERALLY FOR	Portland, OR 97205, USA tel 503 226 6950 fax 503 273 9192 ibigroup-edpnw.com
(ATCM) TO REDUCE FORMALDEHYDE EMISSIONS IN COMPOSITE WOOD PRODUCTS. THE ATCM APPLIES TO PANEL MANUFACTURERS, THIRD PARTY CERTIFIERS, DISTRIBUTORS, IMPORTERS,		STRUCT THK	STRUCTURAL THICK			FOOD SERVICE EQUIPMENT AND ARE INTENDED AS REFERENCE ONLY. WEBB DESIGN IS NOT RESPONSIBLE FOR THE ENGINEERING THEREOF OR FOR ANY	PROJECT
FABRICATORS, AND RETAILERS OF HWPW, PB, MDF, AND FINISHED GOODS CONTAINING THESE PRODUCTS (INCLUDING LAMINATED		TYP W	TYPICAL WIDE, WIDTH, WASTE			PLUMBING OR ELECTRICAL FITTINGS, WORK, AND OR CONNECTIONS UNLESS SPECIFICALLY PROVIDED FOR IN THE SPECIFICATIONS. WEBB FOODSERVICE DESIGN ASSUMES NO RESPONSIBILITY FOR THE WORK DONE BY THE	SOUTHRIDGE HS FREEZER REPLACEMENT
PRODUCTS), SOLD OR DELIVERED TO CALIFORNIA, AND APPLIES TO DOMESTIC AND IMPORTED PRODUCTS.		W/ WD	WITH WOOD			CONTRACTORS NOR FOR ANY CHANGES MADE NECESSARY BY THE LOCAL BUILDING CODES, ORDINANCES, STRUCTURAL CONDITIONS, OR BY THE SUBSTITUTION OR CHANGES MADE NECESSARY IN EQUIPMENT SHOWN ON THIS	9625 SW 125TH AVENUE BEAVERTON, OR 97008
28 COUNTERS ARE TO BE FABRICATED PROPERLY TO SUPPORT THE SPECIFIED COUNTER TOP MATERIAL IN ACCORDANCE WITH THE MATERIAL MANUFACTURER'S GUIDELINES.						PLAN. CONTRACTORS ARE TO MAKE ALLOWANCES FOR ELBOWS, TRAPS, ETC. AND ARE TO MAKE FINAL CONNECTIONS ON THE JOB, SUPPLYING ALL	PROJECT NO: XXXXXX
29 ALL "DROP-IN" EQUIPMENT AND OTHER EQUIPMENT "ATTACHED TO", "SET ON", OR "BUILT-IN" TO THE COUNTERTOP MATERIAL IS TO BE						NECESSARY VALVES, TRAPS, STEAM TRAPS, FAUCETS, STARTING SWITCHES FOR MOTORS, ETC. EXCEPT WHERE SPECIFICALLY NOTES OTHERWISE IN THE WRITTEN SPECIFICATIONS. THESE PLANS AND DESIGNS CONTAINED HERIN ARE	DRAWN BY: CHECKED BY: XX
INSTALLED IN ACCORDANCE WITH THE MATERIAL MANUFACTURER'S GUIDELINES AND TECHNICAL BULLETINS FOR THE INSTALLATION OF COMMERCIAL FOOD SERVICE EQUIPMENT.						THE PROPERTY OF WEBB FOODSERVICE DESIGN AND MAY NOT BE REPRODUCED OR USED BY ANYONE, EITHER ALL OR IN PART WITHOUT FIRST	PROJECT MGR: APPROVED BY: XX
OCIVIIVILINOIAL I OOD SERVICE EQUIFIVIENT.						SECURING THE WRITTEN PERMISSION OF WEBB FOODSERVICE DESIGN.	FOODSERVICE
							SYMBOLS, NOTES & INDEX
	l de la companya de		!				
						True North Project	SHEET NUMBER ISSUE

EQUIPMENT SCHEDULE					PLUMBING			ELECT	RICAL		
ITEM# QTY	. DESCRIPTION	MANUFACTURER	MODEL #	I.W.	PLUMBING REMARKS	VOLTS	K.W. AMPS	H.P. PHASE	ELEC. CONN.	ELECTRICAL REMARKS	GENERAL REMARKS
1 1	WALK-IN COOLER/FREEZER (REMOTE)	IMPERIAL BROWN	CUSTOM			120	10.0	1	D	WIRE THRU LIGHTS, SWITCH AND FREEZER DRAIN LINE HEATER	
2 1	EVAPORATOR COIL (COOLER)	RDT	BEL0155	F.S.	DRAIN TO EXISTING FLOOR SINK	*	*	*	D	SEE SHT. X FOR ELEC. REQMTS.	SEE SHT. X FOR ADDITIONAL INFO
3 1	EVAPORATOR COIL (FREEZER)	RDT	BEL0130	F.S.	DRAIN TO EXISTING FLOOR SINK	*	*	*	D	SEE SHT. X FOR ELEC. REQMTS.	SEE SHT. X FOR ADDITIONAL INFO
4 3	FREEZER SHELVING	CAMBRO	CAMSHELVING								
5 4	DUNNAGE RACK	METRO	HP55C								
6 1	REMOTE REFRIGERATION RACK (OUTDOOR, AIR-COOLED)	RDT	ZS2-02Z-CT3-AST			208-230	28.8	3	D	SEE SHT. X FOR ELEC. REQMTS.	SEE SHT. X FOR ADDITIONAL INFO

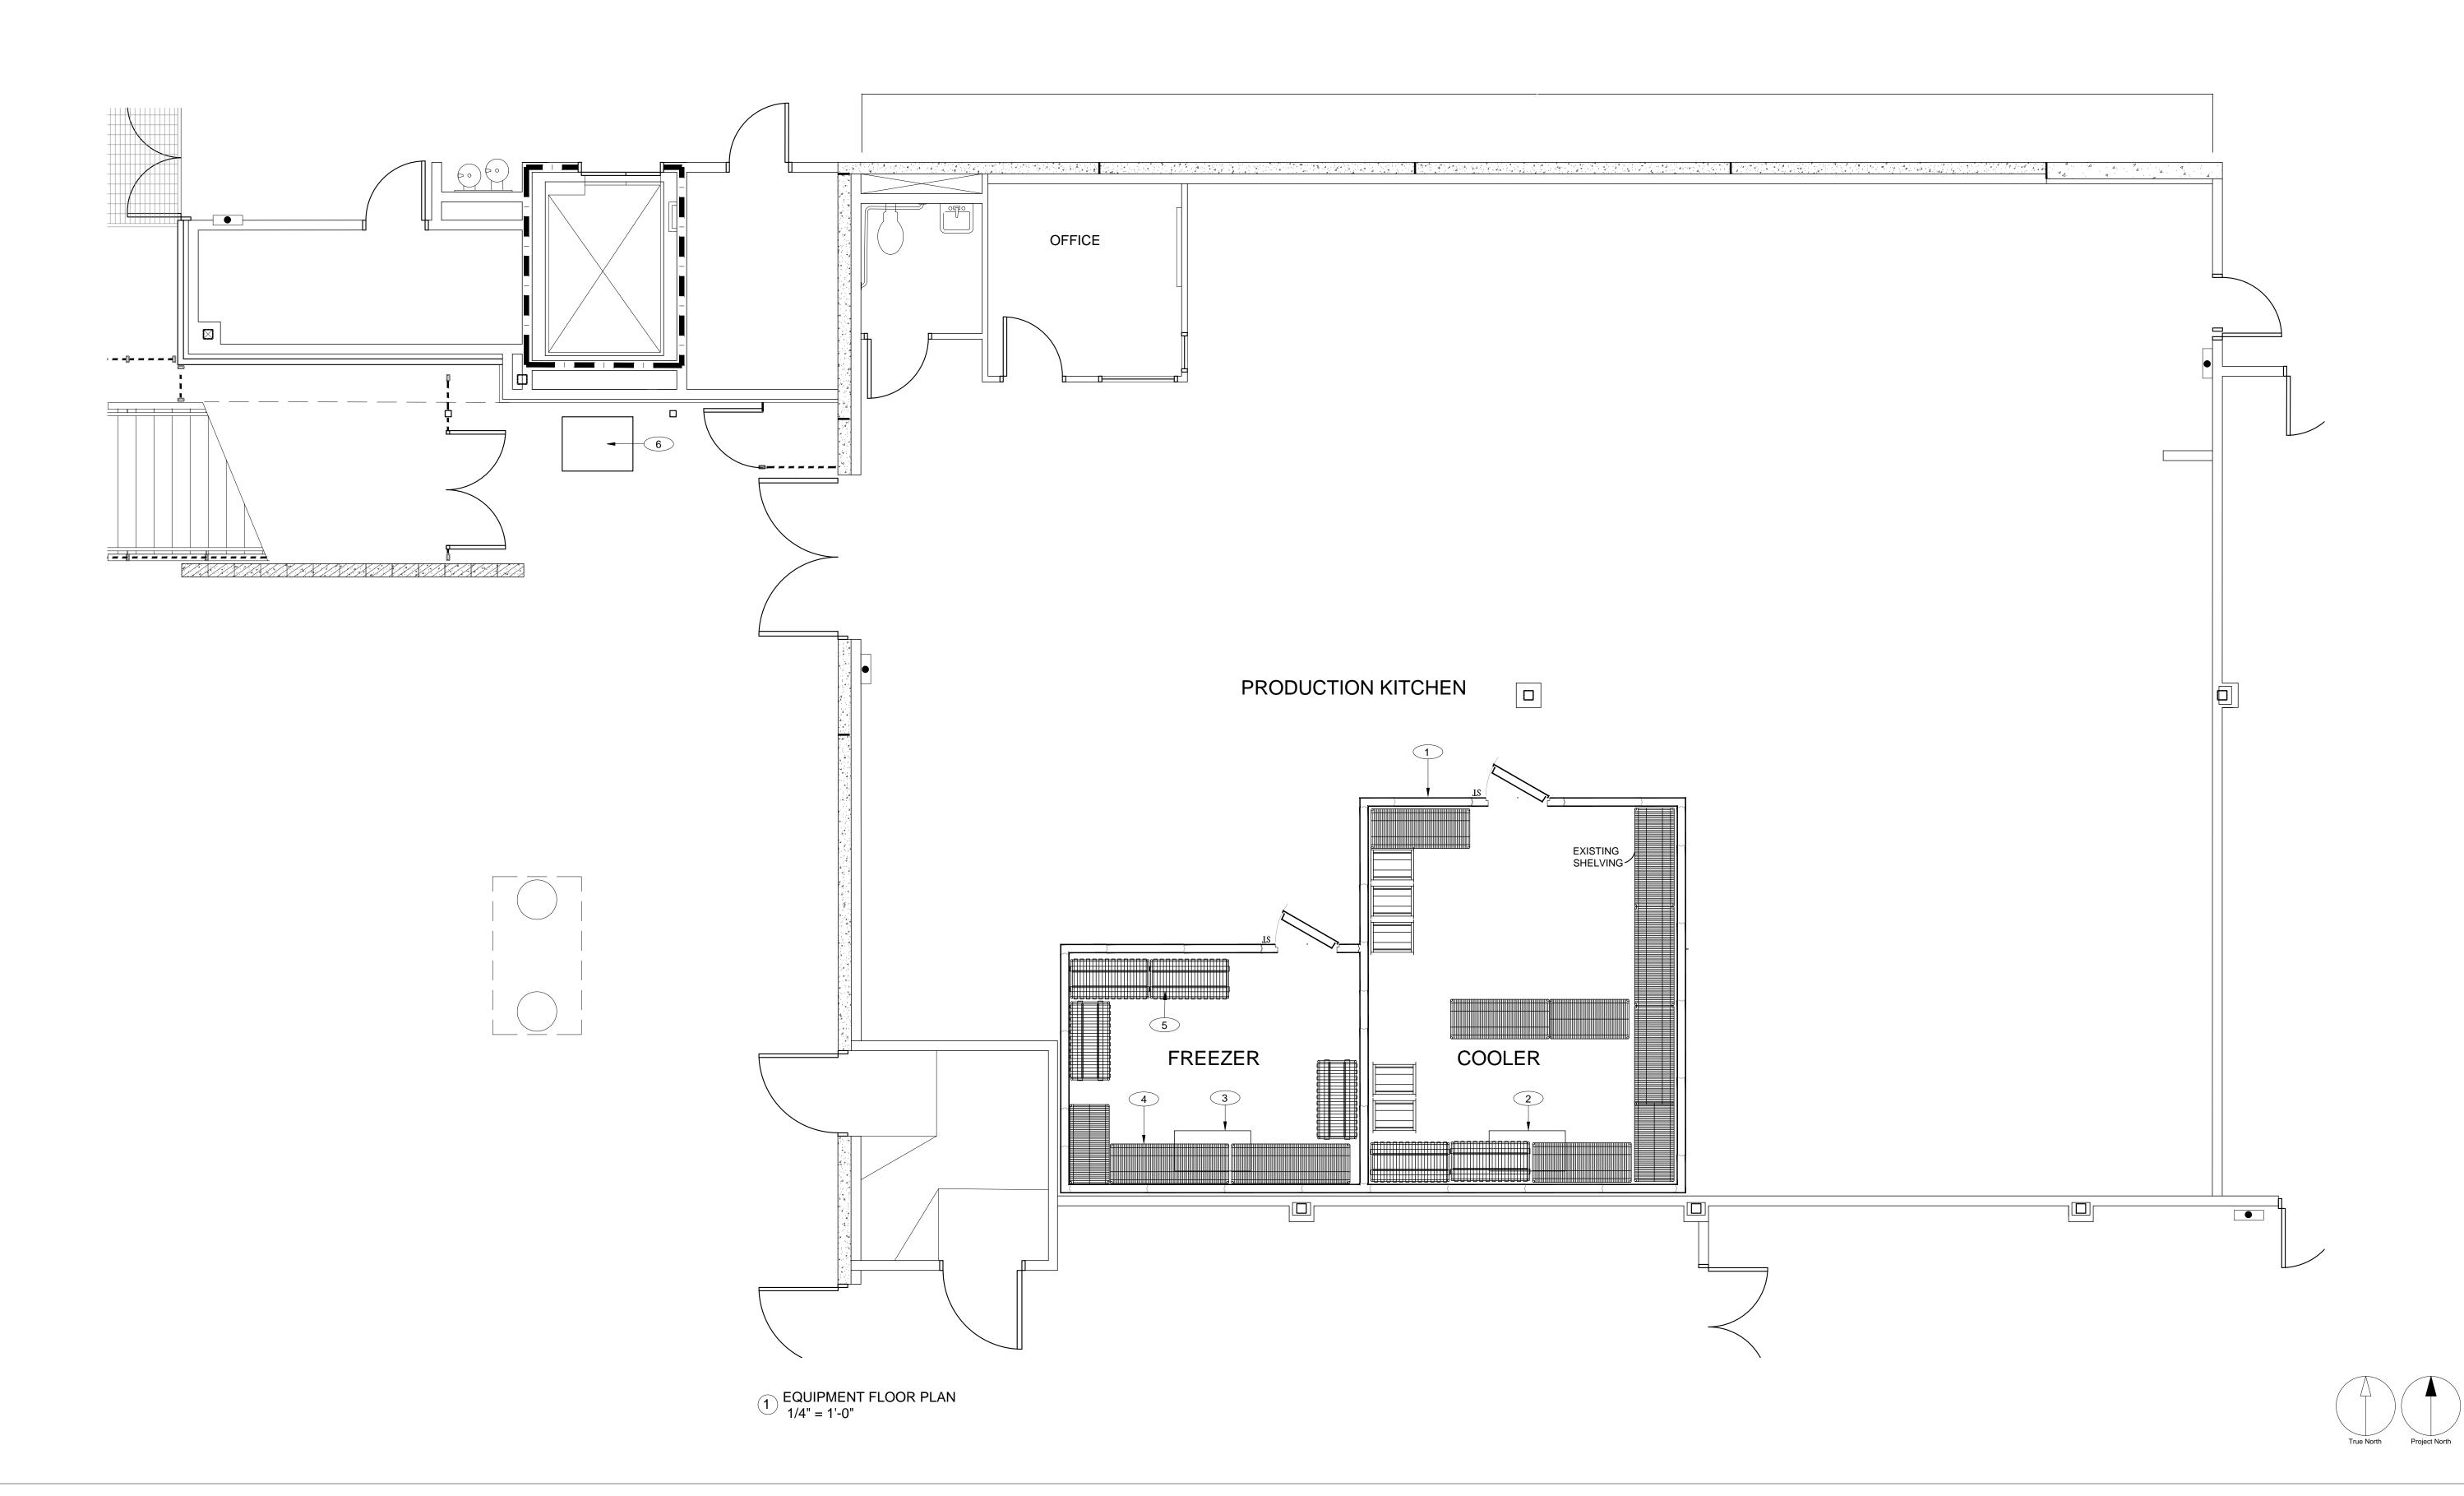

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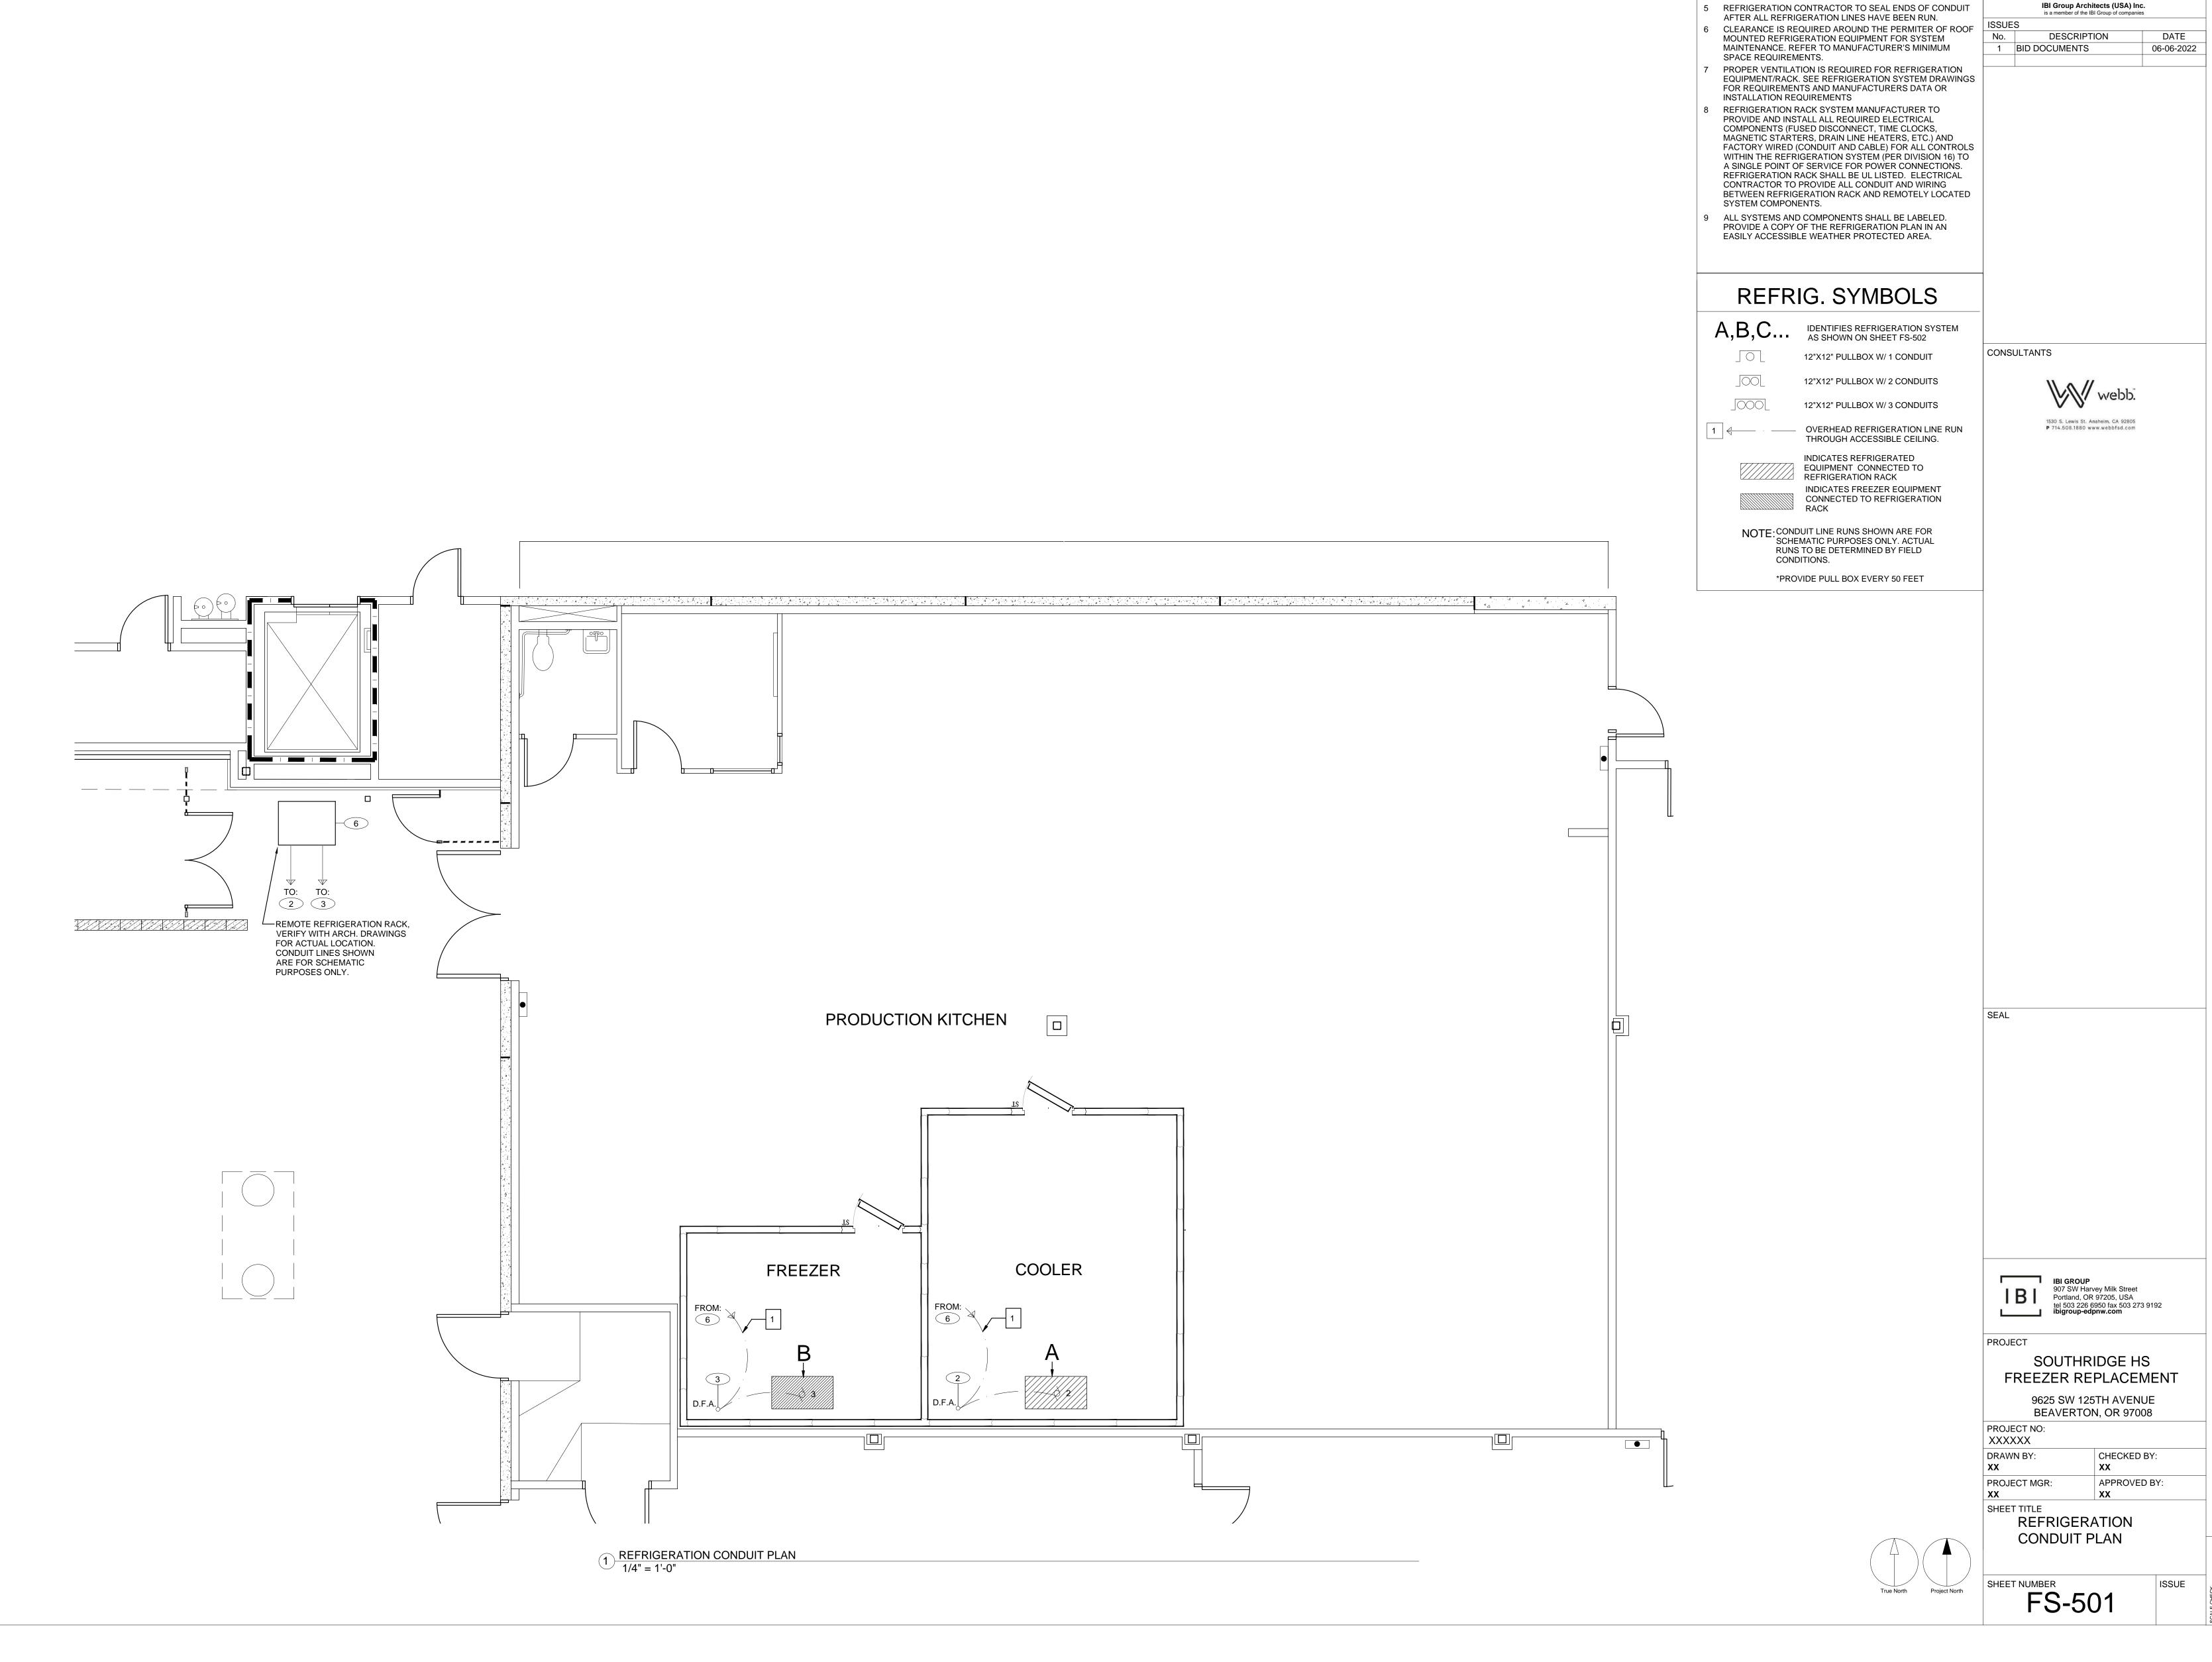
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PROJECT NO: XXXXXX DRAWN BY: CHECKED BY: PROJECT MGR: APPROVED BY:

SHEET TITLE
FOODSERVICE
EQUIPMENT PLAN

FS-101



REFRIGERATION NOTES Beaverton School District

REFRIGERATION CONTRACTOR SHALL INSULATE ALL REFRIGERATION LINES WHERE REQUIRED BY CODE.
 REFRIGERATION CONTRACTOR SHALL VERIFY LOCATION OF ALL REMOTE REFRGERATION SYSTEM COMPONENTS, INCLUDING EVAPORATOR COILS, REFRIGERATION RACK, COMPRESSORS, CONDENSORS, ETC.
 REFRIGERATION CONTRACTOR SHALL VERIFY LOCATION OF REFRIGERATION.

REFRIGERATION CONTRACTOR SHALL VERIFY LOCATION OF PITCH POCKET FOR REFRIGERATION LINE PENETRATION THRU ROOF WITH GENERAL CONTRACTOR. GENERAL CONTRACTOR TO INSTALL PITCH POCKETS, CURB, CAP AND FLASHING.

FLASHING.


4 GENERAL CONTRACTOR TO PROVIDE A WATERPROOF SEAL OF ALL PENETRATIONS THROUGH THE ROOF AFTER REFRIGERATION LINES HAVE BEEN RUN.

5 REFRIGERATION CONTRACTOR TO SEAL ENDS OF CONDUIT

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True North Project North

Beaverton School District

BEAVERTON
SCHOOL DISTRICT
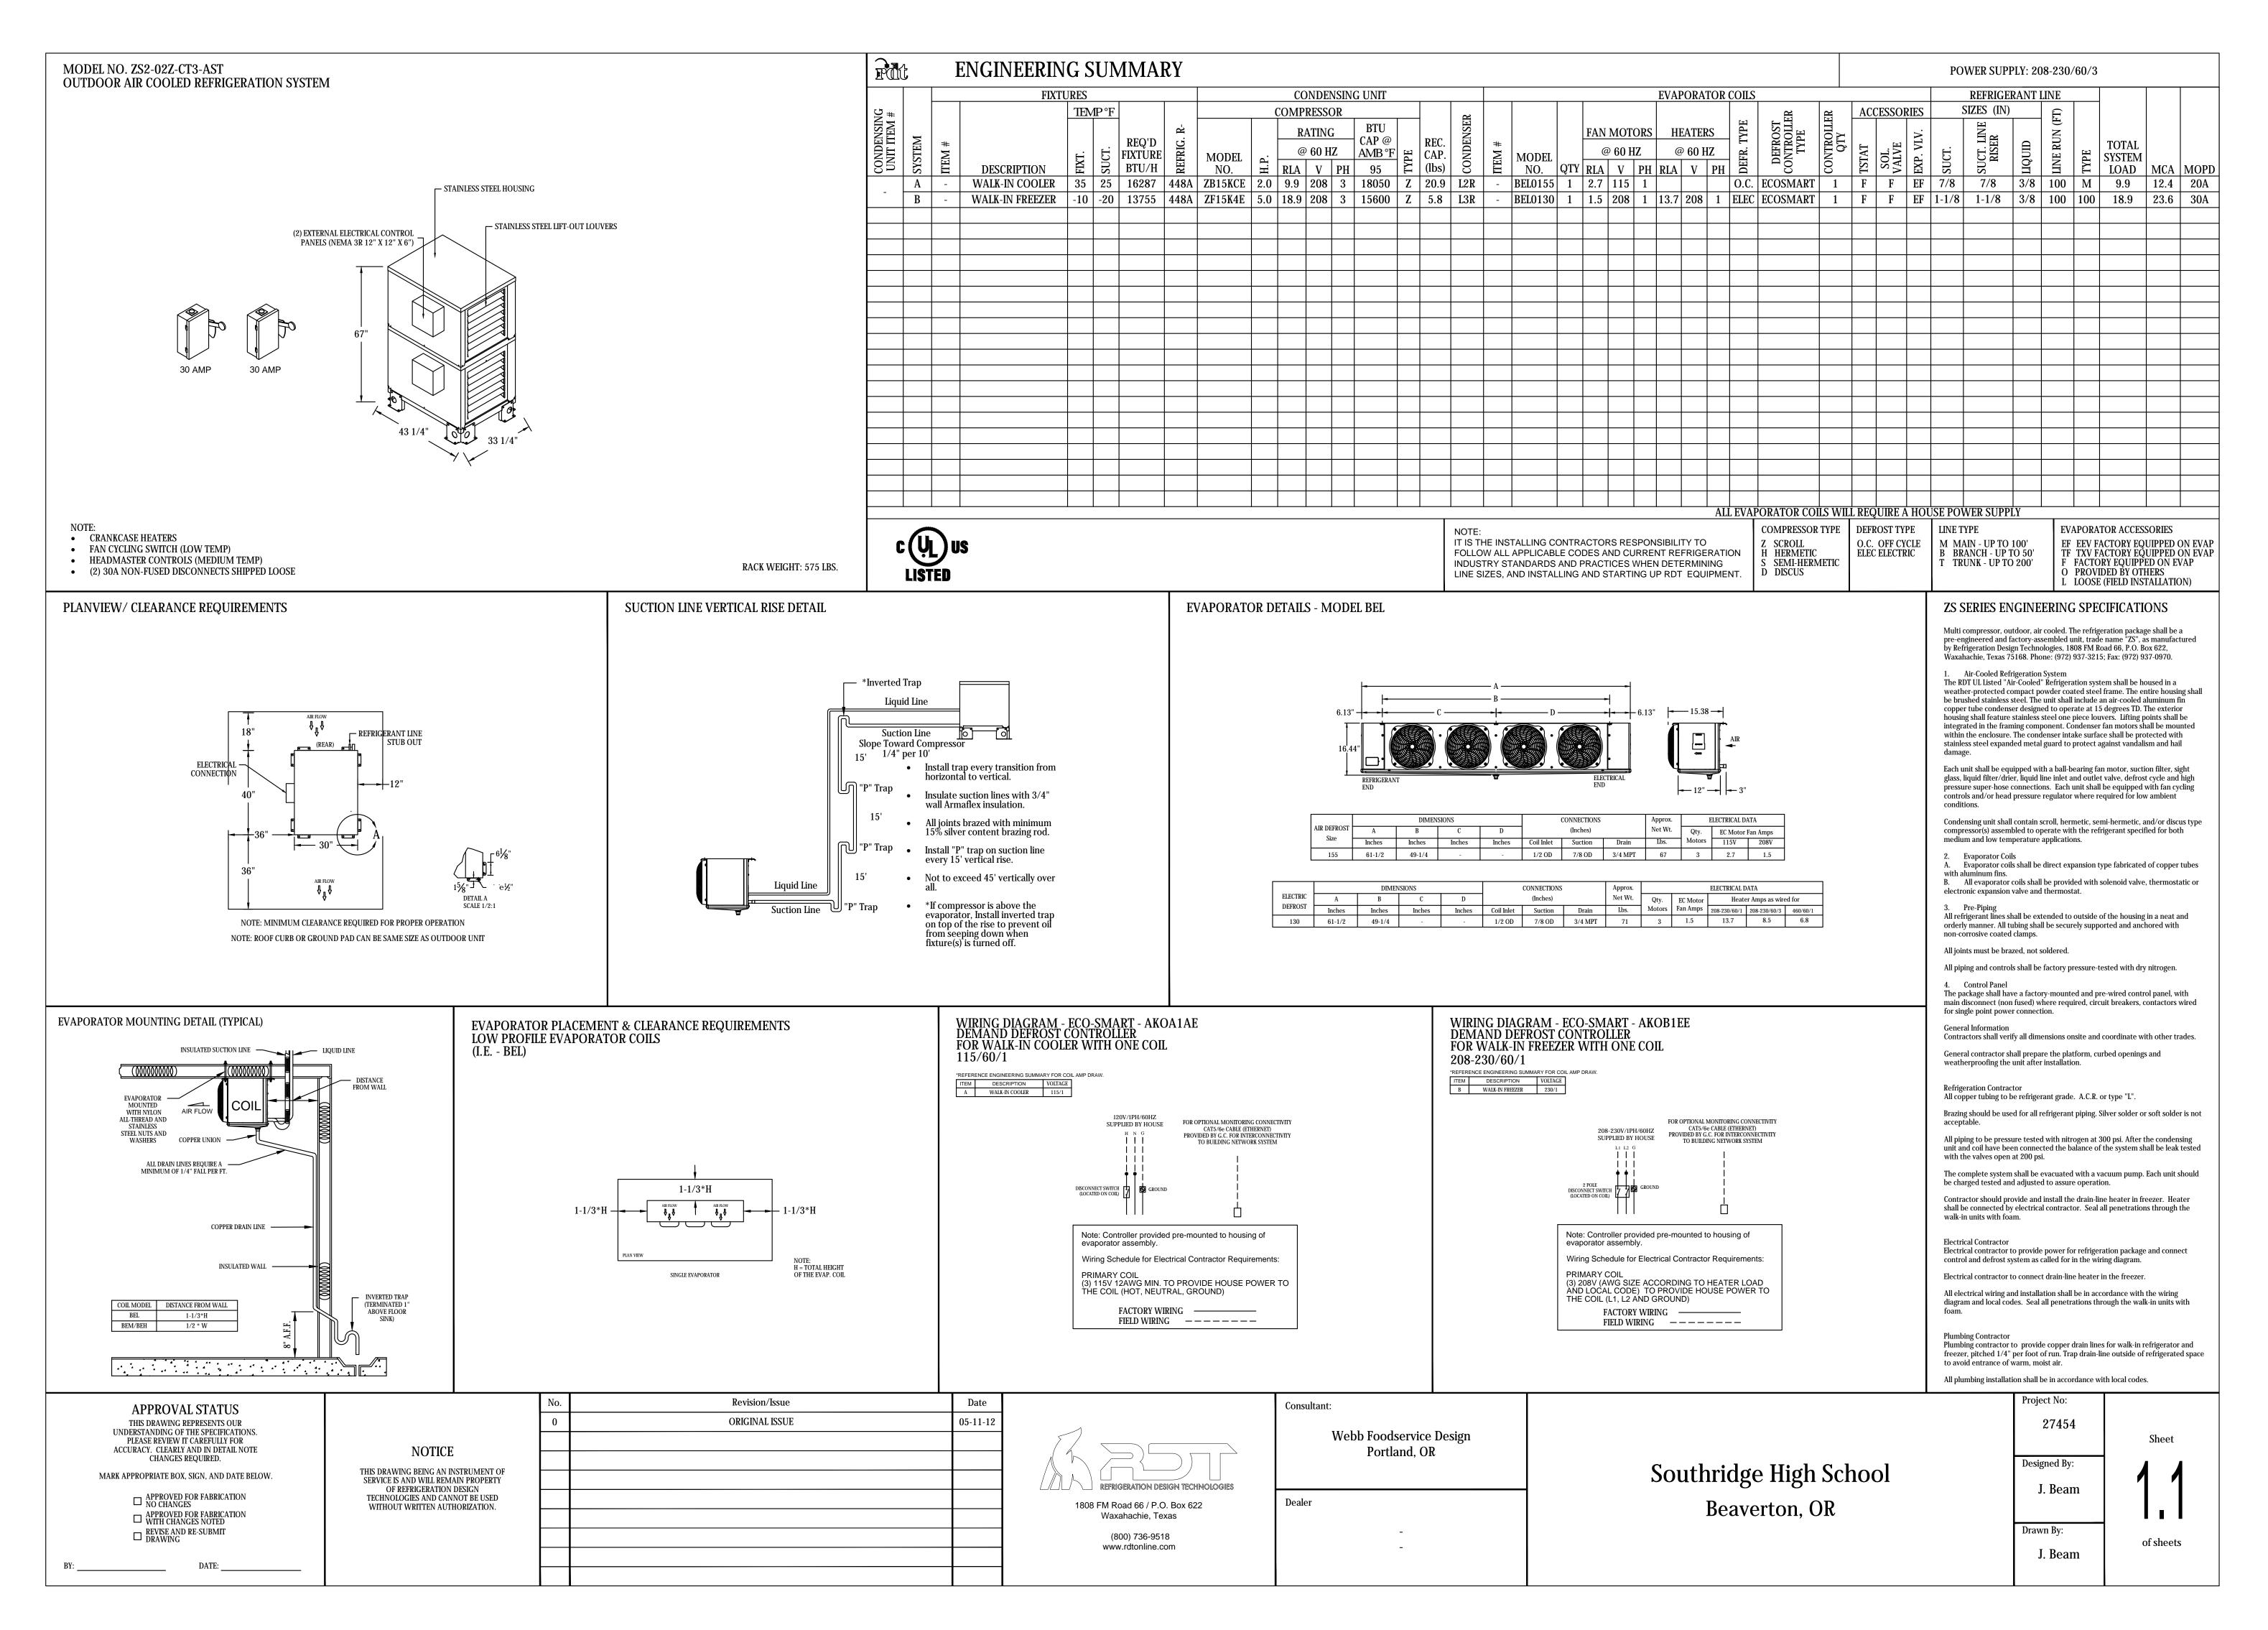
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PROJECT

SOUTHRIDGE HS FREEZER REPLACEMENT 9625 SW 125TH AVENUE BEAVERTON, OR 97008

PROJECT NO:
XXXXXX

DRAWN BY:
XX

PROJECT MGR:
XX

SHEET TITLE


CHECKED BY:
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XX

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REFRIGERATION DETAILS

FS-502



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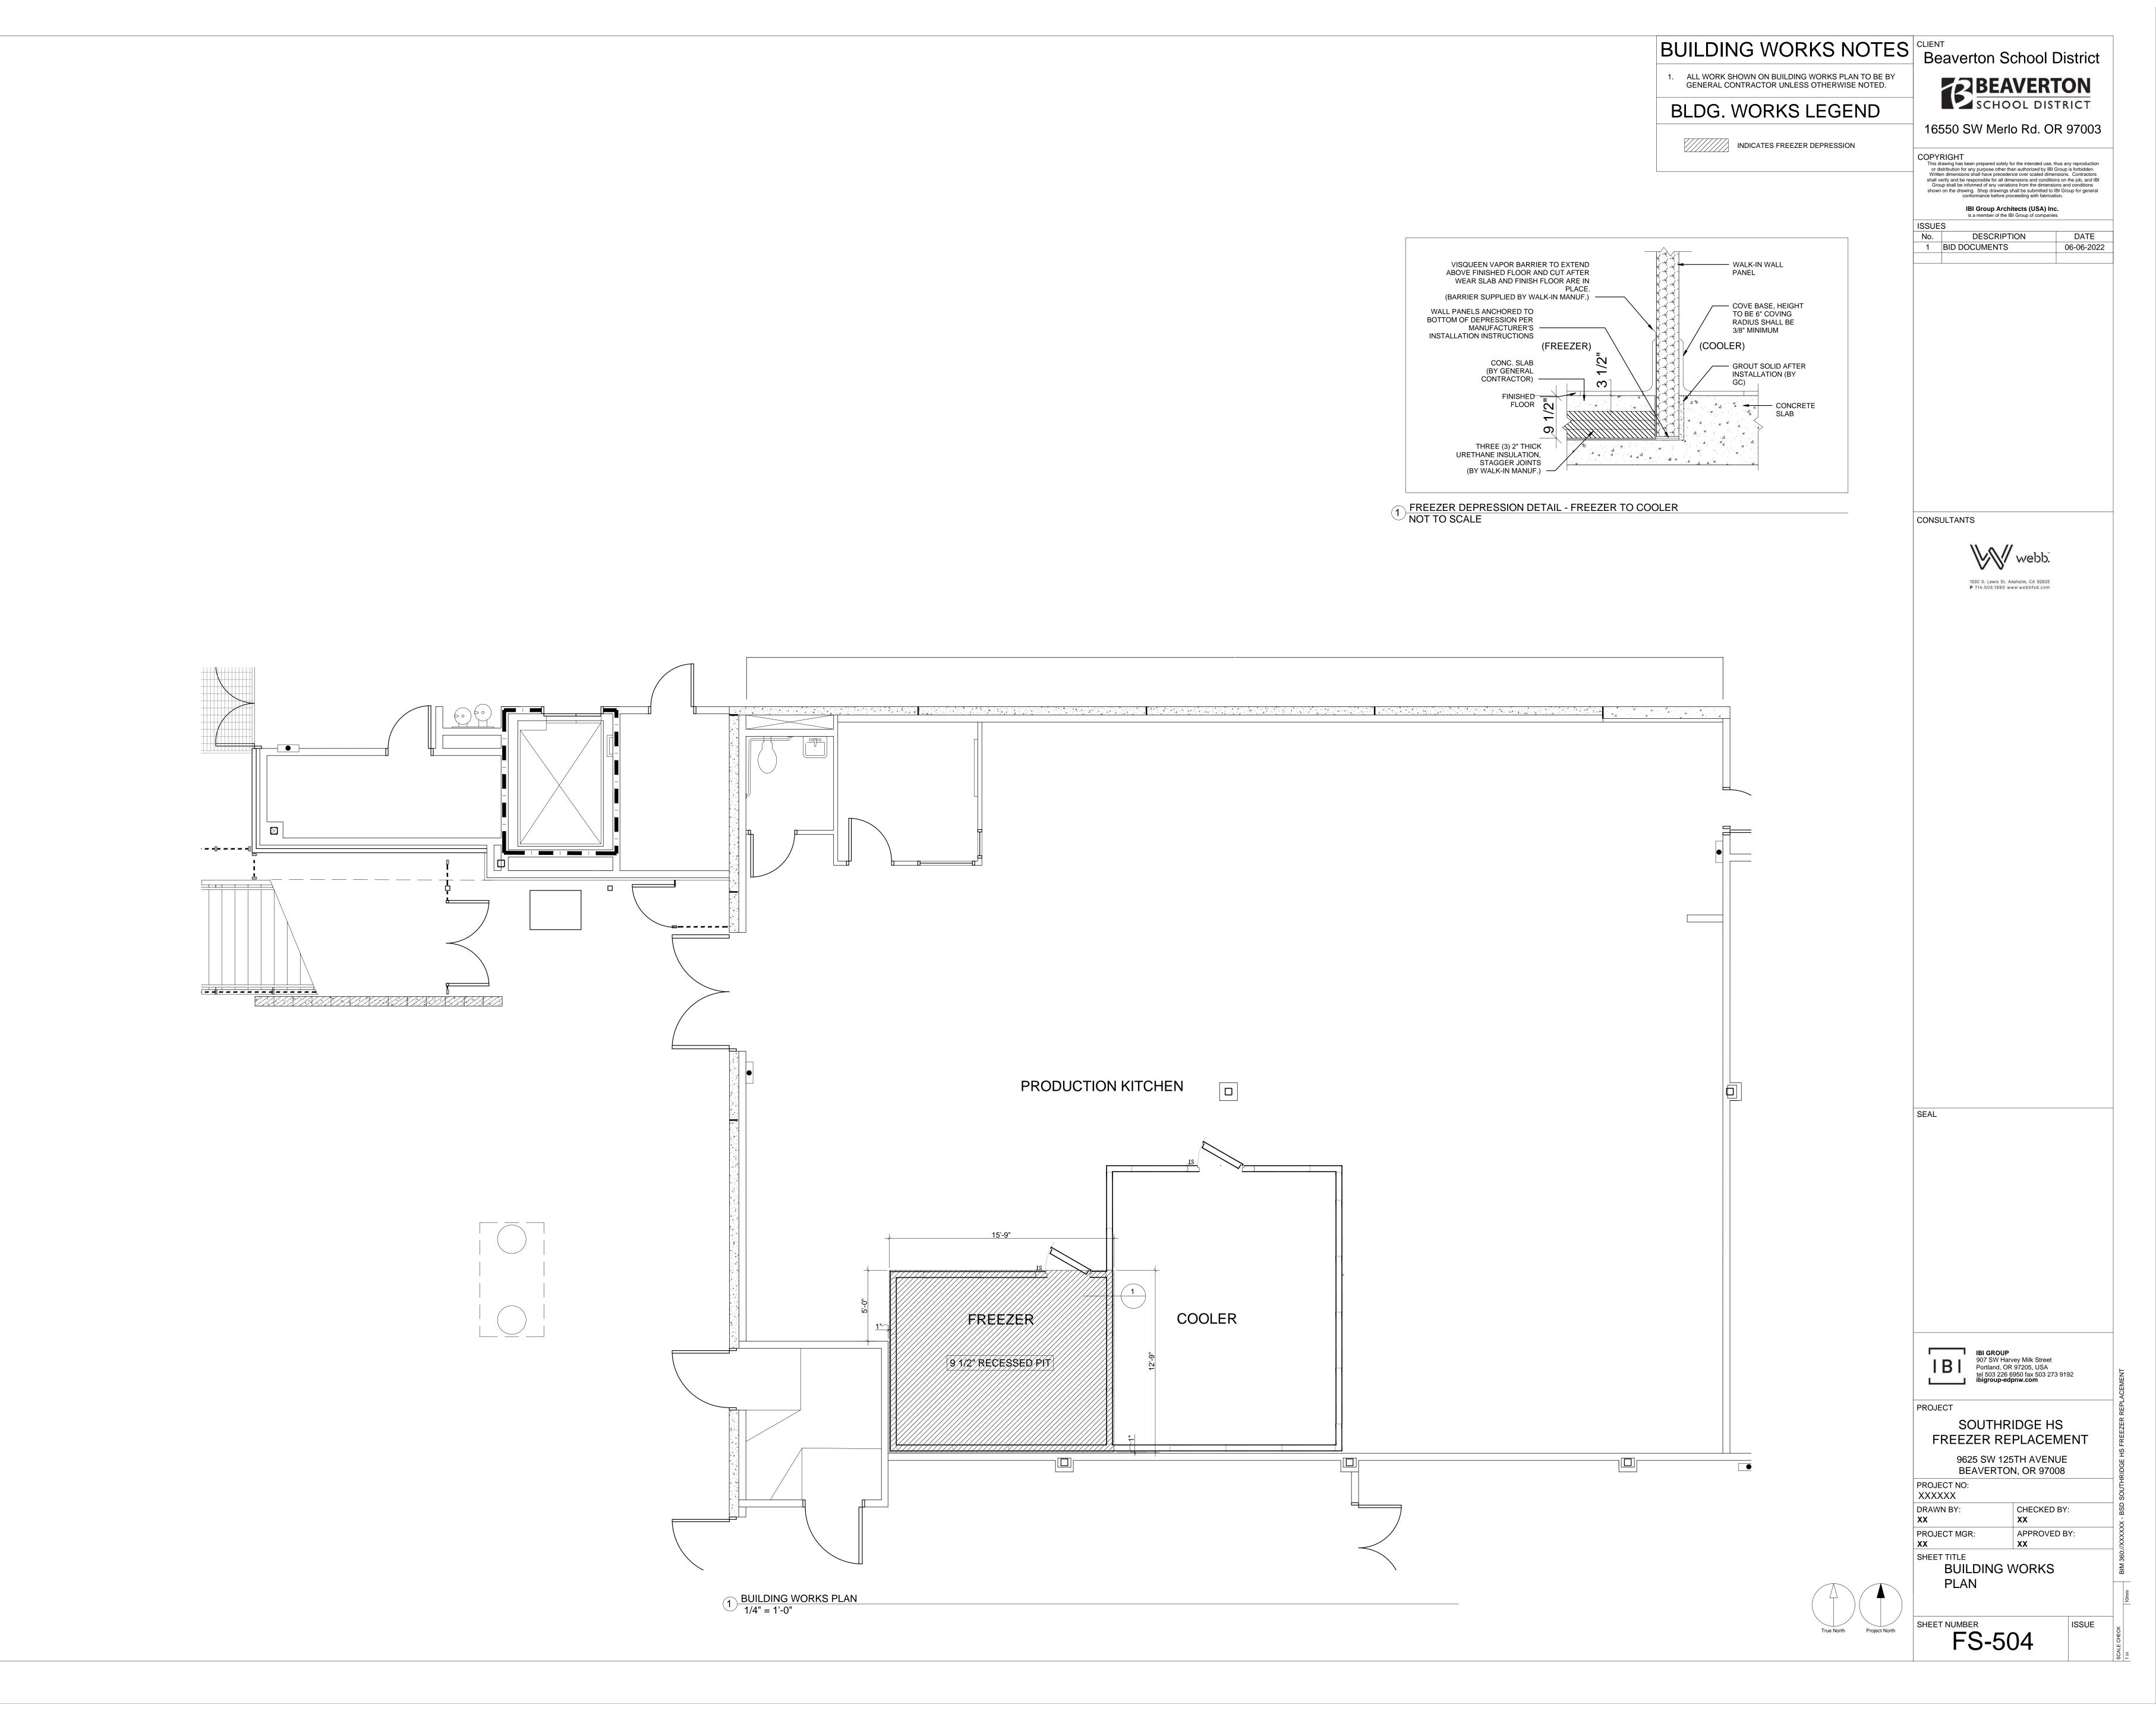
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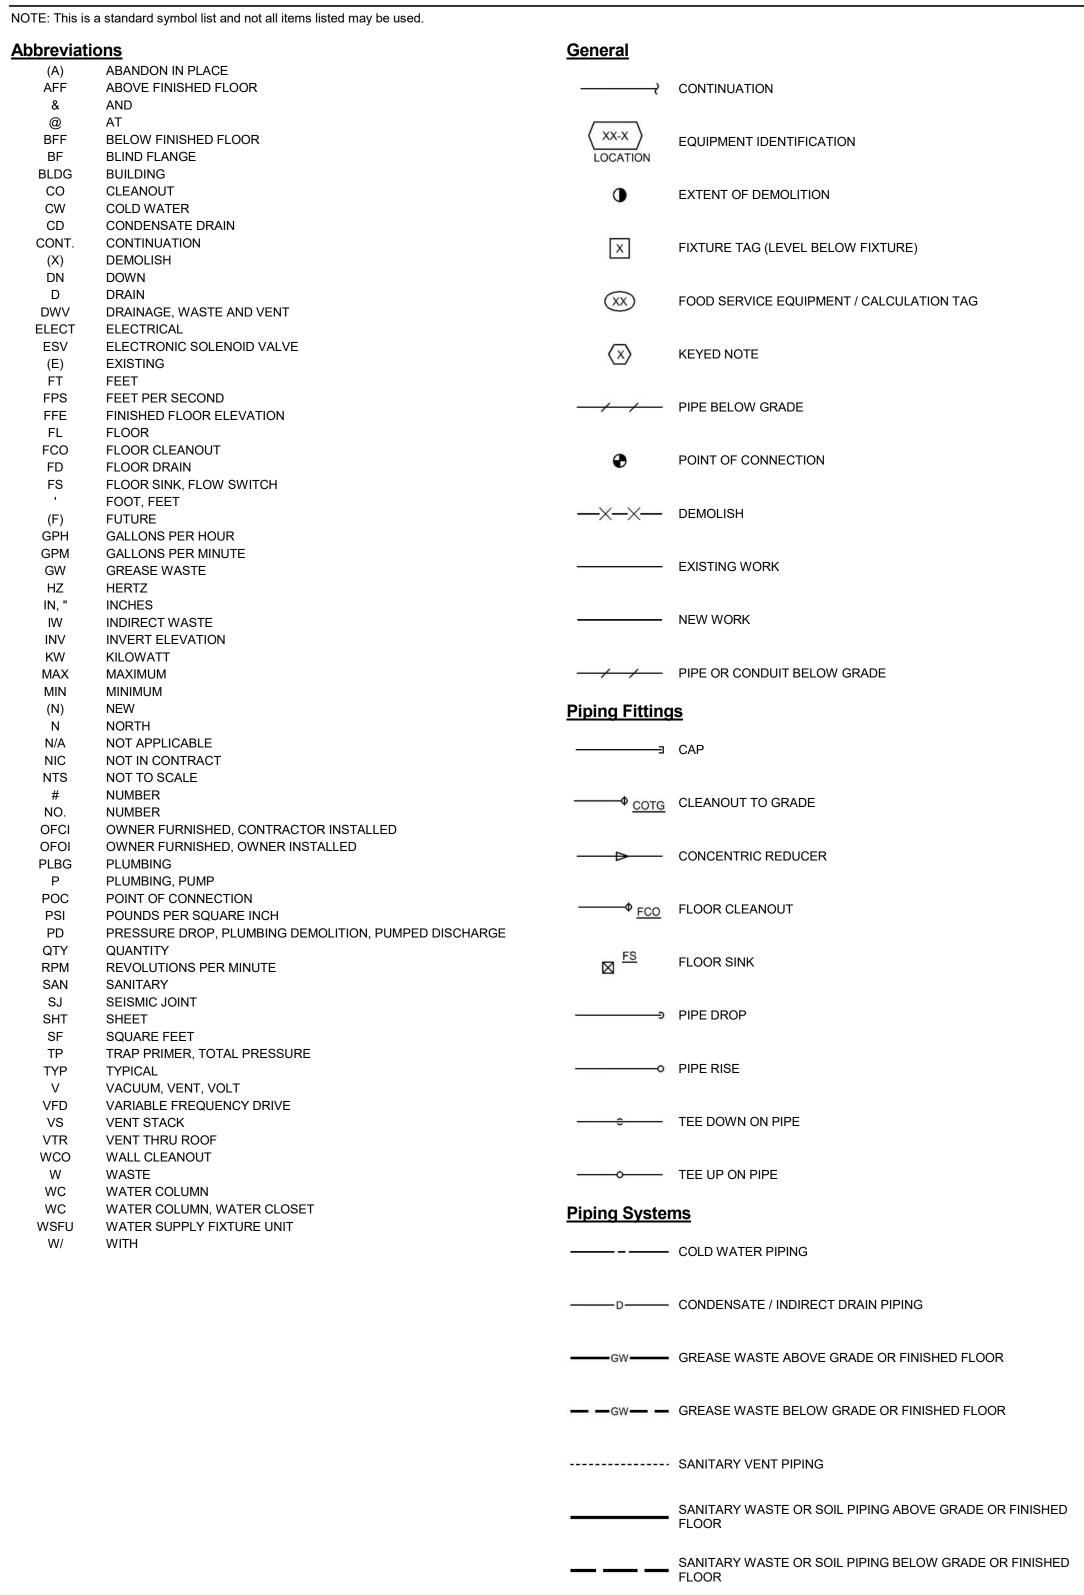
1 BID DOCUMENTS 06-06-2022

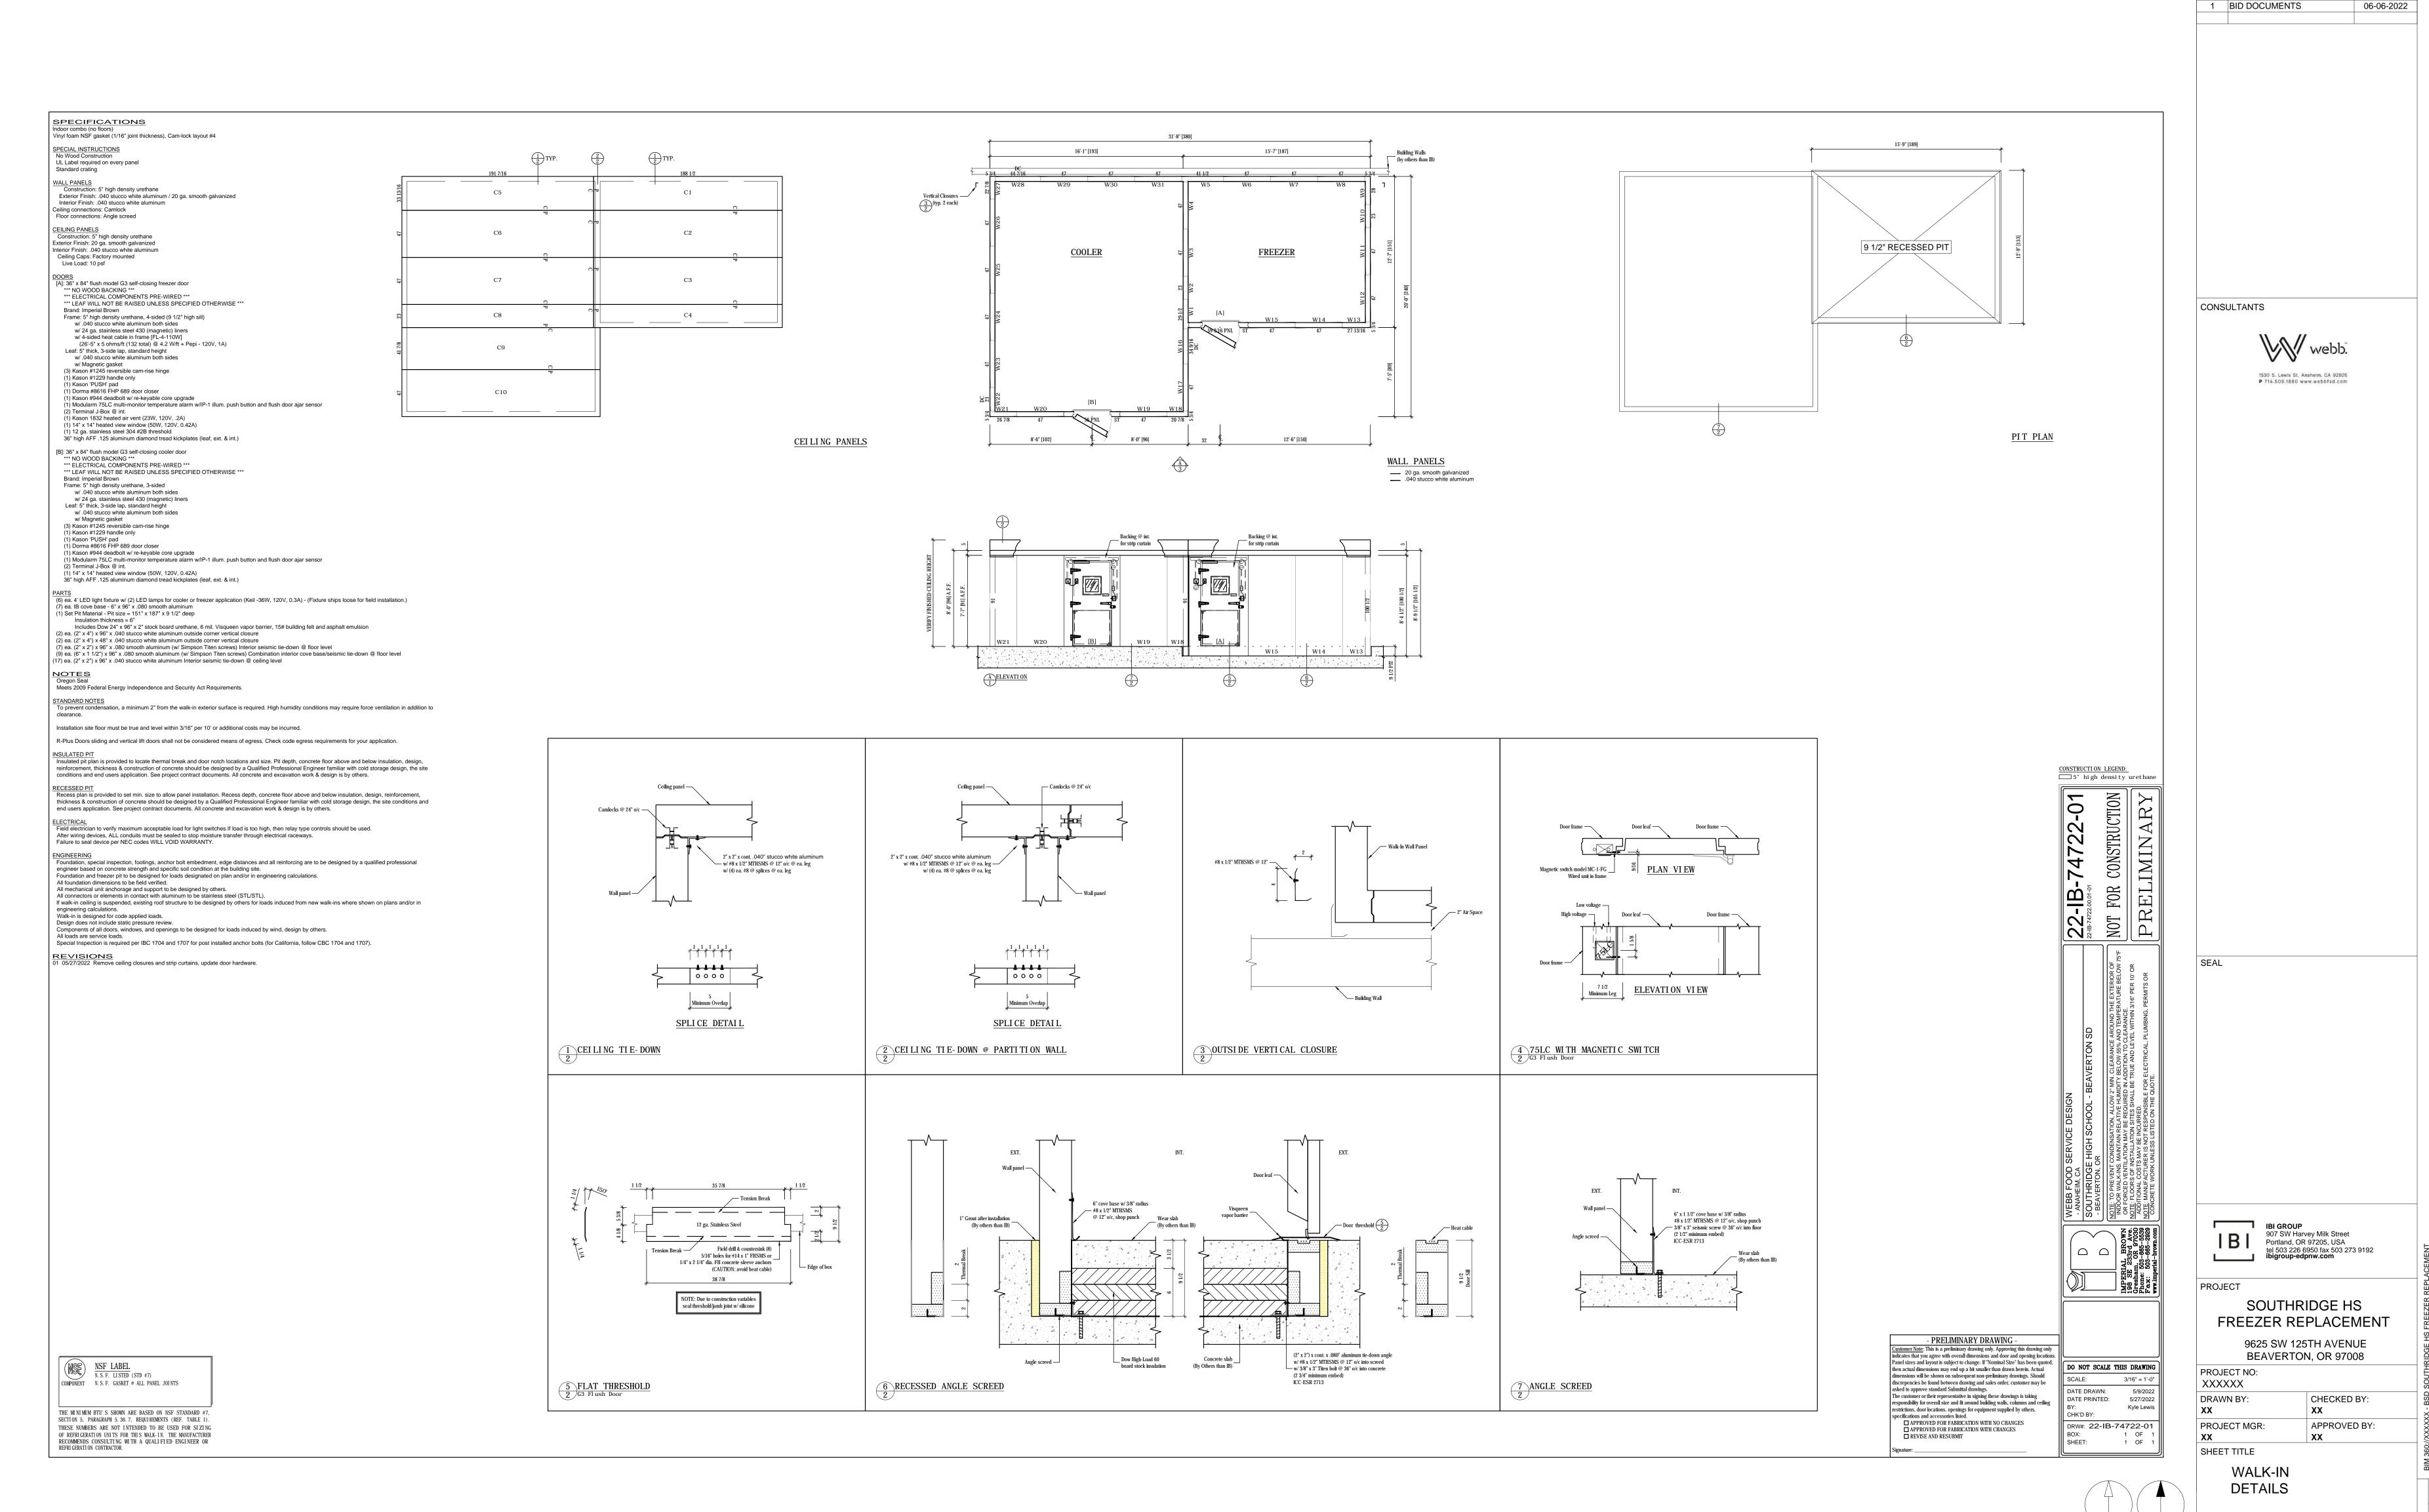SHEET NUMBER FS-503

ISSUE



PLUMBING SYMBOL LIST



GENERAL PLUMBING NOTES

- A. ALL WORK UNDER THIS CONTRACT SHALL CONFORM TO THE CURRENT STATE, COUNTY AND NATIONAL CODES AND STANDARDS ADOPTED BY THE LOCAL JURISDICTIONS INCLUDING APPLICABLE AMENDMENTS.
- B. CONDITIONS SHOWN ON THE PLANS RELATIVE TO THE WORK TO BE PERFORMED ARE BASED ON THE BEST INFORMATION AVAILABLE AND SUBJECT TO VERIFICATION. VERIFY LOCATIONS AND ELEVATIONS OF UTILITIES TO BE CROSSED OR CONNECTED. CORRECT DEFICIENCIES CAUSED BY FAILURE TO PERFORM SUCH VERIFICATIONS AT NO EXPENSE TO THE OWNER. IMMEDIATELY NOTIFY ARCHITECT AND ENGINEER OF THE CONDITION IN CONFLICT WITH THE
- C. COORDINATE FIXTURES, EQUIPMENT, PIPE ROUGH-IN/CONNECTIONS LOCATION AND DRAIN LOCATIONS WITH FREEZER / COOLER MANUFACTURER.
- D. INSTALL ALL CONDENSATE PIPING AT A MINIMUM SLOPE OF 1/4" PER FOOT.

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PROJECT 2022-0525
CONTACT TODD KOLIBABA
100 SW Main Street, Suite 1600
Portland, OR 97204
TEL 503.382.2266
www.interfaceengineering.com

SHEET INDEX

P0.1 SYMBOL LIST AND GENERAL NOTES - PLUMBING

PD2.1 DEMO FLOOR PLAN - PLUMBING

P2.1 FLOOR PLAN - PLUMBING

SEAL

SEAL

SEAL

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EXPIRES: 12/31/22

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tel 503 226 6950 fax 503 273 9192
ibigroup-edpnw.com

PROJECT
BSD Southridge HS Freezer
Replacement
16550 SW Merlo Rd. OR 97003

PROJECT NO:
Project Number

DRAWN BY:
TK

PROJECT MGR:

CHECKED BY:
JMM


PROJECT MGR:

APPROVED BY:

SHEET TITLE
SYMBOL LIST AND GENERAL
NOTES - PLUMBING

SHEET NUMBER PO.1

| 1

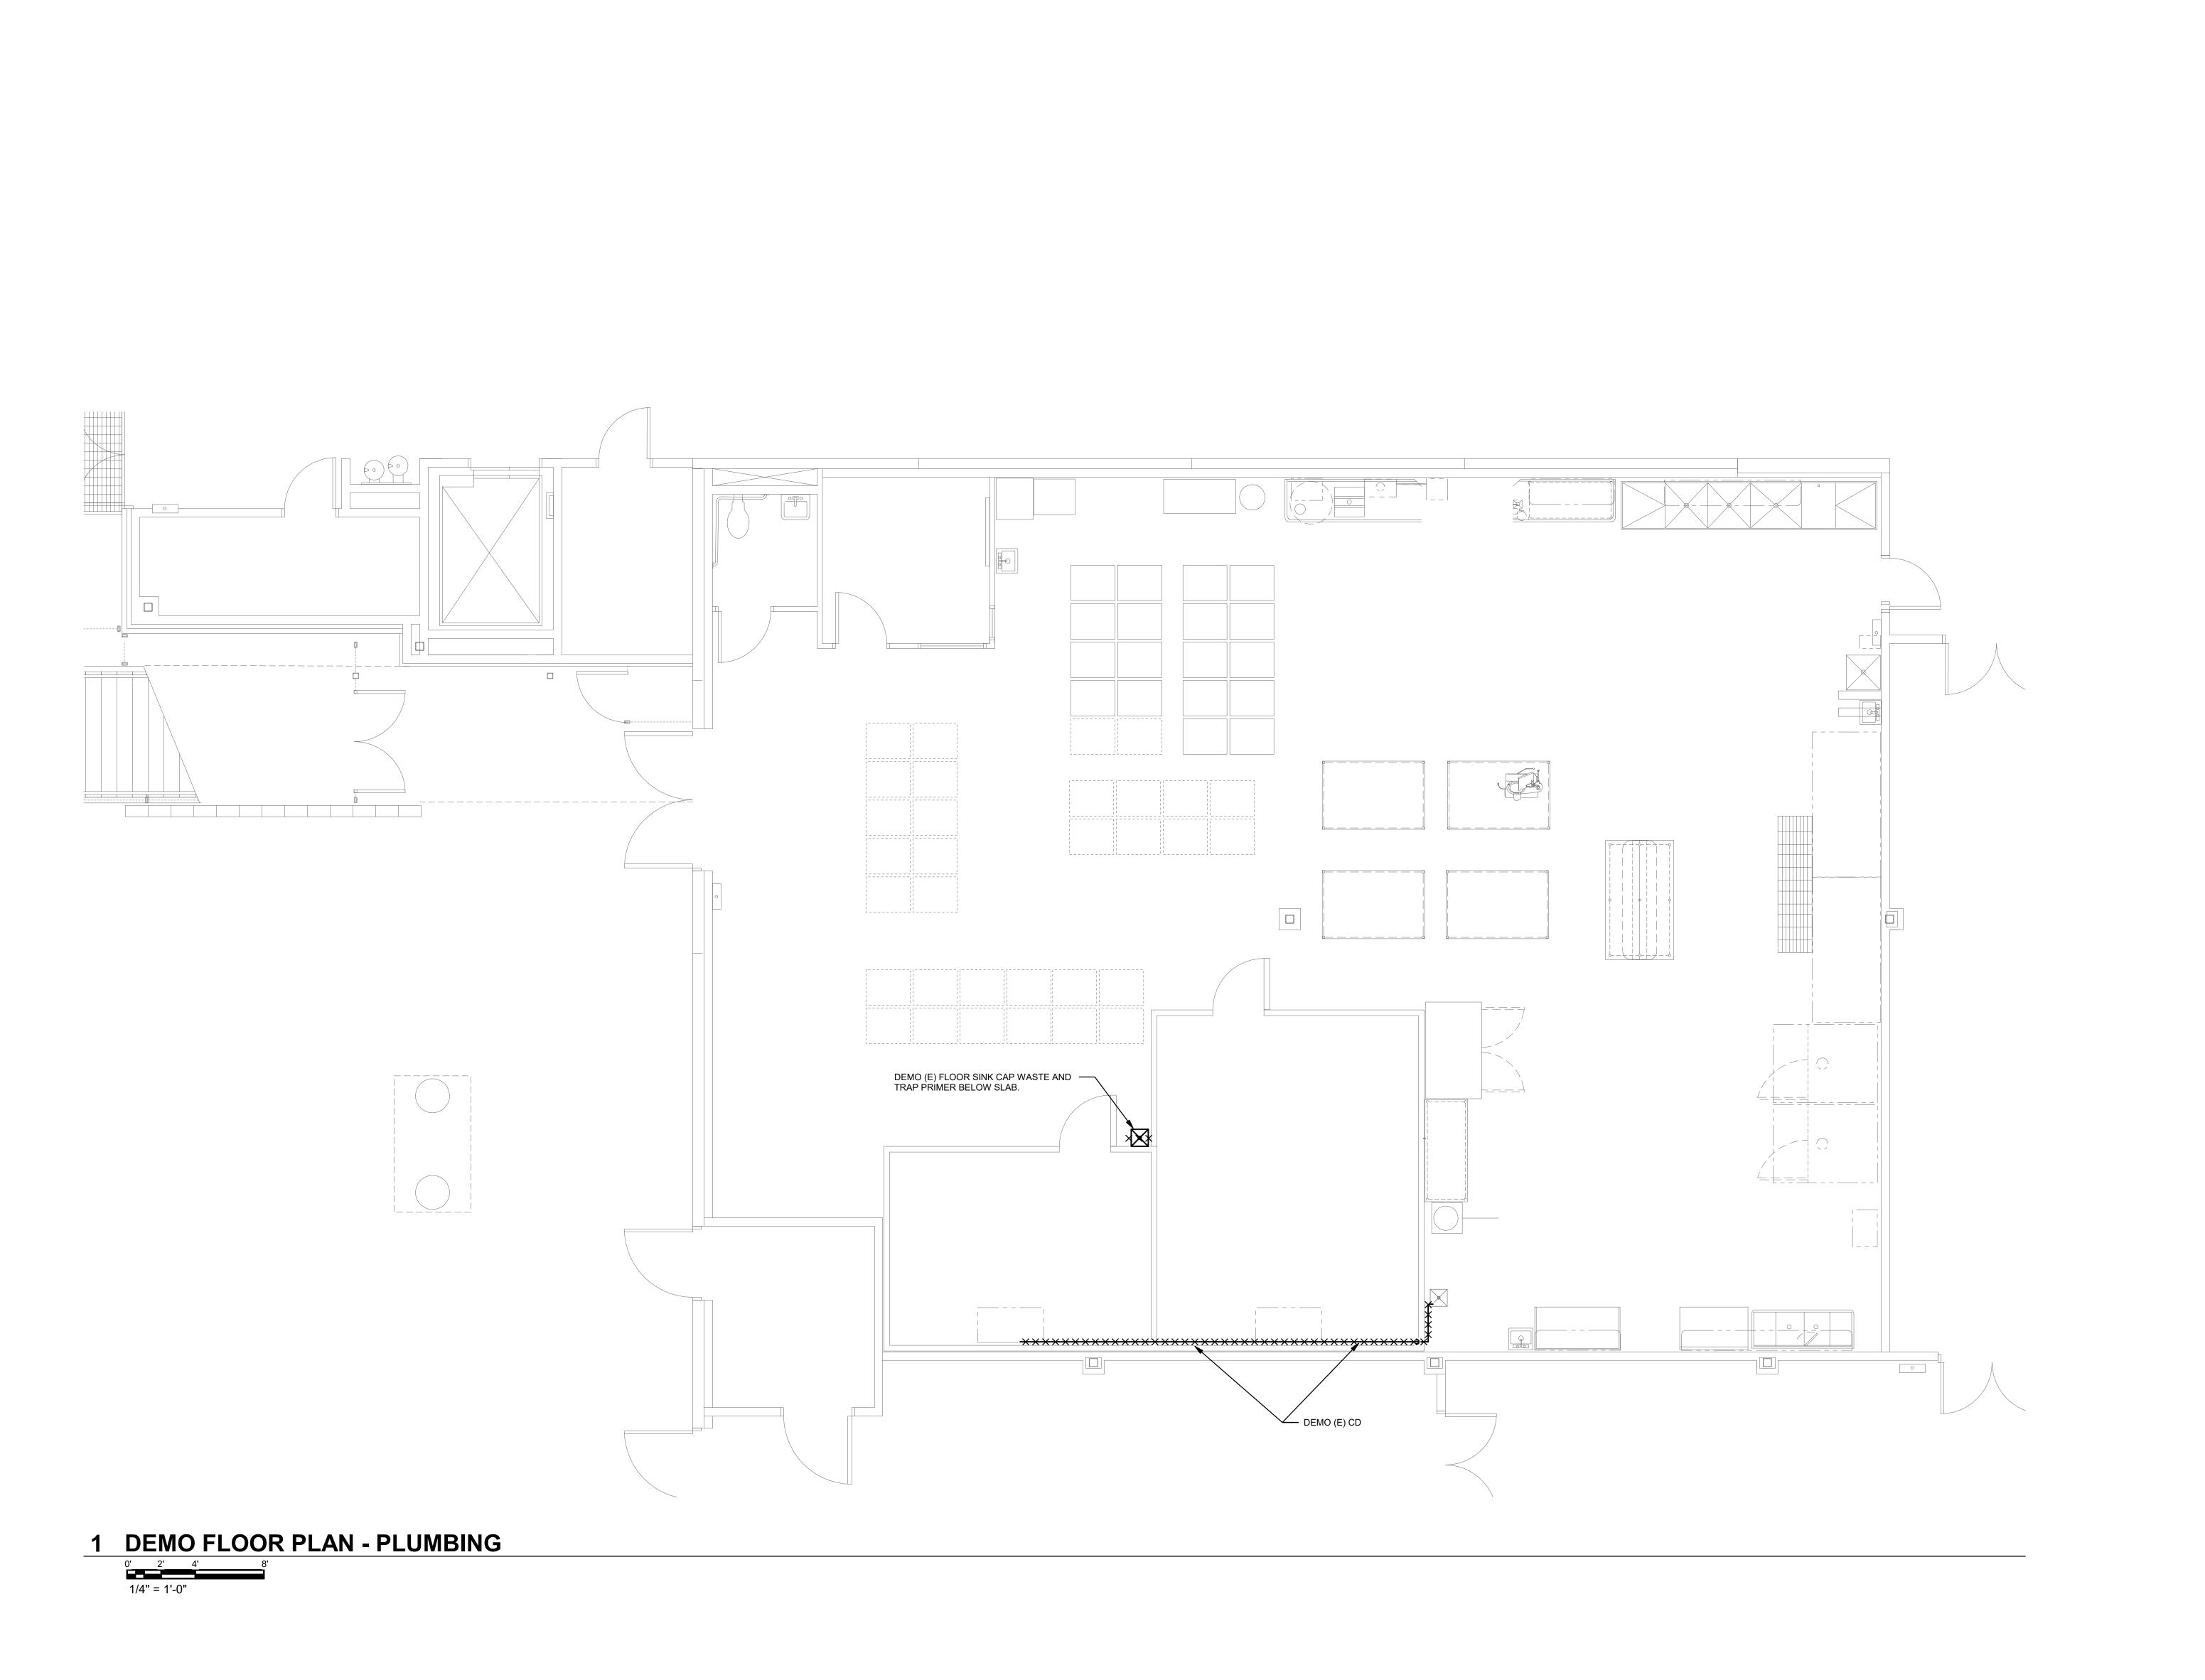

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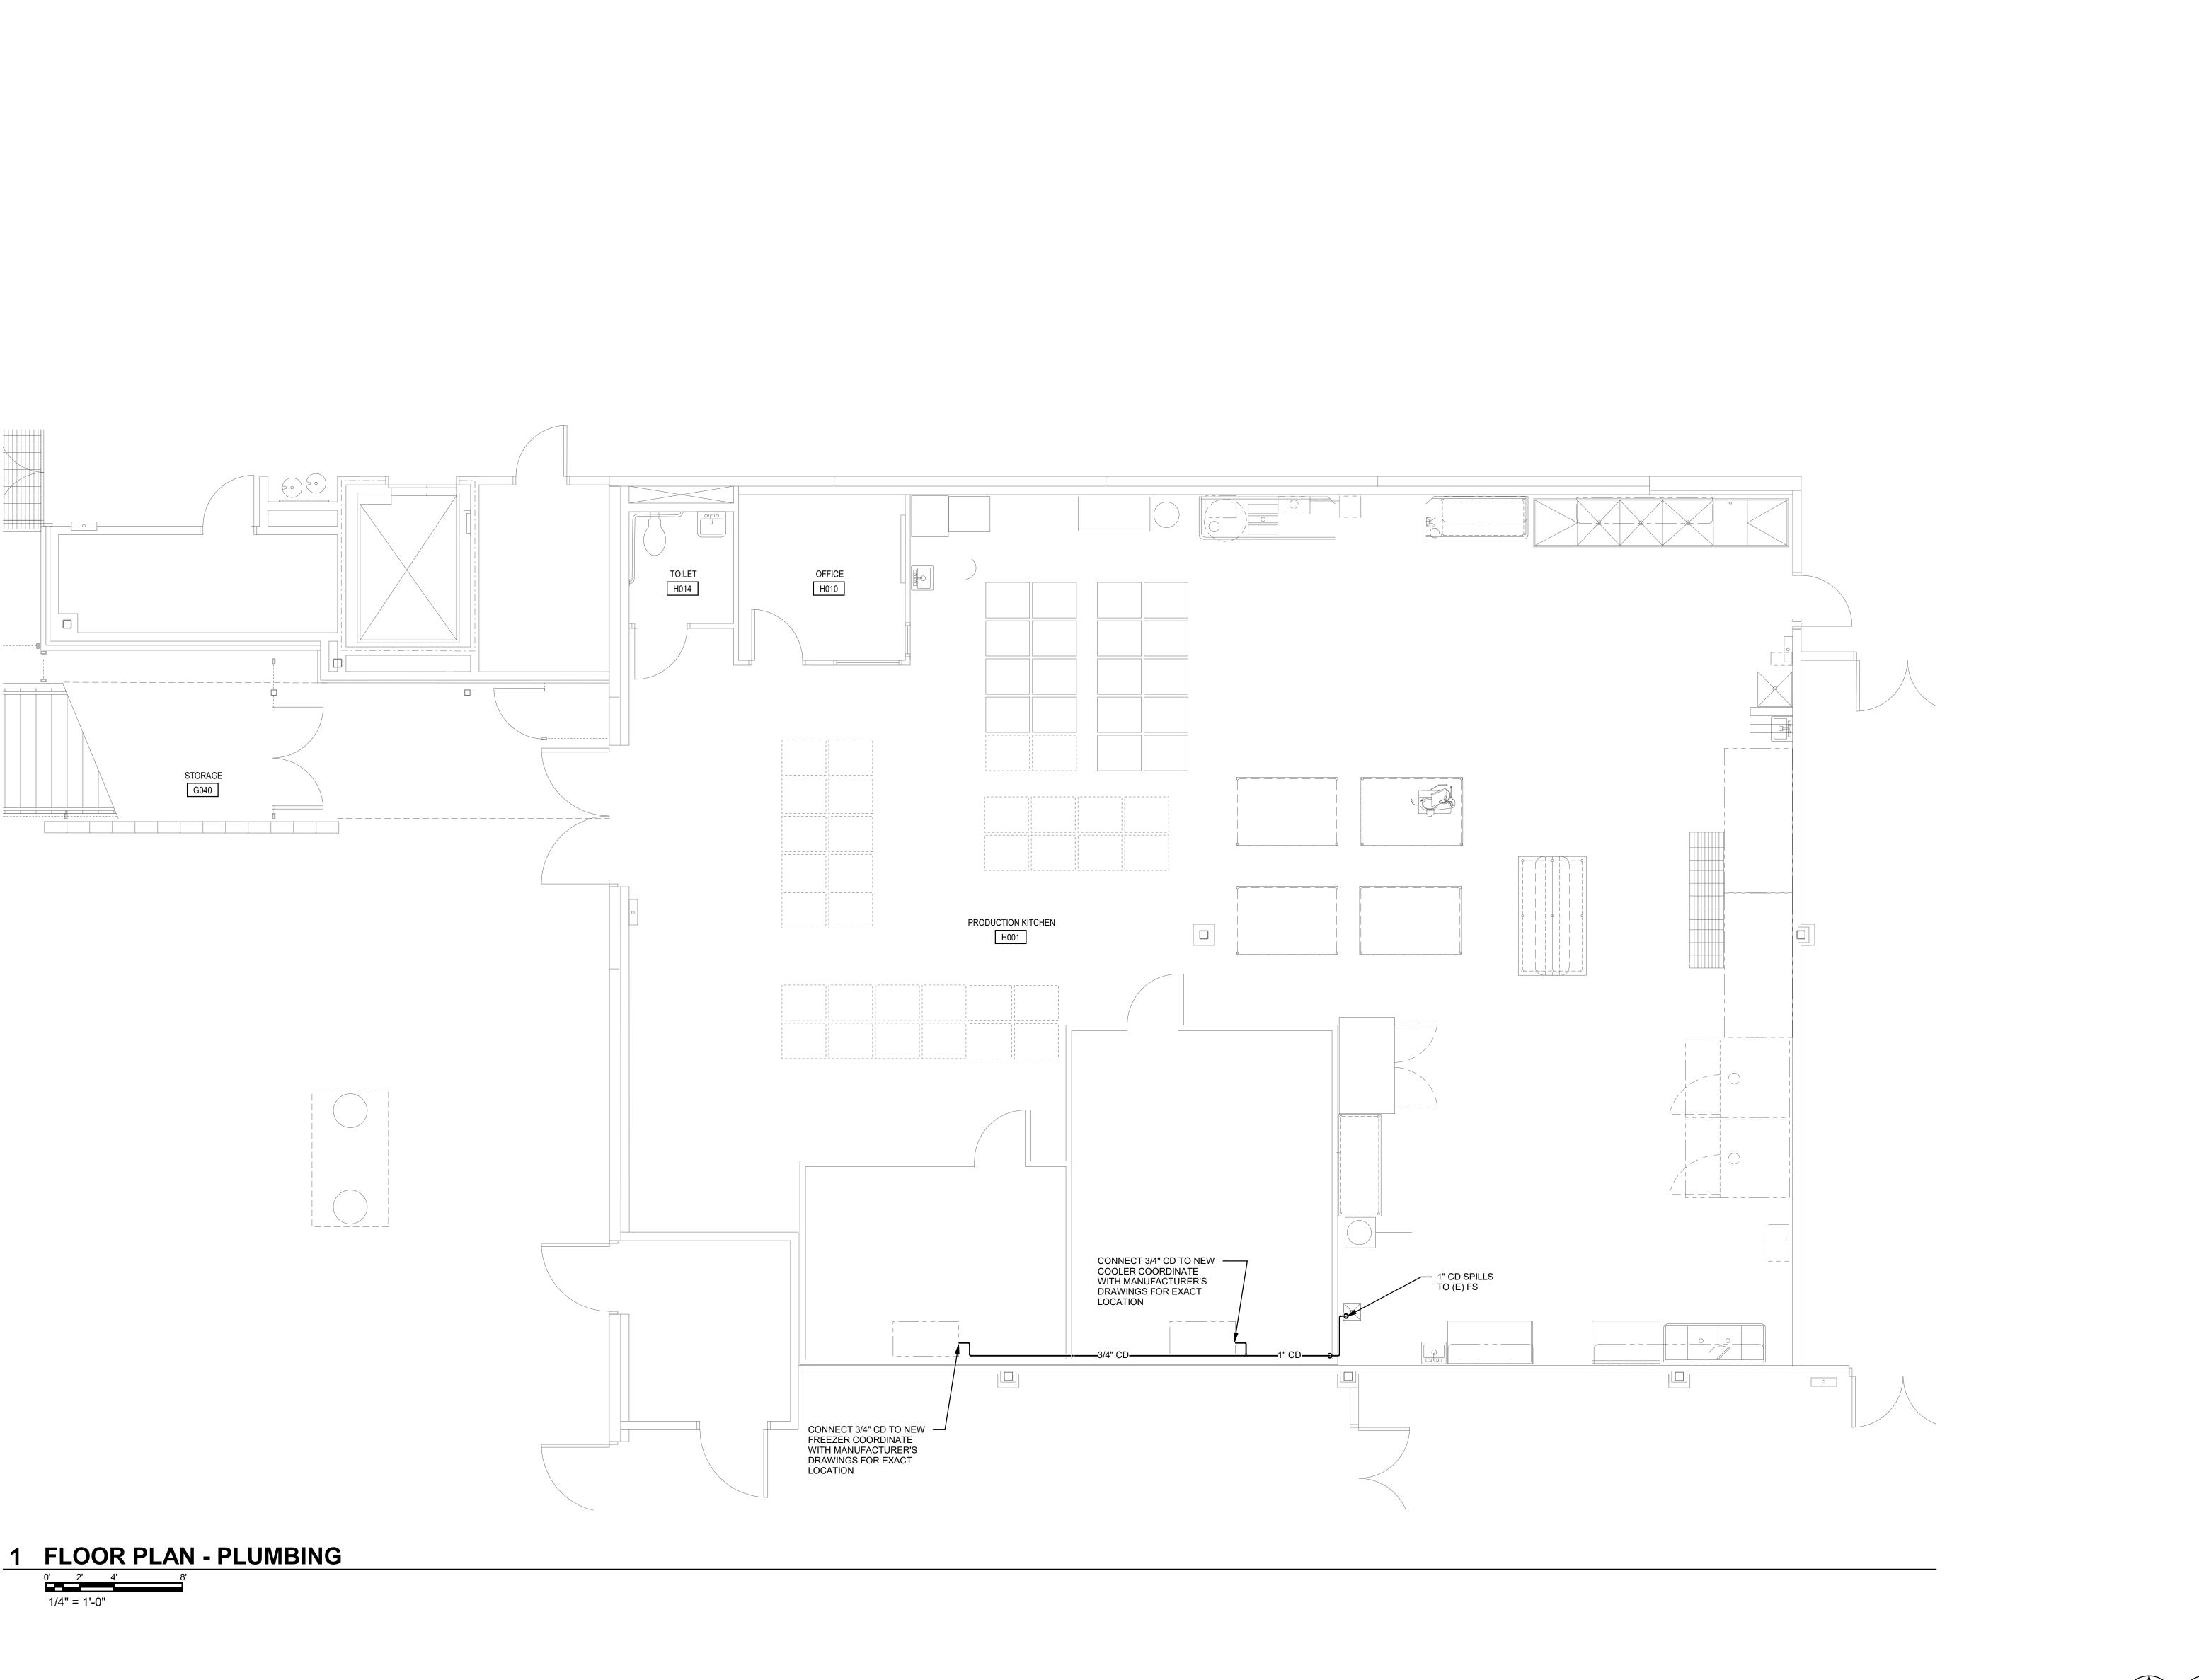
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SHEET TITLE

DEMO FLOOR PLAN
PLUMBING

SHEET NUMBER PD2.1



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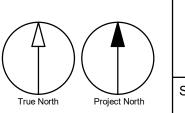
PROJECT NO:
Project Number

DRAWN BY:
TK

CHECKED BY:
JMM

PROJECT MGR: APPROVED BY: JMM

SHEET TITLE
FLOOR PLAN - PLUMBING



SHEET NUMBER P2.1

ISSUE 1

ELECTRICAL SYMBOL LIST

NOTE: This is a standard symbol list and not all items listed may be used.

14012. 11113 13 (a standard symbol list and not all items listed may be used.				
Abbreviation	DNS ABOVE FINISHED CEILING	<u>Connections</u>	/ Equipment	<u>Raceways</u>	
AFF	ABOVE FINISHED FLOOR	VFD	COMBINATION ADJUSTABLE FREQUENCY DRIVE WITH SAFETY DISCONNECT SWITCH		EXISTING CONDUIT CONCEALED IN WALL OR CEILING SPACE
AFG ARF	ABOVE FINISHED GRADE ABOVE RAISED FLOOR				
ANSI AWG	AMERICAN NATIONAL STANDARDS INSTITUTE AMERICAN WIRE GAUGE	\boxtimes	COMBINATION MOTOR STARTER/FUSED DISCONNECT SWITCH		EXISTING CONDUIT ROUTED BELOW FLOOR / GRADE
A AV	AMPERES, AMBER AUDIO VISUAL	F	HEAVY DUTY FUSED DISCONNECT SWITCH	—OP—	OVERHEAD PRIMARY SERVICE
AHJ	AUTHORITY HAVING JURISDICTION AVAILABLE INTERRUPTING CAPACITY	ш	HEAVY DOTT FOSED DISCONNECT SWITCH	—OF—	OVERHEAD PRIMART SERVICE
AIC BAS	BUILDING AUTOMATION SYSTEM	Ø	MOTOR CONNECTION	—от—	OVERHEAD TELEPHONE SERVICE
CA CAT	CABLE CATEGORY	7.5			
CLG CB	CEILING CIRCUIT BREAKER	다	NON-FUSED DISCONNECT SWITCH	—c—	UNDERGROUND CABLE TELEVISION SERVICE
С	CONDUIT, CLOSE, CONTROL				
CFCI CFOI	CONTRACTOR FURNISHED CONTRACTOR INSTALLED CONTRACTOR FURNISHED OWNER INSTALLED	0	CEILING MOUNTED JUNCTION BOX	—P—	UNDERGROUND PRIMARY SERVICE
COORD CU	COORDINATE COPPER	_			
dB (X)	DECIBEL DEMOLISH	IJ	FLOOR MOUNTED JUNCTION BOX	—s—	UNDERGROUND SECONDARY SERVICE
DTL	DETAIL	<u> P</u>	WALL-MOUNTED JUNCTION BOX	—т—	UNDERGROUND TELEPHONE SERVICE
DIA DIM	DIAMETER DIMENSION				
DIV DN	DIVISION DOWN	<u>General</u>			CONDUIT CONCEALED IN WALL OR CEILING SPACE
DWG EA	DRAWING EACH	$\left(\begin{array}{c} X \\ X \end{array}\right)$	DETAIL NUMBER AND SHEET LOCATION		
EMT	ELECTRICAL METALLIC TUBING				CONDUIT ROUTED BELOW FLOOR / GRADE
ENT ESD	ELECTRICAL NON-METALLIC TUBING ELECTROSTATIC DISCHARGE	LOCATION	EQUIPMENT IDENTIFICATION		
EL E	ELEVATION EMERGENCY	(W)	FOOD SERVICE EQUIPMENT / CALCULATION TAG	-	CONDUIT ELLED DOWN
EF (E)	EXHAUST FAN EXISTING	(XX)	FOOD SERVICE EQUIPMENT / CALCULATION TAG	0	CONDUIT ELLED UP
(E) FMS	FACILITY MANAGEMENT SYSTEMS	$\langle 1 \rangle$	KEYED NOTE		CONDOIT ELLED OF
FF FA	FINISH FLOOR FIRE ALARM			\longrightarrow	CONDUIT/WIRING CONTINUATION
FACP FMC	FIRE ALARM CONTROL PANEL FLEXIBLE METAL CONDUIT	AXXX	SECTION NUMBER AND SHEET LOCATION		
FT	FOOT, FEET			3	CONDUIT/WIRING STUBBED OUT WITH END CAP OR INSULATED PLASTIC BUSHING
FBO G, GND	FURNISHED BY OTHERS GROUND	—××-	DEMOLISH		
GFCI GFI	GROUND FAULT CIRCUIT INTERRUPTER GROUND FAULT INTERRUPTER			~~~~~	FLEXIBLE CONDUIT
GFP GE	GROUND FAULT PROTECTION GROUNDING EQUALIZER		EXISTING WORK	Switches and	d Receptacles
HH	HANDHOLE		NEW WORK		DUPLEX RECEPTACLE (MULTIPLE LETTERS INDICATE MULTIPLE OPTIONS)
HT HC	HEIGHT HORIZONTAL CROSS CONNECT	11.14			A = ABOVE COUNTER C = FLUSH CEILING MOUNTED
ID IN	IDENTIFICATION INCH, INCHES	<u>Lighting</u>		Ф	F = ARC FAULT PROTECTED BY BREAKER IN PANEL G = GROUND FAULT CIRCUIT INTERRUPTER B DENDANT MOUNTED WITH CORP. OF THE AREA OF
IEEE IMC	INSTITUTE OF ELECTRICAL AND ELECTRONICS ENGINEERS INTERMEDIATE METAL CONDUIT	\Box	EMERGENCY LUMINAIRE WITH BATTERY PACK		P = PENDANT MOUNTED WITH CORD GRIPS. VERIFY PENDANT LENGTH T = TAMPER RESISTANT SHUTTERED RECEPTACLE
IG	ISOLATED GROUND		EXIT SIGN CEILING MOUNTED, ARROW(S) INDICATES DIRECTION IF		W = WEATHERPROOF CONTINUOUS USE COVER, GFCI PROTECTED, WITH WEATHER-RESISTANT RECEPTACLE
KV KVA	KILOVOLT KILOVOLT AMPERES	፟	SHOWN		DOUBLE DUPLEX RECEPTACLE. SEE LETTER CODE LIST AT DUPLEX
KW LED	KILOWATT LIGHT EMITTING DIODE	₹	EXIT SIGN WALL MOUNTED, ARROW(S) INDICATES DIRECTION IF	#	RECEPTACLE FOR OPTIONS
LNC LFMC	LIQUID TIGHT FLEXIBLE NONMETALLIC CONDUIT LIQUIDTIGHT FLEXIBLE METAL CONDUIT	Y	SHOWN	Φ.	SINGLE RECEPTACLE. SEE LETTER CODE LIST AT DUPLEX
LV	LOW VOLTAGE		RECESSED 2' X 4' LUMINAIRE	Φ	RECEPTACLE FOR OPTIONS
MOCP MHz	MAXIMUM OVERCURRENT PROTECTION MEGAHERTZ			③	EQUIPMENT ELECTRICAL CONNECTION
mA MIN	MILLIAMPERES MINIMUM	오	WALL MOUNTED LUMINAIRE		SPECIAL PURPOSE RECEPTACLE. LETTER CODE DENOTES
MCA MISC	MINIMUM CIRCUIT AMPS MISCELLANEOUS	Miscellaneou	<u>IS</u>		RECEPTACLE CONFIGURATION LX-XXR = NEMA CONFIGURATION TWIST-LOCK RECEPTACLE
M	MOTOR		BRANCH CIRCUIT WIRING. ARROW INDICATES HOME RUN TO PANEL WITH CIRCUITS AS NOTED. WIRE SIZE IS #12 AWG MINIMUM	\otimes	X-XXR = NEMA CONFIGURATION STRAIGHT BLADE RECEPTACLE P = PENDANT MOUNT WITH CORD GRIPS. VERIFY PENDANT LENGTH
MCC MT, MTD	MOTOR CONTROL CENTER MOUNT, MOUNTED	#10	UNLESS NOTED OTHERWISE. SHORT TICK MARKS INDICATE PHASE CONDUCTORS. LONG TICK MARKS INDICATE NEUTRAL		X = COORDINATE RECEPTACLE CONFIGURATION WITH EQUIPMENT BEING SUPPLIED
MDU NEC	MULTI-DWELLING UNIT NATIONAL ELECTRIC CODE	B-27,29,31.	CONDUCTORS. A SINGLE CURVED TICK MARK INDICATES INSULATED GREEN GROUND CONDUCTOR. SECOND CURVED TICK	$\Phi_{\scriptscriptstyle P}$	PENDANT RECEPTACLE WITH CORD GRIPS. VERIFY PENDANT LENGTH. SEE LETTER CODE LIST AT DUPLEX RECEPTACLE FOR
NESC NEMA	NATIONAL ELECTRIC SAFETY CODE NATIONAL ELECTRICAL MANUFACTURERS ASSOCIATION		MARK INDICATES "ISOLATED GROUND" (GREEN INSULATION WITH YELLOW STRIPE) CONDUCTOR.	Ψ_{P}	OPTIONS
N	NEUTRAL NEW	_	BRANCH PANEL		SINGLE POLE SWITCH 2 = DOUBLE POLE SWITCH 3 = THREE-WAY SWITCH
(N) NC	NORMALLY CLOSED	-		\$	a THRU z (LOWERCASE) = LUMINAIRE CONTROL DESIGNATION L = LIGHTED HANDLE
NO N/A	NORMALLY OPEN NOT APPLICABLE		CIRCUIT BREAKER		M = MANUAL MOTOR STARTER WITH THERMAL OVERLOAD P = SWITCH WITH PILOT LIGHT
N.I.C. NTS	NOT IN CONTRACT NOT TO SCALE				W = WEATHERPROOF SWITCH
OC OSP	ON CENTER OUTSIDE PLANT	***	DRY TYPE TRANSFORMER		
OFCI	OWNER FURNISHED, CONTRACTOR INSTALLED		ELLICH MOUNT EQUIDMENT ENGLOCUSE ACNOTES		
OFOI PNL	OWNER FURNISHED, OWNER INSTALLED PANEL		FLUSH MOUNT EQUIPMENT ENCLOSURE AS NOTED		
PH PVC	PHASE POLY-VINYL-CHLORIDE	_	FLUSH WALL MOUNTED BRANCH PANEL		
PWR QTY	POWER QUANTITY				
REF	REFERENCE	GB	GROUND BAR		
(R) RFI	RELOCATE REQUEST FOR INFORMATION				
REQD RMC	REQUIRED RIGID METAL CONDUIT		GROUNDING POINT		
RM SHT	ROOM SHEET		MAIN DISTRIBUTION DANIEL / CUID DISTRIBUTION DANIEL		
SIM SPKR	SIMILAR SPEAKER		MAIN DISTRIBUTION PANEL / SUB DISTRIBUTION PANEL		
STD	STANDARD	O ^{PP}	POWER UTILITY POLE		
SPD SWBD	SURGE PROTECTION DEVICE SWITCHBOARD	O			
TBB TGB	TELECOMMUNICATIONS BONDING BACKBONE TELECOMMUNICATIONS GROUNDING BUS BAR	VC	SUBGRADE VAULT CATV		
TTB TBD	TELEPHONE TERMINAL BOARD TO BE DETERMINED	alan seri			
XFMR	TRANSFORMER	VP	SUBGRADE VAULT POWER		
TVSS TP	TRANSIENT VOLTAGE SURGE SUPPRESSOR TRANSITION POINT	VT	SUBGRADE VAULT TELEPHONE		
TYP UG	TYPICAL UNDERGROUND	[84]	CODOINDE VAULI ILLETIIUNE		
UL UPS	UNDERWRITERS LABORATORIES UNINTERRUPTIBLE POWER SUPPLY		SURFACE MOUNT EQUIPMENT ENCLOSURE AS NOTED		
UON	UNLESS OTHERWISE NOTED				
VFD VRFY	VARIABLE FREQUENCY DRIVE VERIFY	O ^{TP}	TELEPHONE UTILITY POLE		
V WP	VOLTS, VOLTAGE WEATHERPROOF	gened.			
WG W	WIRE GUARD WIRE, WHITE	UT	UTILITY TRANSFORMER PAD/VAULT		
W/ W/O	WITH WITHOUT				
WAO	WORK AREA OUTLET				

GENERAL ELECTRICAL NOTES

A. CONSULT ALL DRAWINGS AND SPECIFICATIONS IN THIS PROJECT AND BECOME FAMILIAR WITH ALL EQUIPMENT TO BE INSTALLED. COORDINATE ALL ASPECTS OF THE CONTRUCTION WITH THE OTHER TRADES ON THE JOB TO ENSURE THAT ALL WORK AND MATERIALS REQUIRED PROVIDE A COMPLETE AND OPERATIONAL FACILITY ARE INCLUDED IN THE BID.

Beaverton School District

BEAVERTON

BEAVERTON SCHOOL DISTRICT 16550 SW Merlo Rd. OR 97003

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No.DESCRIPTIONDATE1BID DOCUMENTS06-06-2022

CONSULTANTS



PROJECT 2022-0525

CONTACT KRISTINE LEAVENS

100 SW Main Street, Suite 1600
Portland, OR 97204

TEL 503.382.2266

www.interfaceengineering.com

SHEET INDEX

E0.1 SYMBOL LIST AND GENERAL NOTES - ELECTRICAL

ED2.1 DEMO FLOOR PLAN - ELECTRICAL

E2.1 FLOOR PLAN - ELECTRICAL

E6.1 SCHEDULES - ELECTRICAL

SELECT CONSULTANT TYPE

BI GROUP
907 SW Harvey Milk Street
Portland, OR 97205, USA
tel 503 226 6950 fax 503 273 9192
ibigroup-edpnw.com

PROJECT
BSD Southridge HS Freezer
Replacement
16550 SW Merlo Rd. OR 97003

PROJECT NO:
Project Number

DRAWN BY:
KCL
MKO

PROJECT MGR:
KCL
MKO

PROJECT MGR:
KCL
MKO

SHEET TITLE
SYMBOL LIST AND GENERAL
NOTES - ELECTRICAL

ISSUE

1

EXPIRES: 12/31/22

○ SHEET KEYNOTES

 BID ALTERNATE TO RELOCATE PENDANT RECEPTACLE FOR HEATED CABINET. (ALTERNATE #1)

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INTERFACE ENGINEERING

PROJECT 2022-0525 CONTACT KRISTINE LEAVENS 100 SW Main Street, Suite 1600 Portland, OR 97204 TEL 503.382.2266 www.interfaceengineering.com

EXPIRES: 12/31/22

IBI GROUP
907 SW Harvey Milk Street
Portland, OR 97205, USA
tel 503 226 6950 fax 503 273 9192
ibigroup-edpnw.com


BSD Southridge HS Freezer Replacement 16550 SW Merlo Rd. OR 97003

PROJECT NO: Project Number CHECKED BY: APPROVED BY: PROJECT MGR:

SHEET TITLE

DEMO FLOOR PLAN
ELECTRICAL

SHEET NUMBER ED2.1

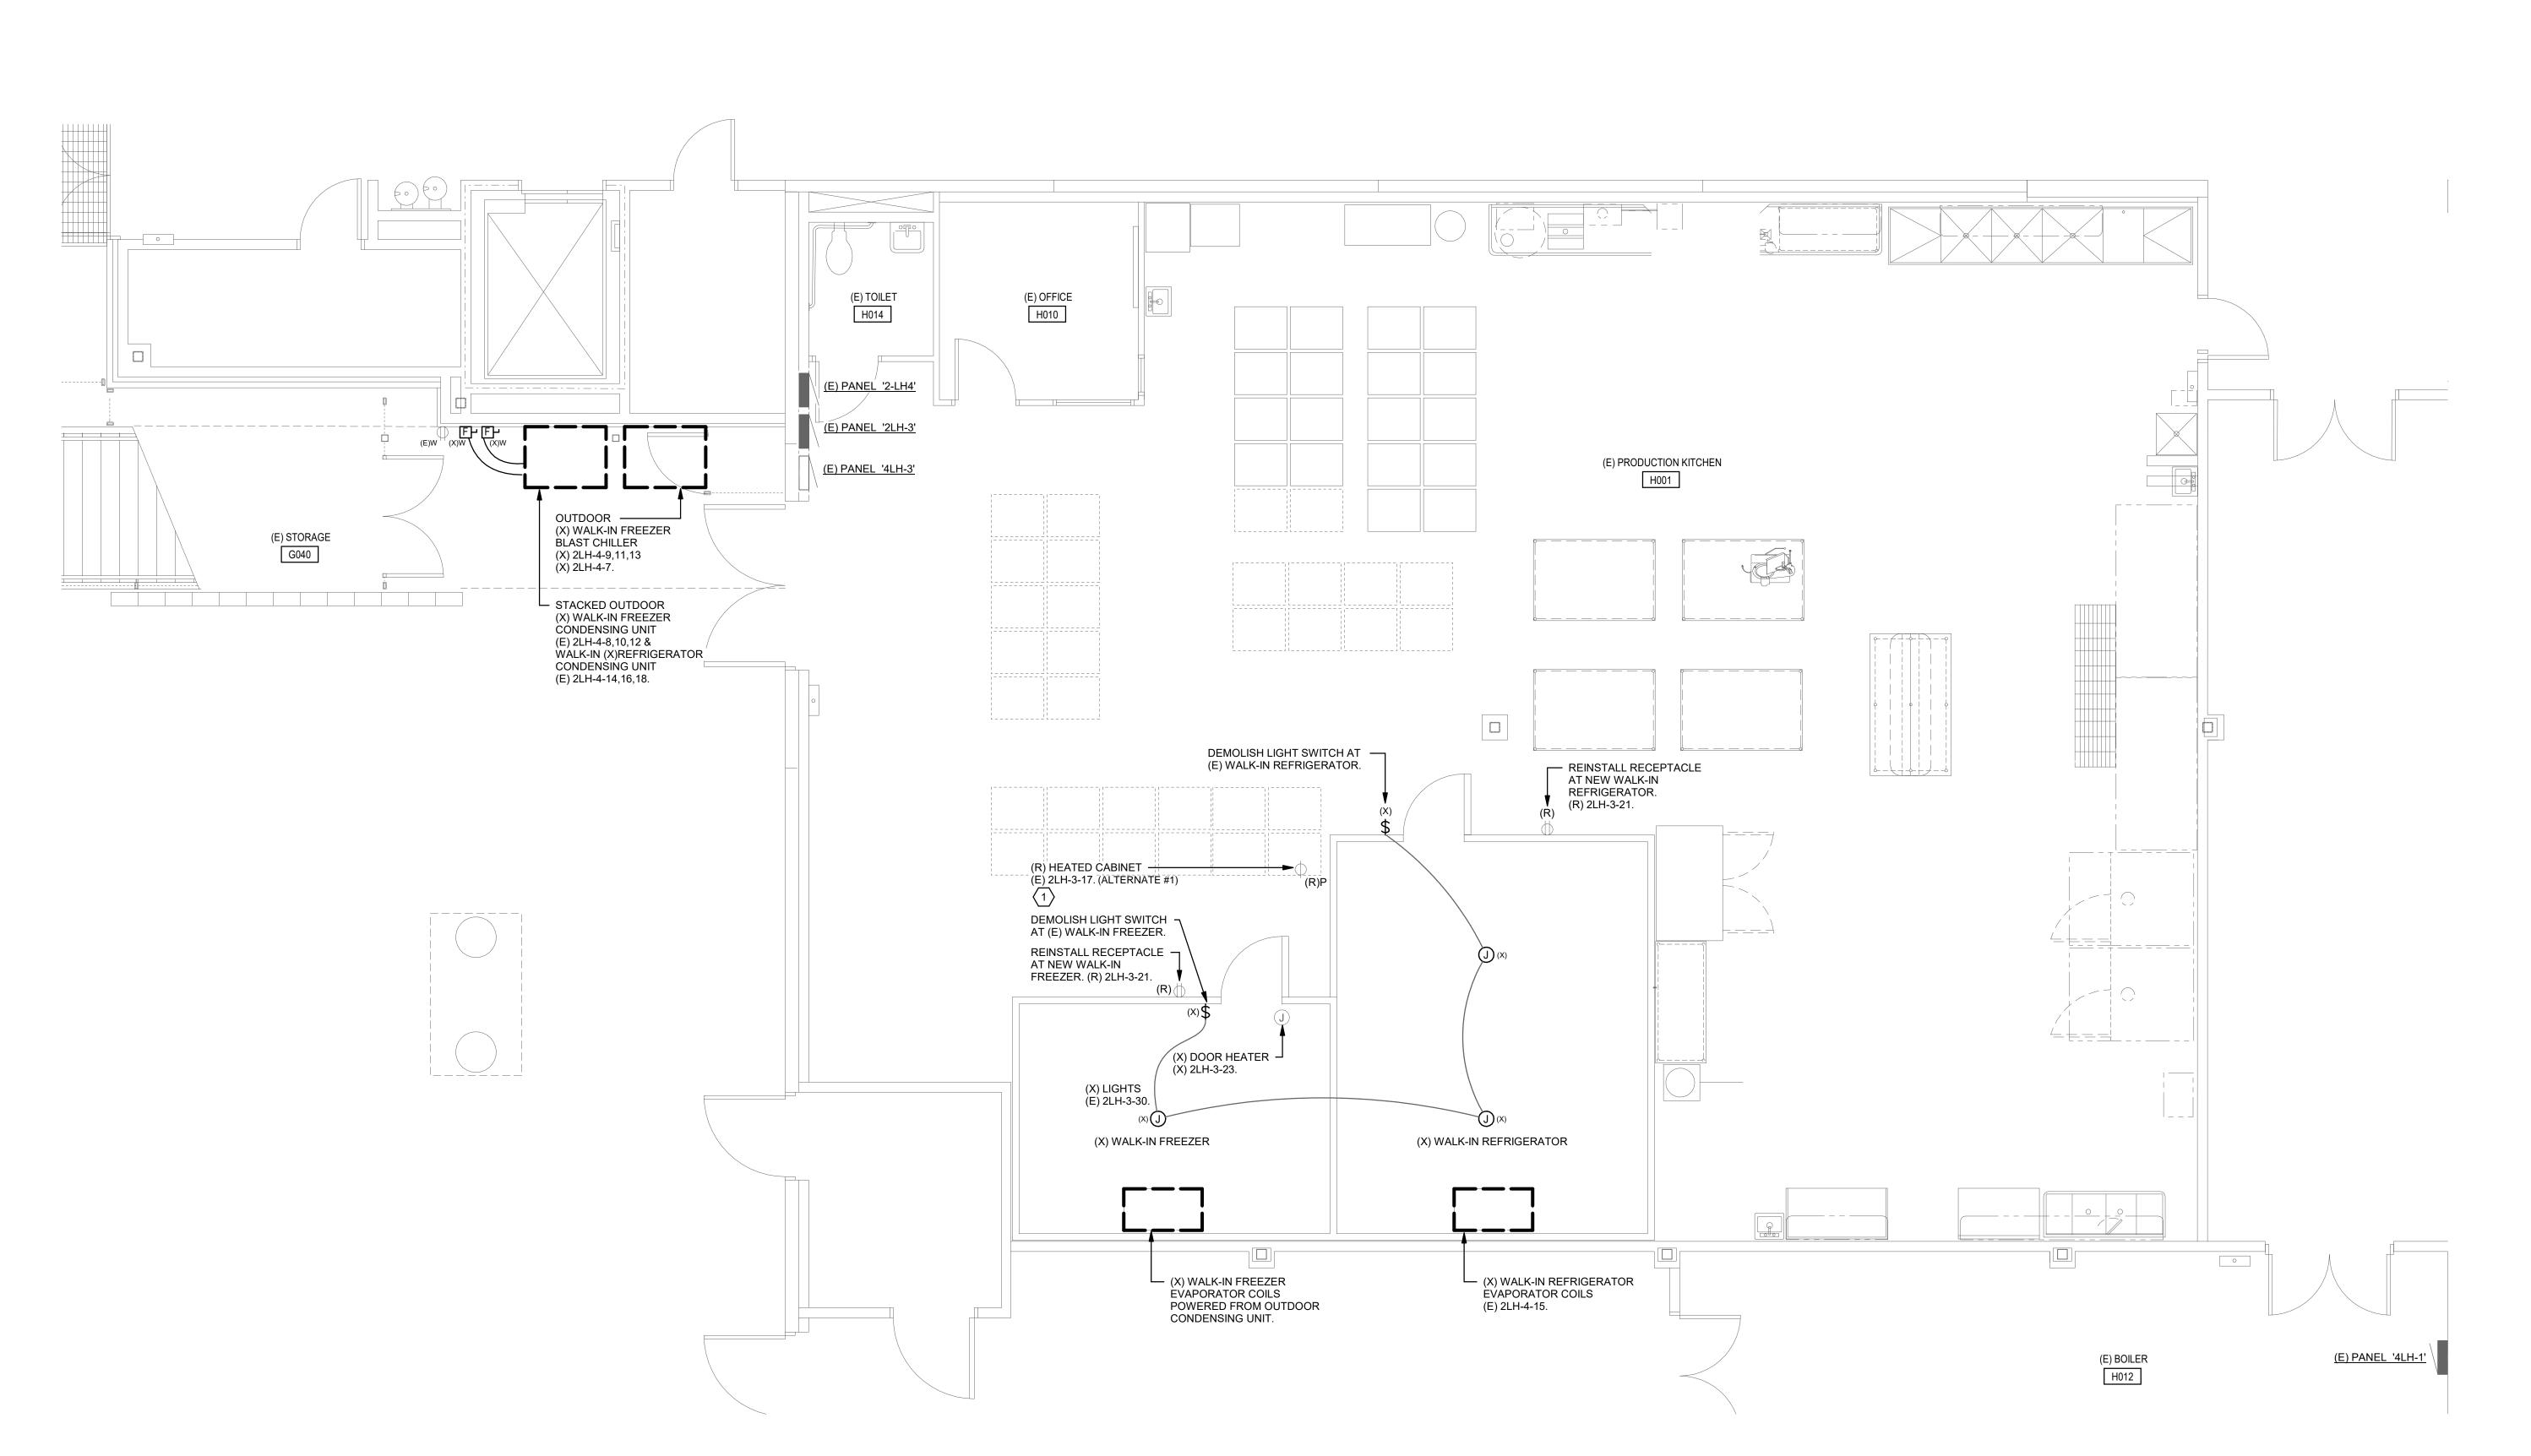

DEMO FLOOR PLAN - ELECTRICAL

0' 2' 4' 8'

GENERAL ELECTRICAL NOTES

A. ROUTE ALL RACEWAY SERVING NEW WALK-IN FREEZER AND COOLER ALONG OUTSIDE OF UNITS AND STUB-IN ONLY AT EQUIPMENT CONNECTION LOCATIONS. SEAL ALL PENETRATIONS PER MANUFACTURER REQUIREMENTS.

○ SHEET KEYNOTES

- 1. UTILIZE EXISTING WIRING AND RACEWAY SERVING WALK-IN FREEZER CONDENSING UNIT FROM CIRCUIT 2LH-4-8,10,12 TO SERVE NEW CONDENSING UNIT.
- 2. UTILIZE EXISTING WIRING AND RACEWAY SERVING WALK-IN REFRIGERATOR CONDENSING UNIT FROM CIRCUIT 2LH-4-14,16,18 TO SERVE NEW CONDENSING UNIT.
- 3. UTILIZE EXISTING WIRING AND RACEWAY SERVING WALK-IN FREEZER / WALK-IN REFRIGERATOR LIGHTING FROM CIRCUIT 2LH-3-30 TO SERVE NEW
- 4. BID ALTERNATE TO RELOCATE PENDANT RECEPTACLE FOR HEATED CABINET. (ALTERNATE #1)

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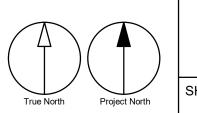
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Portland, OR 97205, USA
tel 503 226 6950 fax 503 273 9192
ibigroup-edpnw.com


BSD Southridge HS Freezer Replacement 16550 SW Merlo Rd. OR 97003

PROJECT NO: Project Number CHECKED BY:

PROJECT MGR: APPROVED BY:

SHEET TITLE
FLOOR PLAN - ELECTRICAL



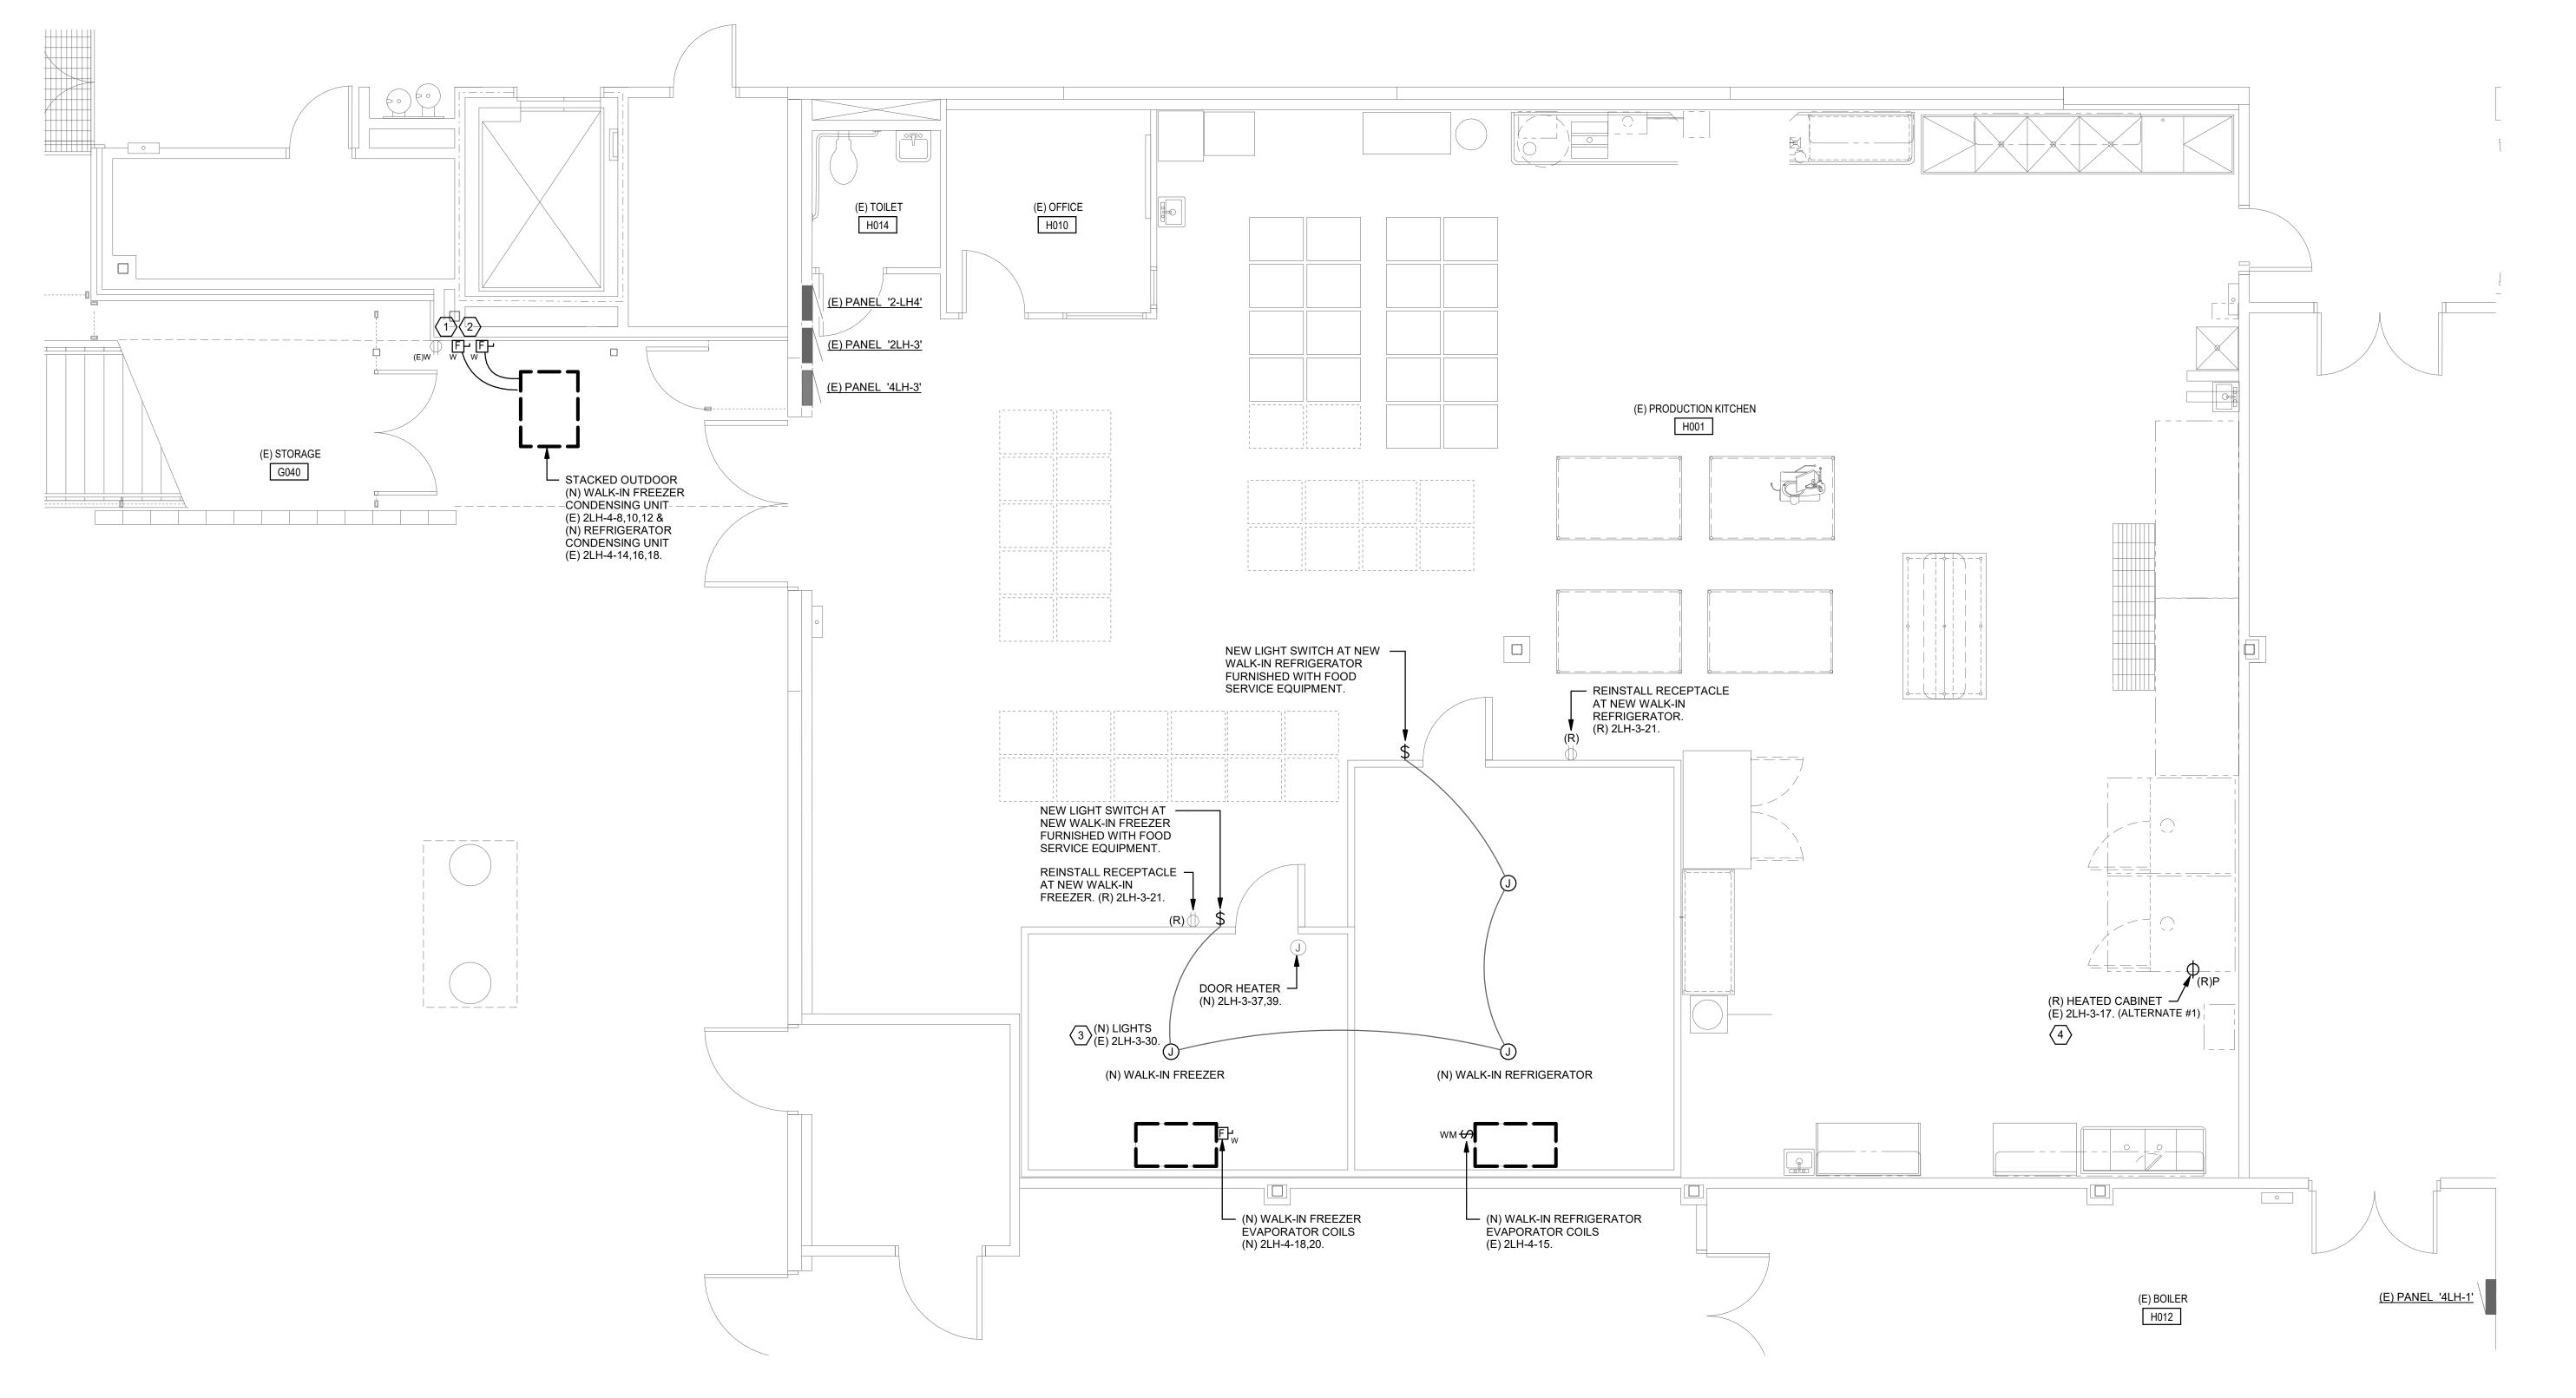

1 FLOOR PLAN - POWER

0' 2' 4' 8' 1/4" = 1'-0"

			,									2022	2-052
	(E/X) Panel '2LH-3'	120/208V	′, 3 Ph., 4	W.;	250A	Bus v	with Ma	in Lug On	ly Flush Mo	ounted Panelboar	^r d		
Ckt.		Load	C.	В.				C.B.	Load				CI
No.	Description / Location	(VA) Typ	pe A/P	ole	Note	Ph.	Note	A/Pole	(VA) Typ	e Description /	Location		Ν
1	(E) BOOSTER, HEATER		20	/1		Α		20/2		(E) ICE STAT	ION		
3	(E) STEAM KETTLE		20	/3		В		-					1
5			-			С		20/2		(E) ICE STAT	ION		1
7			-			Α		-					1
9	(E) COMBI CONV. OVENS		20	/3		В		15/3		(E) MIXER			1
11			-			С		-				,	1
13			-			Α		-					1
15	(E) HEATED CABINETS		20	/1		В		20/1		(E) SLICER			1
17	(E) HEATED CABINETS		20	/1		С		20/1		(E) HEATED	CABINETS	,	1
19	(E) HEATED CABINETS		20	/1		Α		20/1		(E) HEATED	CABINETS		2
21	(E) RECP - PROD. KITCHEN		20	/1		В		20/1		(E) HEATED	CABINETS		2
23	(X) WALK-IN DOOR HEATER		20	/1		С		20/1		(E) HEATED	CABINETS		2
25	(E) RECP - PROD. KITCHEN		20	/1		Α		20/1		(E) HEATED	CABINETS		2
27	(E) RECP - PROD. KITCHEN		20	/1		В		20/1		(E) HEATED	CABINETS		2
29	(E) LTS - HOOD LIGHTS		20	/1		С		20/1		(X) LTS - WA	LK-IN FREEZER	R/FRIDGE	3
31	(E) RECP - FIRE SUPPRESSION		20	/1		A		20/1		(E) WASHER			3
33	(E) RACK OVENS		20	/1		В		20/1		(E) SPARE			3
35	(E) RACK OVENS		20	/1		С		30/2		(E) DRYER			3
37	(X) BUSSED SPACE					Α		-					3
39	(X) BUSSED SPACE					В				(E) BUSSED	SPACE		4
41	(E) BUSSED SPACE					С				(E) BUSSED	SPACE		4
Total	Connected Load: Ph. A	0 \	<u> </u>	0 4	Amps		•		Panel Co	nnected Load:	0.0 KVA	0.0 Amps	
Total	Connected Load: Ph. B	0 \	VΑ	0 4	Amps			S		nnected Load:	0.0 KVA	0.0 Amps	
Total	Connected Load: Ph. C	0 \		0 4	Amps					emand Load:	0.0 KVA	0.0 Amps	

	(E/X) Panel '2LH-4'	120/208V, 3	Ph., 4 W.;	; 250A	Bus	with Ma	in Lug On	ly Flush Mou	20: nted Panelboard	22-0525
Ckt.	<u>(</u>	Load	C.B.				C.B.	Load		Ckt.
No.	Description / Location	(VA) Type	A/Pole	Note	Ph.	Note	A/Pole	(VA) Type	Description / Location	No.
1	(E) CIRC. PUMP		20/1		Α		40/3		(X) REFRIGERATOR COMP/COND	2
3	(E) RECEPTACLES		20/1		В		-			4
5	(E) REC-SHOP		20/1		С		-			6
7	(X) BLAST CHILLER		20/1		Α		40/3		(X) FREEZER COMP/COND	8
9	(X) BLAST CHILLER REMOTE		20/3		В		-			10
11			-		С		ı			12
13			-		Α		30/2		(E) PROOFER	14
15	(X) WALK-IN COIL FANS		20/1		В		-			16
17	(E) SP-1		20/1		С				(E) BUSSED SPACE	18
19	(E) EWC-1, (E) EF-15, (E) CUH-GL-1		20/1		Α				(E) BUSSED SPACE	20
21	(E) EF-28		20/1		В				(E) BUSSED SPACE	22
23	(E) EF-32 (BOOSTER FAN)		20/1		С				(E) BUSSED SPACE	24
25	(E) EF-34		20/1		Α				(E) BUSSED SPACE	26
27	(E) EF-33		20/1		В				(E) BUSSED SPACE	28
29	(E) EF-23		20/1		С				(E) BUSSED SPACE	30
31	(E) RECEPTACLE - POS		20/1		Α				(E) BUSSED SPACE	32
33	(E) IN-USE CIRCUIT		20/1		В				(E) BUSSED SPACE	34
35	(E) BUSSED SPACE				С				(E) BUSSED SPACE	36
	(E) BUSSED SPACE				Α				(E) BUSSED SPACE	38
39	(E) BUSSED SPACE				В				(E) BUSSED SPACE	40
41	(E) BUSSED SPACE				С				(E) BUSSED SPACE	42
Total	Connected Load: Ph. A	0 VA	0	Amps	_			Panel Conr	nected Load: 0.0 KVA 0.0 Amps	-
Total	Connected Load: Ph. B	0 VA	0	Amps			S	Sub-Fed Conr	nected Load: 0.0 KVA 0.0 Amps	
Total	Connected Load: Ph. C	0 VA	0	Amps					mand Load: 0.0 KVA 0.0 Amps	

Ckt.		Load	l	C.B.				C.B.	Load			Cł
No.	Description / Location	(VA) Ty	ре	A/Pole	Note	Ph.	Note	A/Pole	(VA) Ty	ре	Description / Location	N
1	(E) BOOSTER, HEATER			20/1		Α		20/2			(E) ICE STATION	
3	(E) STEAM KETTLE			20/3		В		-				
5				-		С		20/2			(E) ICE STATION	
7				-		Α		-				
9	(E) COMBI CONV. OVENS			20/3		В		15/3			(E) MIXER	Τ.
11				-		С		-				
13				-		Α		-				Γ.
15	(E) HEATED CABINETS			20/1		В		20/1			(E) SLICER	
17	(E) HEATED CABINETS			20/1		С		20/1			(E) HEATED CABINETS	
19	(E) HEATED CABINETS			20/1		Α		20/1			(E) HEATED CABINETS	
21	(E) RECP - PROD. KITCHEN			20/1		В		20/1			(E) HEATED CABINETS	
23	(N) SPARE			20/1		С		20/1			(E) HEATED CABINETS	
25	(E) RECP - PROD. KITCHEN			20/1		Α		20/1			(E) HEATED CABINETS	
27	(E) RECP - PROD. KITCHEN			20/1		В		20/1			(E) HEATED CABINETS	
29	(E) LTS - HOOD LIGHTS			20/1		С		20/1	300	L	(N) LTS - WALK-IN FREEZER/FRIDGE	
31	(E) RECP - FIRE SUPPRESSION			20/1		Α		20/1			(E) WASHER	
33	(E) RACK OVENS			20/1		В		20/1			(E) SPARE	
35	(E) RACK OVENS			20/1		С		30/2			(E) DRYER	
37	(N) WALK-IN FREEZER DOOR HTR	1,425		20/2	1	Α		-				
39		1,425	Н	-		В					(E) BUSSED SPACE	┸.
41	(E) BUSSED SPACE					С					(E) BUSSED SPACE	
Total	Connected Load: Ph. A	1,425	VA	12	Amps	-		-	Panel C	onn	ected Load: 3.2 KVA 8.7 Amps	
Total	Connected Load: Ph. B	1,425	VA	12	Amps			S	Sub-Fed C	onn	ected Load: 0.0 KVA 0.0 Amps	
Total	Connected Load: Ph. C	300	VA	2	Amps				Total	Den	nand Load: 3.2 KVA 9.0 Amps	

Ckt.		Load	t	C.B.				C.B.	Load	1		Cł
No.	Description / Location	(VA) Ty	/ре	A/Pole	Note	Ph.	Note	A/Pole	(VA) Ty	/ре	Description / Location	Ν
1	(E) CIRC. PUMP			20/1		Α	1	20/3	1,190	М	(N) REFRIGERATOR CONDENSING UNIT	
3	(E) RECEPTACLES			20/1		В		-	1,190	М		٦,
5	(E) REC-SHOP			20/1		С		-	1,190	М		
7	(N) SPARE			20/1		Α	1	30/3	2,268	М	(N) FREEZER CONDENSING UNIT	
9	(N) SPARE			20/3		В		-	2,268	М	 	1
11				-		С		-	2,268	М		1
13				-		Α		30/2			(E) PROOFER	•
15	(N) WALK-IN REFRIGERATOR COIL FANS	324	М	20/1		В		-				1
17	(E) SP-1			20/1		С	1	20/2	156	М	(N) WALK-IN FREEZER EVAP. COIL FAN	1
19	(E) EWC-1, (E) EF-15, (E) CUH-GL-1			20/1		Α		-	156	М		1
21	(E) EF-28			20/1		В					(E) BUSSED SPACE	1
23	(E) EF-32 (BOOSTER FAN)			20/1		С					(E) BUSSED SPACE	1
25	(E) EF-34			20/1		Α					(E) BUSSED SPACE	
27	(E) EF-33			20/1		В					(E) BUSSED SPACE	
29	(E) EF-23			20/1		O					(E) BUSSED SPACE	
31	(E) RECEPTACLE - POS			20/1		Α					(E) BUSSED SPACE	- ;
33	(E) IN-USE CIRCUIT			20/1		В					(E) BUSSED SPACE	,
35	(E) BUSSED SPACE					O					(E) BUSSED SPACE	• •
37	(E) BUSSED SPACE					Α					(E) BUSSED SPACE	_ ;
39	(E) BUSSED SPACE					В					(E) BUSSED SPACE	4
41	(E) BUSSED SPACE					С					(E) BUSSED SPACE	4
Total	Connected Load: Ph. A	3,614	VA	30	Amps				Panel C	Conn	ected Load: 11.0 KVA 30.6 Amps	
Total	Connected Load: Ph. B	3,782	VA	31	Amps			S	Sub-Fed C	Conn	ected Load: 0.0 KVA 0.0 Amps	
T-4-1	Connected Load: Ph. C	3,614	۱/Δ	30	Amps				Total	Den	mand Load: 12.7 KVA 35.3 Amps	



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SCHEDULES - ELECTRICAL

SHEET NUMBER E6.1

.1